

August 29, 2025 Sign & Streetery Committee 1515 Arch Street, 13th Floor Philadelphia, PA 19102

RE: Mann Center for the Performing Arts - Entry Plaza and Welcome Center Project

Dear Members of the Philadelphia Sign & Streetery Committee:

The Mann Center for the Performing Arts (The Mann Center) respectfully requests to be added to the agenda for the Philadelphia Streets and Signage Committee meeting scheduled for September 17, 2025. In April 2025, we presented and received approval on the Centennial Wall East digital display, a part of our Entry Plaza reimagination project, and noted we would present the larger signage package for this project in the future once the design was ready. We are now seeking the Committee's approval of this signage package for our Entry Plaza Expansion and Welcome Center Project.

The Mann Center, a not-for-profit outdoor performance center located in Philadelphia's Fairmount Park, has been serving the community since 1976. As part of our commitment to enhancing the visitor experience and accommodating our growing audience of over 200,000 patrons annually, The Mann Center is committed to significant improvements to our entry plaza and the addition of a new welcome center. Partial construction activities have begun, with the bulk of construction activities commencing at the close of the season in October 2025. The project has a targeted completion by the opening of the 2026 season, which coincides with both the 50th anniversary of the Mann Center and the 250th anniversary of the United States of America.

The design team at Merje has developed plans in alignment with our Master Plan, specifically the Entry Plaza Expansion and Welcome Center Project which was unanimously approved by the Art Commission in March 2025. We look forward to presenting the detailed designs and answering any questions during the September 17<sup>th</sup> meeting.

Thank you for your consideration of this request. Please confirm our placement on the agenda at your earliest convenience. Should you have any questions prior to the meeting on the 17th, please reach out to our partners at Aegis.

Sincerely,

Catherine M. Cahill President & CEO

Cathe M. Calie

## THE MANN CENTER

Wayfinding & Signage Program
Plaza and Welcome Center

ART COMMISSION
SIGN AND STREETERY REVIEW

September 17, 2025




MERJE | ENVIRONMENTS & EXPERIENCES
5 W. Gay St.
West Chester, PA 19380
T 484.266.0648
www.merjedesign.com

## **Table of Contents**

## **Project Name**

A.	Project Boundary Sign Location Plan	A1
B.	Design Drawings South Gate	B1
	North Gate	B4
	Donor Gate	B6
	Welcome Center - Tickets	B9
	Interior Campus Signs	B1
	Landmark	R1

SECTION A | Sign Location Plan

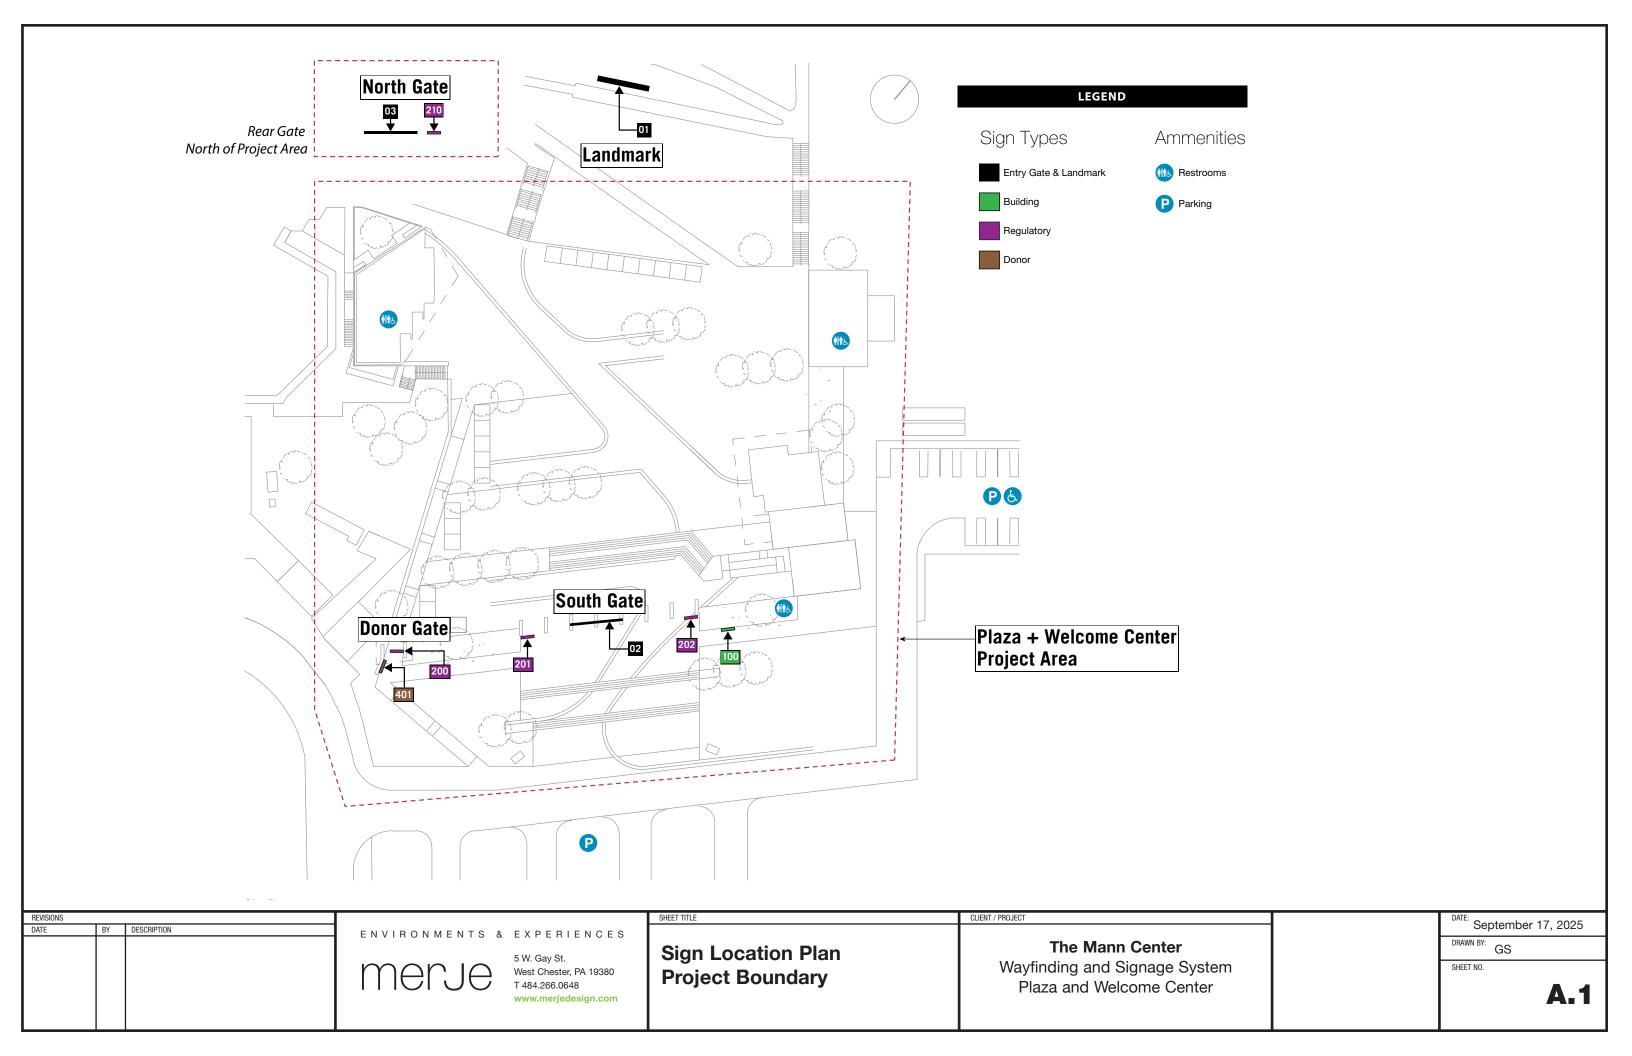


SECTION B Design Drawings

LOCATIONS 02/201/202 South Gate







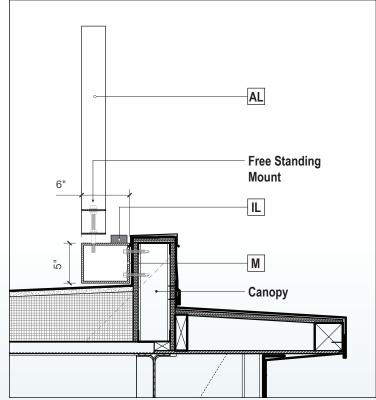



- M Mounting Raceway (Behind Canopy)
- AL Fabricated Aluminum Letters
- IL Illumination: z

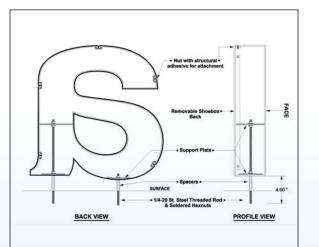

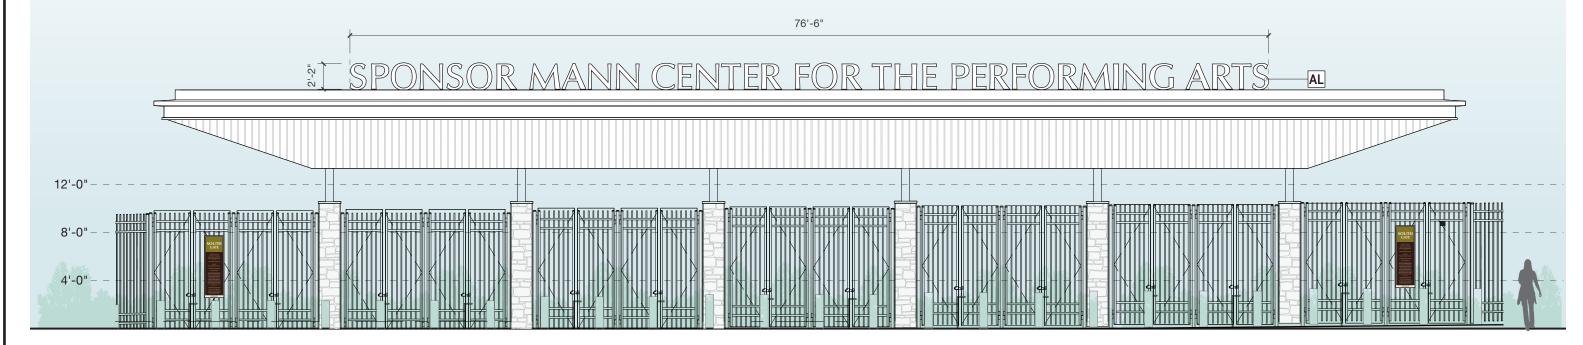

Scale: 1/8"=1'-0"

Location 02 Front Elevation

■ BEVISIONS		SHEET TITLE	CLIENT / PROJECT	DATE-	
REVISIONS  DATE  BY  DESCRIPTION	ENVIRONMENTS & EXPERIENCES  5 W. Gay St.  West Chester, PA 19380 T 484.266.0648 www.merjedesign.com	South Gate - Canopy Letters Location 02/201/202	The Mann Center Wayfinding and Signage System Plaza and Welcome Center	DRAWN BY: GS SHEET NO.	Der 17, 2025





DATE BY DESCRIPTION

ENVIRONMENTS & EXPERIENCES

merje

5 W. Gay St. West Chester, PA 19380 T 484.266.0648 www.merjedesign.com -I IIILL

South Gate - Canopy Letters Location 02/201/202

CLIENT / PROJECT

The Mann Center
Wayfinding and Signage System

Plaza and Welcome Center

September 17, 2025

DRAWN BY: GS
SHEET NO.







# SHOWCASE LINEAR WHITE Exterior LED liner

SHOWCASE SERIES

### **Features**

- Slim size easy fit in different architectural structures
- Dedicated optic design even washing effect
- On/Off control
- · Easy installation and maintenance auto-addressing and reliable connection by self-locking water-proof

## **Optical Specifications**

Luminous flux	Short	900 lm
	Long	2880 lm
Efficacy	80 lm/W	
CCT	4000 K	
CRI	80	
Beam angle	15° x 55°	

## **Electrical/Mechanical Specifications**

Input voltage	24 VDC	
Power consumption	Short	12 W
	Long	36 W
Dimensions L × W × H	Short	11.81"×1.61"×1.14"
(Excluding mounting bracket)	Long	39.37"×1.61"×1.14
Weight	Short	1.76 lbs.
	Long	4.41 lbs.
Cover lenses	Semi-tempered g	glass cover
Housing	Aluminum	


## **System Specifications**


ControlOn/Off
Max. interconnectionShort8 units
Long2 units
Adjustment options±90° tilt
Operating temperature4° F - 122° F
Storage temperature40° F - 176° F
EnvironmentOutdoor (IP66)
<b>Lumen maintenance</b> L <sub>70</sub> @ 25° C - 50,000 hours
Safety approval Electrical Protection Class III, CE, CB, U
Warranty3-year parts only



CLIENT / PROJECT

## **Dimensions**

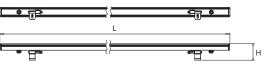

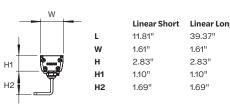

## **Product Options**

Showcase Linear White Fixtures Part	t number
Showcase Linear 12 W On/Off 15 × 55 4000 K Short P-LI	N1555-12W-40
Showcase Linear 36 W On/Off 15 × 55 4000 K Long P-Li	N1555-36W-40

Showcase Linear White Cables	Part number
Showcase Linear White 2-pin DC Power Starter Cable 6-ft	P-LN-2SC-2000
Showcase Linear White 2-pin DC Interconnection CAB 3-ft	P-LN-2IC-CAB-1000
Showcase Linear White 2/3-pin Connector Socket End Cap	P-LN-3PC-EC



Specifications subject to change without notice.

REVISIONS		
DATE	BY	DESCRIPTION

ENVIRONMENTS & EXPERIENCES

5 W. Gay St. T 484.266.0648 **South Gate - Canopy Letters** Location 02/201/202


**The Mann Center** 

Wayfinding and Signage System Plaza and Welcome Center


September 17, 2025 DRAWN BY: GS SHEET NO.

LOCATIONS 03/210 North Gate



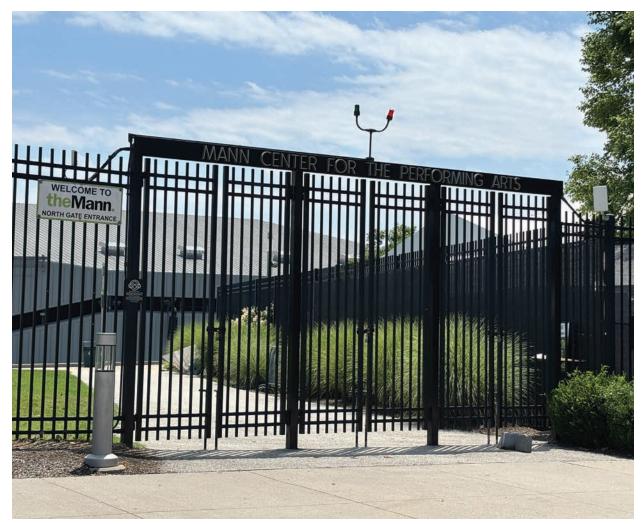



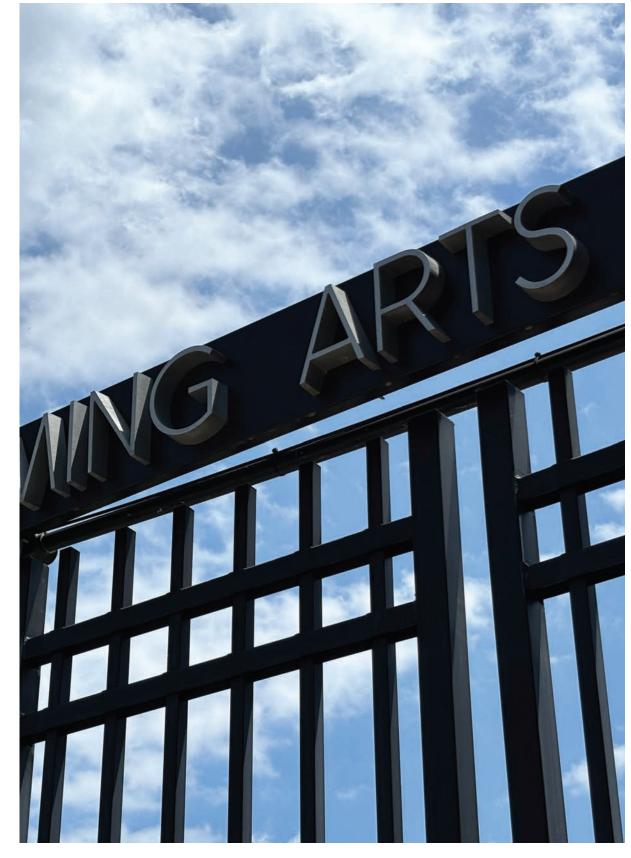

REVISIONS					
DATE	BY	DESCRIPTION			

ENVIRONMENTS & EXPERIENCES

merje

5 W. Gay St. West Chester, PA 1938 T 484.266.0648 www.merjedesign.co SHEET TITLE

North Gate - Letters Location 03/210 Existing Conditions CLIENT / PROJECT

The Mann Center
Wayfinding and Signage System


Plaza and Welcome Center

September 17, 2025

DRAWN BY: GS

SHEET NO.

LOCATIONS 401/200 Donor Gate

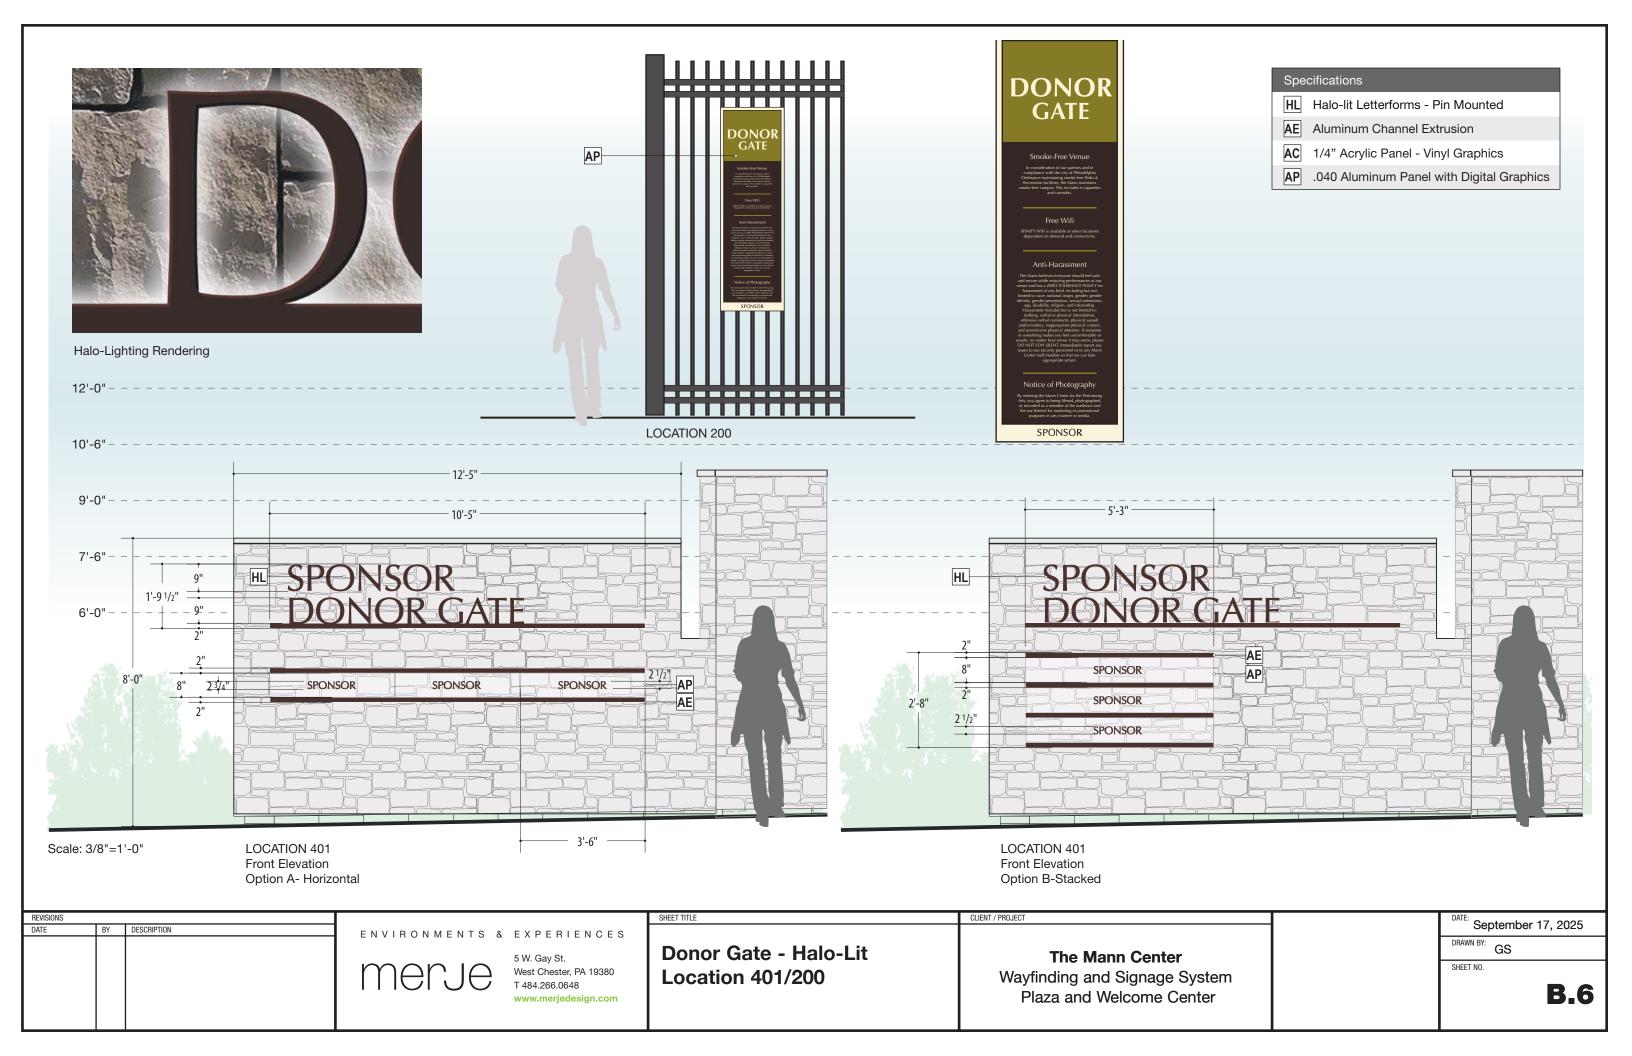



OCATION 401/200 ption A- Horizontal ay Rendering





LOCATION 401/200 Option B-Stacked Day Rendering



REVISIONS

DATE BY DESCRIPTION ENTS & EXPERIEN

merje

5 W. Gay St. West Chester, PA 19380 T 484.266.0648 SHEET TITLE


Donor Gate - Halo-Lit Location 401/200 CLIENT / PROJECT

The Mann Center
Wayfinding and Signage System
Plaza and Welcome Center

September 17, 2025

DRAWN BY: GS
SHEET NO.


\_

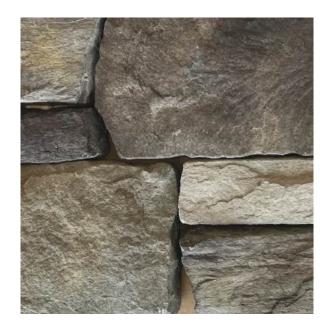

Stone Wal Material



Pin Mounted Letterforms Example

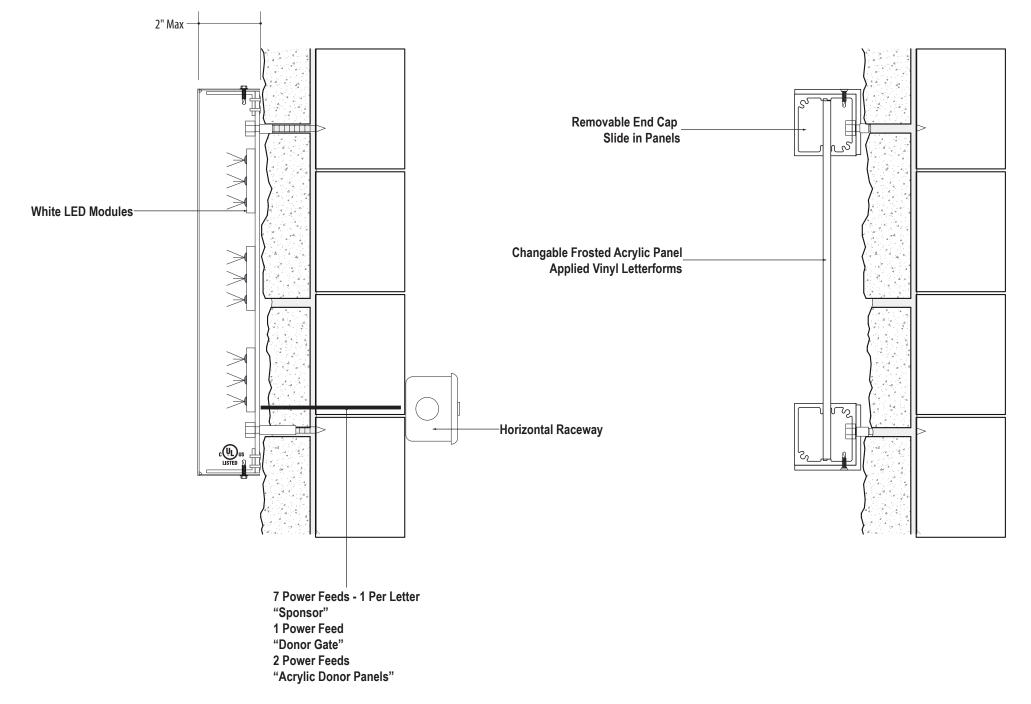

LOCATION 401 Section View Halo - Lit Letterforms Bitro - Resno Letter H1 LOCATION 401
Section View
Sign Comp Extrusion
Changeable - Frosted Acrylic Panel
Applied Vinyl Letterforms

REVISIONS	REVISIONS			SHEET TITLE	CLIENT / PROJECT	DATE: September 17, 2025
DATE	BY	DESCRIPTION	ENVIRONMENTS & EXPERIENCES			•
			5 W. Gay St. West Chester, PA 19380	Donor Gate - Halo-Lit	The Mann Center	DRAWN BY: GS
				Location 401	Wayfinding and Signage System	SHEET NO.
			T 484.266.0648	Location 401	Plaza and Welcome Center	<b>B.</b> 8
					Traza aria Troiocinio Contor	

LOCATION 100 | Welcome Center - Tickets







Specifications

HL Halo-lit Letterforms - Pin Mounted

Halo-Lighting Rendering

LOCATION 100 Welcome Center Building (WCB) South Elevation Location 100

REVISIONS

DATE BY DESCRIPTION

**LOCATION 100** 

Scale: 3/16"=1'-0"

Day Rendering

ENVIRONMENTS & EXPERIENCES

merje

5 W. Gay St. West Chester, PA 19380 T 484.266.0648 www.merjedesign.com Welcome Center - Tickets Location 100

The Mann Center
Wayfinding and Signage System
Plaza and Welcome Center

CLIENT / PROJECT

DATE: September 17, 2025

DRAWN BY: GS


SHEET NO.



Stone Wal Material



Pin Mounted Letterforms Example

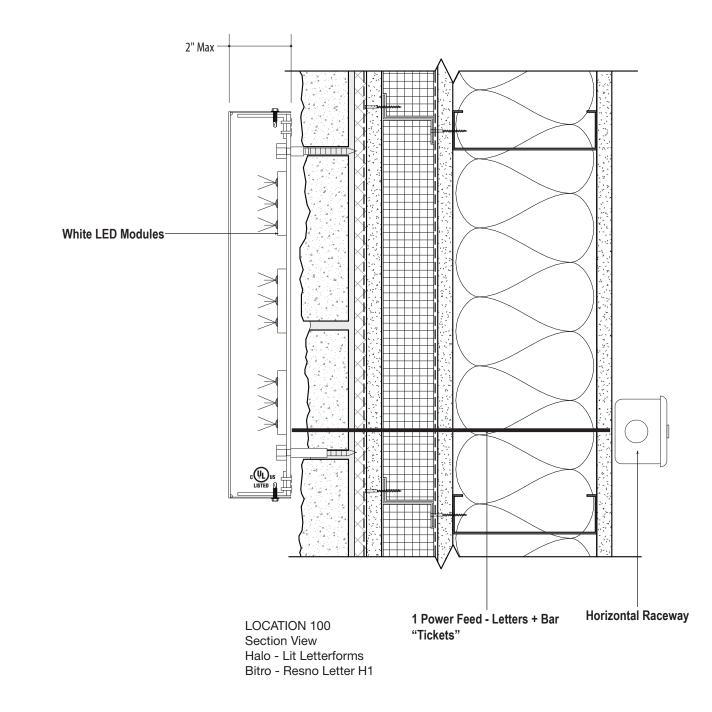

REVISIONS			
DATE	BY	DESCRIPTION	

ENVIRONMENTS & EXPERIENCES

merje

5 W. Gay St. West Chester, PA 19380 T 484.266.0648 www.merjedesign.com Welcome Center - Tickets Location 100

The Mann Center
Wayfinding and Signage System
Plaza and Welcome Center

CLIENT / PROJECT

September 17, 2025

DRAWN BY: GS

SHEET NO.

# INTERIOR CAMPUS Optima Consistency









REVISIONS
DATE BY DESCRIPTION

ENVIRONMENTS & EXPERIENCES

merje

5 W. Gay St. West Chester, PA 1938 T 484.266.0648 Interior Campus
Optima - Consistency

Informational

The Mann Center

CLIENT / PROJECT

Wayfinding and Signage System Plaza and Welcome Center

September 17, 2025

DRAWN BY: GS
SHEET NO.


# LOCATION 01 Landmark








- B Concrete Base with Stone Veneer
- AL Fabricated Aluminum Letters
- IL Illumination: Ground Mounted Spot-Lights

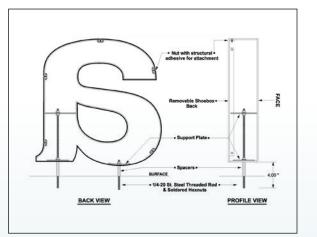



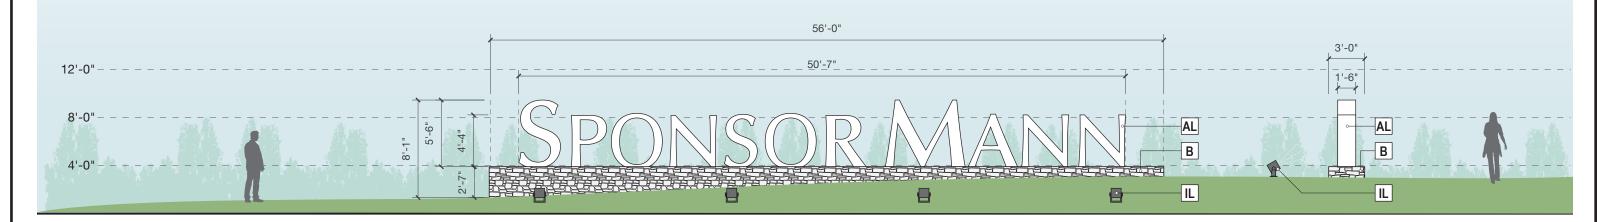

Scale: 1/8"=1'-0"

Location 01 Front Elevation

Side View

REVISIONS				SHEET TITLE	CLIENT / PROJECT		DATE: Contombor 17, 2005
DATE	BY	DESCRIPTION	ENVIRONMENTS & EXPERIENCES			1	September 17, 2025
			5 W. Gay St. West Chester, PA 19380 T 484.266.0648 www.merjedesign.com	Landmark Location 01	The Mann Center Wayfinding and Signage System Plaza and Welcome Center		DRAWN BY: GS SHEET NO.  B.12





REVISIONS

DATE BY DESCRIPTION

NVIRONMENTS & EXPERIENCES

merje

5 W. Gay St. West Chester, PA 1938 T 484.266.0648 Landmark

Location 01

CLIENT / PROJECT

The Mann Center

Wayfinding and Signage System Plaza and Welcome Center

September 17, 2025

DRAWN BY: GS
SHEET NO.



# Blast Powercore gen5, RGBW

Exterior versatile and customizable luminaire with intelligent RGBW light

Blast Powercore gen5, RGBW high-performance LED luminaires combine white and rich, saturated, color and color-changing effects with simplified installation. Blast Powercore gen5 offers a range of accessories that allow customizable beam angles for floodlighting, spotlighting, wall washing, and grazing, along with the efficiency and cost-effectiveness of Powercore technology in a rugged die-cast aluminium housing.

- · Higher lumen output for a dynamic color luminaire
- · Better-quality white light as compared to RGB
- Color flexibility and consistency



### Product page

Beam Angle	3° (Native), 5	°, 10°, 20°, 40°, 60°, 80°, 10° x 40°
Lumens*		1,733 to 2,547
Efficacy (lm/W) All Channels Full On		36.7 to 54.0
LED Channels		Red/Green/Blue/White
Environment		Dry/Damp/Wet Location, IP66

Input Voltage	100 to 277 VAC, auto-ranging, 50/60 Hz via Data Enabler Pro
Power Consumption	46.4 W
Weight	3.9 kg (8.2 lb)
Housing Material	Die-cast aluminium, powder-coated finish
Approbations	UL/cUL, FCC Class A, CE, PSE, CQC, RCM





Option A- Blast Powercore

## TERRA LINEAR™





Terra Linear™ are rugged, drive-over ready fixtures designed for all-weather in-ground applications. Available in 1 foot and 4 foot lengths, these aluminum-bodied IP68 fixtures are particularly suited to recessed façade lighting applications. Using unified power and DMX control links, Terra Linear fixtures can be rapidly daisy-chained in long runs. All standard mains voltages are directly supported or, to achieve impressive single runs up to 700 linear feet (213m), Terra Linear can be driven by Acclaim Lighting's XTR Driver. Anti-slip top coatings, anti-theft security screws and an IK10 drive-over rating of up to 6,000 lbs (2,721kg) make Terra Linear a natural choice for use in all public areas.

## AT A GLANCE





Option B- Terra Linear

REVISIONS		
DATE	BY	DESCRIPTION
	1	
	1	
	l	
	l	

ENVIRONMENTS & EXPERIENCES

merje

5 W. Gay St. West Chester, PA 19380 T 484.266.0648 www.merjedesign.com Landmark Location 01

SHEET TITLE

The Mann Center
Wayfinding and Signage System
Plaza and Welcome Center

CLIENT / PROJECT

DATE: September 17, 2025

DRAWN BY: GS

SHEET NO.