

**DAY VIEW** 

**NIGHT VIEW** 

## **RENDER**

ASCE 7-16 Site Criteria **Ultimate Wind Speed** 114 mph Wind on Ice mph Snow Load 34 psf Ice Thickness In Risk Category **Exposure Category** 

| FASTENER                               | HORIZONTAL SPACING PER WALL CONSTRUCTION (INCHES) |                     |         |               |                                      |   |  |
|--|---|---------------------|---------|---------------|--------------------------------------|---|--|
| HARDWARE                               | DIA.  | QTY. PER<br>SPACING | MASONRY | WOOD<br>STUDS | EIFS/DRYVIT OVER<br>1/2" MIN PLYWOOD | EIFS/DRYVIT OVER 1/2" MIN GYPSUM/DENGLASS | METAL PANEL OVER METAL STUD <sup>7</sup> |
| WOOD SCREW <sup>1,7</sup>              | #10   | 2                   | NO      | 24            | 24                                   | 24  | NO                                       |
| TEK SCREW <sup>2</sup>                 | #10   | 2                   | NO      | NO            | NO                                   | NO  | 24                                       |
| LAG BOLT <sup>3</sup>                  | 3/8"  | 2                   | NO      | 36            | 24                                   | 24  | NO                                       |
| THRU-BOLT4                             | 3/8"  | 2                   | 48      | NO            | 24                                   | 24  | 24                                       |
| EXPANSION ANCHOR <sup>5</sup>          | 3/8"  | 2                   | 48      | NO            | NO                                   | NO  | NO                                       |
| CARBON STEEL SCREW ANCHOR <sup>6</sup> | 3/8"  | 2                   | 48      | NO            | NO                                   | NO  | NO                                       |
| TOGGLE BOLT <sup>8</sup>               | 3/8"  | 2                   | 24      | NO            | 18                                   | 18  | 24                                       |

1) MINIMUM 1.5" EMBEDMENT INTO WOOD STUDS, OR MIN 1/4" PROTUDED FROM THE BACK OF PLYWOOD. 2) MIN 1/4" PROTUDED FROM THE BACK OF METAL STUD.

3) MINIMUM 2.5" EMBEDMENT INTO WOOD STUDS, OR MIN 1/4" PROTUDED FROM THE BACK OF PLYWOOD.

3) ANCHORS REQUIRE A MINIMUM 2" EMBEDMENT, ANCHOR SHALL BE INSTALLED IN CONCRETE OR GROUT FILLED CMU UNITS ONLY.

4) REQUIRES 2"x2"x1/4" STEEL BACKING PLATE.

5) USE HILTI HLC SLEEVE ANCHOR OR EQUIVALENT WITH 1-1/4" MIN EMBEDMENT

6) USE HILTI KWIK HUS-E OR APPROVED EQUIVALENT WITH 1-5/8" MIN EMBEDMENT.

7) MINIMUM 20 GAUGE METAL THICKNESS

8) THROUGH BLOCK FACE FOR CLAY BRICKS

9) IF THE CONTRACTOR ENCOUNTERS A METAL/WOODEN STUD, HE/SHE SHALL FOLLOW THE LAG/TEK SCREW GUIDELINE AS SHOWN ON THE SCHEDULE ABOVE. THE CONTRACTOR SHALL MAKE EVERY ATTEMPT TO USE STUDS WHENEVER POSSIBLE.

NOTE: THIS FASTENER SCHEDULE IS INTENDED FOR USE WITH SIGN CONNECTION TO BUILDING ONLY. IT IS ASSUMED THAT THE BUILDING IS RIGID, FREE OF STRUCTURAL DEFECTS, AND STRUCTURALLY SUFFICIENT TO CARRY THE LOAD OF THE SIGN. CONTRACTOR SHALL FOLLOW FASTENER SCHEDULE TO DETERMINE FASTENER TYPE TO BE USED FOR INSTALLATION AND SHALL ENSURE THE FASTENER HAS A RIGID AND STRONG CONNECTION. CONTRACTOR SHALL FOLLOW MANUFACTURERS SPECS FOR FASTENER/ANCHOR INSTALLATION. CONTRACTOR SHALL ENSURE THAT FASTENER BEARS ON WALL FACADE IMMEDIATELY AFTER INSTALLATION. CONTRACTOR SHALL NOT USE EXISTING HOLES PRESENT IN THE CURRENT FASCIA FOR FASTNER INSTALLATION.



**SITE PLAN** 



**EXISTING VIEW** 



WWW.TKCG.US

PREPARED FOR



| Issue No. | Issue Date | Issuance Description        |
|-----------|------------|-----------------------------|
| 1         | 3/23/24    | FOR PERMIT AND CONSTRUCTION |
|           |            |                             |
|           |            |                             |
CASA NOSTRA CHANNEL LETTERS AND EXISTING AWNING AND OVAL SIGN REFACE

775 S FRONT ST, PHILADELPHIA,

TKCG PROJECT NUMBER(S) GFS25-002


SCALE NOT TO SCALE


SHEET NAME

SIGN MOUNTING DETAILS

**EXISTING AWNING** AND OVAL SIGN



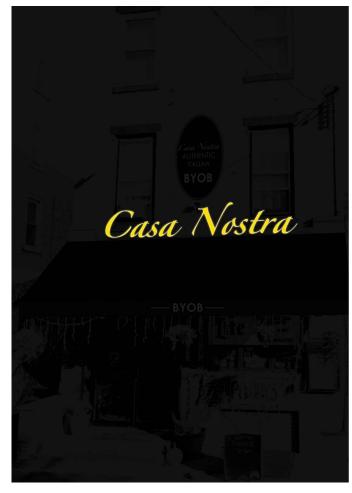

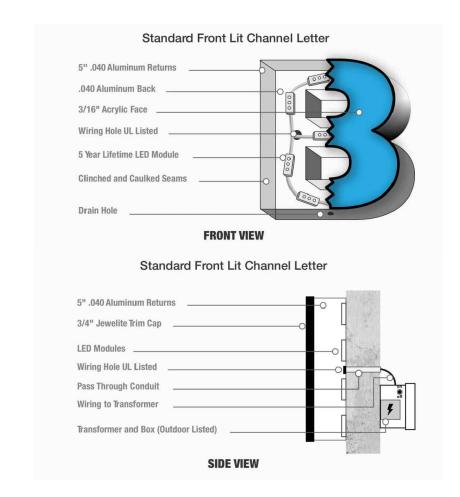


**DAY VIEW** 

SCALE: N.T.S.

**CHANNEL LETTER DESIGN** 

**NIGHT VIEW** 

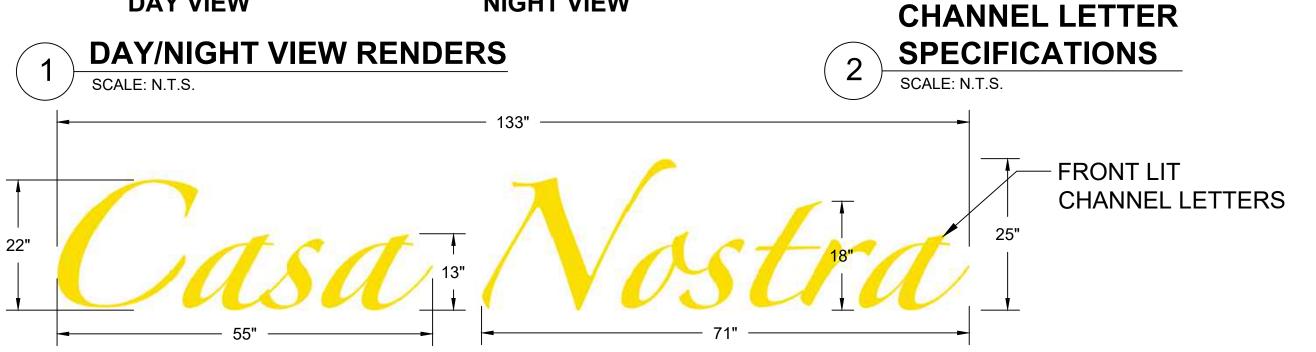

WWW.TKCG.US

PREPARED FOR



| Issue No. | Issue Date | Issuance Description        |
|-----------|------------|-----------------------------|
| 1         | 3/23/24    | FOR PERMIT AND CONSTRUCTION |
|           |            |                             |
|           |            |                             |
CASA NOSTRA CHANNEL LETTERS AND EXISTING AWNING AND OVAL SIGN REFACE

775 S FRONT ST, PHILADELPHIA,


TKCG PROJECT NUMBER(S) GFS25-002

SCALE NOT TO SCALE

RENDERS AND SIGN MEASUREMENTS CHANNEL LETTERS



**AWNING AND OVAL SIGN REFACE RENDER** 

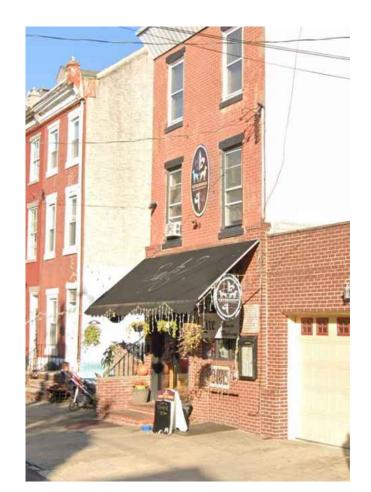





PREPARED FOR

WWW.TKCG.US



| Issue No. | Issue Date | Issuance Description        |  |
|-----------|------------|-----------------------------|--|
| 1         | 3/23/24    | FOR PERMIT AND CONSTRUCTION |  |
|           |            |                             |  |
|           |            |                             |  |
CASA NOSTRA CHANNEL LETTERS AND EXISTING AWNING AND OVAL SIGN REFACE

775 S FRONT ST, PHILADELPHIA,


TKCG PROJECT NUMBER(S) GFS25-002

SCALE NOT TO SCALE

AWNING AND OVAL SIGN REFACE

**EXISTING VIEW** SCALE: N.T.S.

**OVAL SIGNS REFACE DESIGN** SCALE: N.T.S.

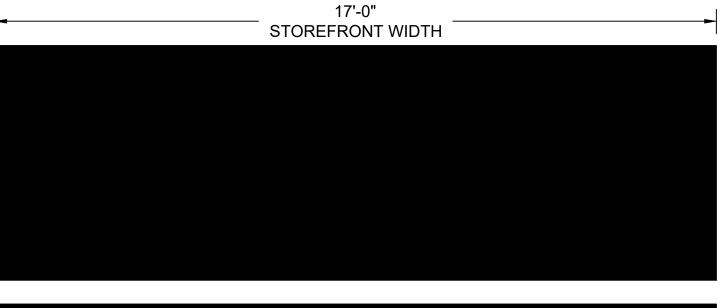

-BYOB—

SCALE: N.T.S.

**AWNING REFACE DESIGN** 

SCALE: N.T.S.