

February 27, 2025

Philadelphia Art Commission 1515 Arch Street – 13th Floor Philadelphia, PA 19102

Re: Request for Administrative Approval

Mr. Alex M Smith,

We respectfully request administrative approval for the proposed work at the Shelly Administrative building at the Philadelphia Zoo. The project includes the replacement of existing windows and louvers on all facades of the building and the addition of a canopy to protect one set of exterior stairs that lead to the lower floor level. The windows date from the original construction in 1969 and are way past their prime. This cover letter and attached information show the intended extent of work.

Please inform me if this will require a formal Art commission presentation for the project.

Project Manager, Jim Crossan Ali Dowd or I may be contacted at the phone number listed below or by email at: dseiler@sdadrc.com , jcrossan@sdarc.com or adowd@sdarc.com

Sincerely,

Douglas E. Seiler, AIA, LEED AP

Seiler + Drury Architecture

Existing Conditions Photographs



View from N/E along 34th Street



View from S/E along 34th Street



View of Entrance from N/W




View from S/W



Detail at S/W Corner



Detail at S/E Corner

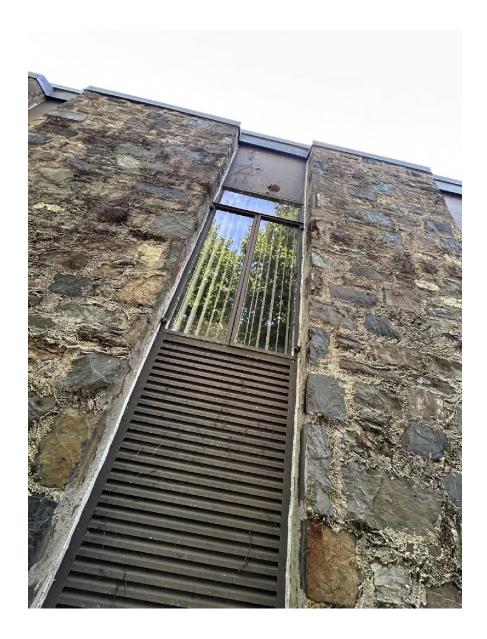

Typical Window w/ Louver

PROPOSED ACCESSIBILITY IMPROVEMENTS FOR: PHILADELPHIA ZOOLOGICAL GARDENS

STRUCTURAL DRAWINGS

ELECTRICAL DRAWINGS

GENERAL NOTES

SECTIONS

PARTIAL FRAMING PLANS

ELECTRICAL COVER SHEET

ELECTRICAL PLANS & SCHEDULES

S0.0

S1.0

S2.0

ECS

E105

3400 WEST GIRARD AVENUE PHILADELPHIA, PA 19104

REVISIONS REVISIONS 02-06-25 CLARIFICATIONS

GENERAL NOTES

1. ALL CONSTRUCTION SHOWN IS EXISTING TO REMAIN UNLESS NOTED OTHERWISE

THE CONTRACTORS SHALL VISIT AND EXAMINE THE PREMISES SO AS TO FULLY UNDERSTAND ALL OF THE EXISTING CONDITIONS PERTAINING TO

2. THE TENANT/LANDLORD RESERVES THE RIGHT TO DESIGNATE THE ORDER IN WHICH THE CONTRACTOR SHALL PROCEED WITH ANY AND ALL

THE CONTRACTOR SHALL COMPLY WITH ALL FEDERAL, STATE AND MUNICIPAL LAWS AND ORDINANCES AND SHALL GIVE ALL NOTICES AND OBTAIN ALL PERMITS NECESSARY FOR THE WORK, AND SHALL PAY ALL COST OF FEES FOR THE SAME

WITH ALL APPLICABLE PROVISIONS OF FEDERAL, STATE, OR MUNICIPAL SAFETY LAWS TO PREVENT ACCIDENTS OR INJURY ON OR ABOUT THE

8. UPON COMPLETION OF THE INSTALLATION, ALL SYSTEMS AND ALL FEATURES SHALL BE TESTED AND DEMONSTRATED IN THE PRESENCE OF

11. ALL MATERIALS AND EQUIPMENT SHALL BE INSTALLED IN COMPLETE COMPLIANCE WITH ALL APPLICABLE CODES AND MANUFACTURER'S OWNER UPON PROJECT COMPLETION.

1. CONTRACTOR SHALL BE RESPONSIBLE TO ENGAGE AN ENGINEER TO DESIGN AND IMPLEMENT ALL TEMPORARY SHORING REQUIRED T PERFORM THE WORK.

2. EXCEPT THOSE ITEMS IDENTIFIED FOR STORAGE BY THE OWNER, ALL OTHER REMOVED ITEMS SHALL BECOME THE PROPERTY OF THI

4. CONTRACTOR TO PATCH, REPAIR AND PREPARE FOR NEW CONSTRUCTION AND/OR FINISH OF EXISTING SURFACES/EQUIPMENT TO REMAIN ADJACENT TO THOSE INDICATED OR REQUIRED FOR DEMOLITION.

SYSTEM SUB-CONTRACTOR COORDINATION

CS1.0

SP1.0

A2.0

A4.0

A4.1

A4.2

A4.3

ARCHITECTURAL DRAWINGS

COVER SHEET

SITE PLAN

ALL CUTTING AND PATCHING INCLUDED BUT NOT LIMITED TO THRU-ROOF PENETRATIONS IS TO BE PERFORMED BY SKILLED WORKMEN

2. RELOCATION OF DEVICES AND EQUIPMENT TO BE "DESIGN BUILD." G.C. TO COORDINATE ALL RELOCATIONS WITH SUB-CONTRACTORS

DRAWING LIST SHELLY ADMINISTRATION BUILDING

BASEMENT & FIRST FLOOR DEMO PLANS

SECOND FLOOR DEMOLITION PLAN

BASEMENT & FIRST FLOOR PLANS

WINDOW & DOOR SCHEDULES

WALL SECTIONS & DETAILS

WALL SECTIONS & DETAILS

WALL SECTIONS & DETAILS


ENLARGED WINDOW ELEVATIONS

SECOND FLOOR PLAN

EXTERIOR ELEVATIONS

EXTERIOR ELEVATIONS

DEMOLITION EXTERIOR ELEVATIONS

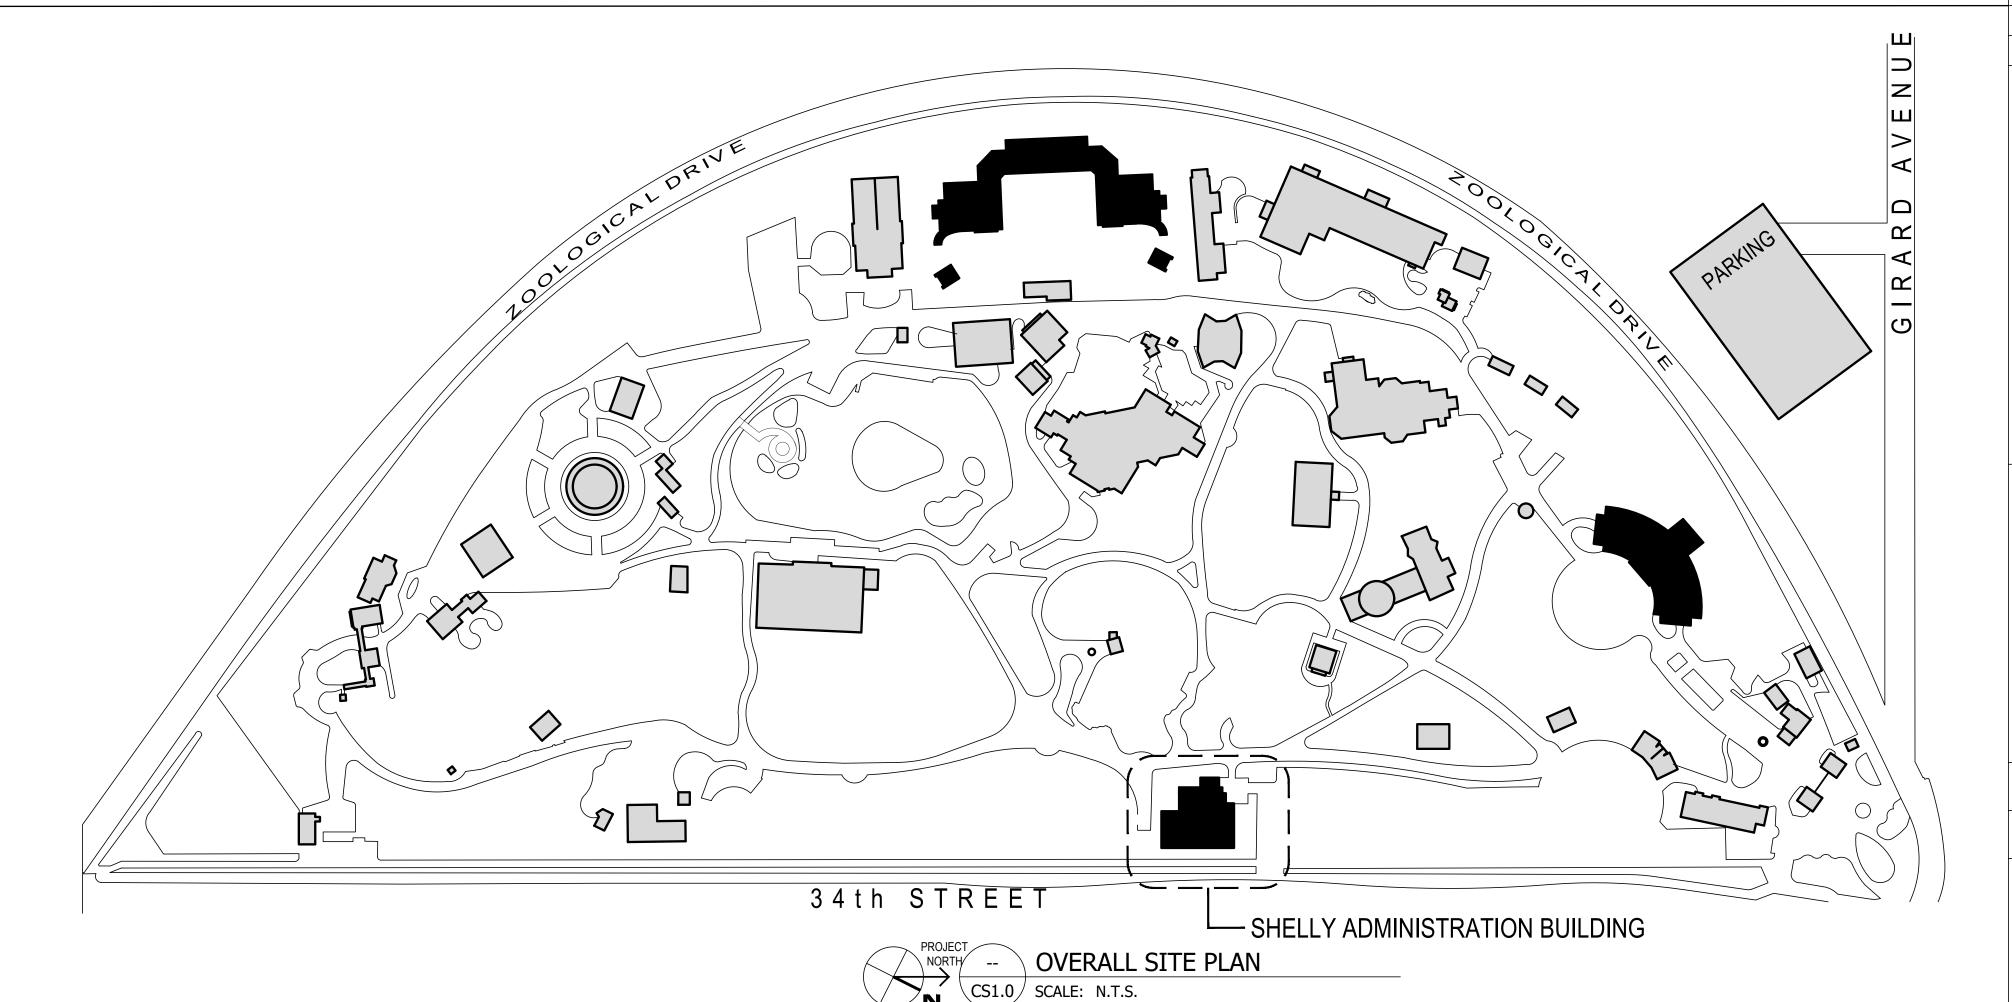

BUILDING INFORMATION

CONSTRUCTION TYPE:

MAIN OCCUPANCY / USE GROUP:

PROJECT TYPE:

BUILDING AREA:

TENANT AREAS:

BASEMENT

FIRST FLOOR:

SECOND FLOOR:

NUMBER OF STORIES:

EXIT ACCESS TRAVEL DISTANCE:

COMMON PATH OF TRAVEL

LIFE SAFETY SYSTEMS:

FIRE EXTINGUISHERS

EMERGENCY LIGHTS

FIRE SPRINKLER SYSTEM

FIRE ALARM

EXIT SIGNAGE

EXISTING

EXISTING

EXISTING

EXISTING


EXISTING

NUMBER OF EXITS:

COLUMNS:

FLOORS:

WALLS:

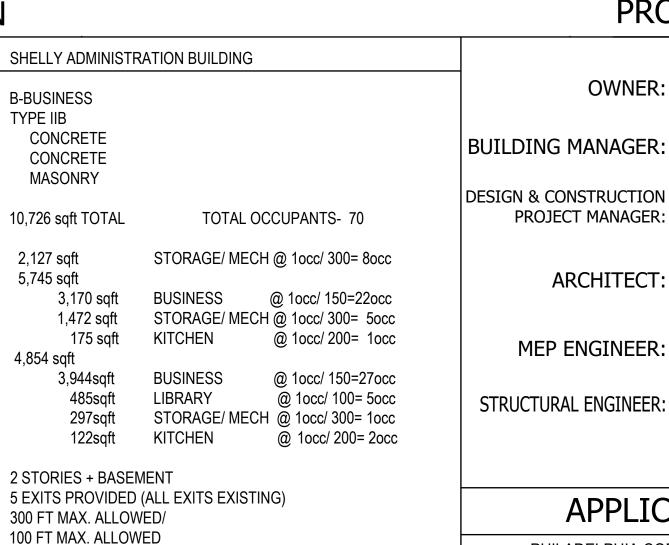

APPLICABLE CODES



SEILER + DRURY ARCHITECTURE

420 DEKALB STREET NORRISTOWN PA 19401

Tel 610.272.4809 www.sdarc.com

SPACE FOR CONSULTANT RECOGNITION

CITY OF PHILADELPHIA DEPARTMENT OF PUBLIC PROPERTY

CAPITAL PROJECTS DIVISION

1400 JFK BLVD 7TH FLR CITY HALL

PHILADELPHIA ZOOLOGICAL GARDENS

-SHELLY ADMINISTRATION BUILDING- WINDOW TREATMENTS

SHELLY ADMINISTRATION BUILDING COVERSHEET

PROJECT NO. 2424 12-16-2024 SCALE

CHECKED BY

ALL DIMENSIONS AND CONDITIONS SHALL BE VERIFIED BY THE CONTRACTOR AT THE SITE BEFORE PROCEEDING WITH THE WORK.

PHILADELPHIA CODES

ADMINISTRATIVE CODE PHILADELPHIA ZONING CODE PHILADELPHIA BUILDING CODE ' PHILADELPHIA EXISTING BUILDING CODE* PHILADELPHIA MECHANICAL CODE* PHILADELPHIA PLUMBING CODE* PHILADELPHIA ENERGY CONSERVATION CODE* PHILADELPHIA ELECTRICAL (2017 NATIONAL ELECTRICAL CODE) PHILADELPHIA FIRE CODE PHILADELPHIA PROPERTY MAINTENANCE CODE PHILADELPHIA ACCESSIBILITY CODE (2009 ICC A117.1) * BASED ON THE 2018 INTERNATIONAL CODES

PROJECT DIRECTORY

CITY OF PHILADELPHIA

PHILADELPHIA, PA

DEPARTMENT OF PUBLIC PROPERTY

PHILADELPHIA ZOOLOGICAL GARDENS

CAPITAL PROJECTS DIVISION

3400 WEST GIRARD AVENUE

CAPITAL PROGRAMS OFFICE

1400 JFK BLVD 7th FLOOR CITY HALL

SEILER + DRURY ARCHITECTURE

304 MASTER STREET, FIRST FLOOR

WZG STRUCTURAL CONSULTING ENGINEERS

KYLE O'CONNOR, RLA LEED GREEN ASSOCIATE

PHILADELPHIA, PA 19104

CITY OF PHILADELPHIA

PHILADELPHIA, PA

420 DEKALB STREET

TEL: (610) 272-4809

TEL: (267) 800 3540

1137 N. GRAVEL PIKE

ZIEGLERVILLE, PA 19492-0024


PO BOX 24


HUTEC ENGINEERING


NORRISTOWN, PA 19401


PHILADELPHIA, PA 19122

1400 JFK BLVD 7th FLOOR

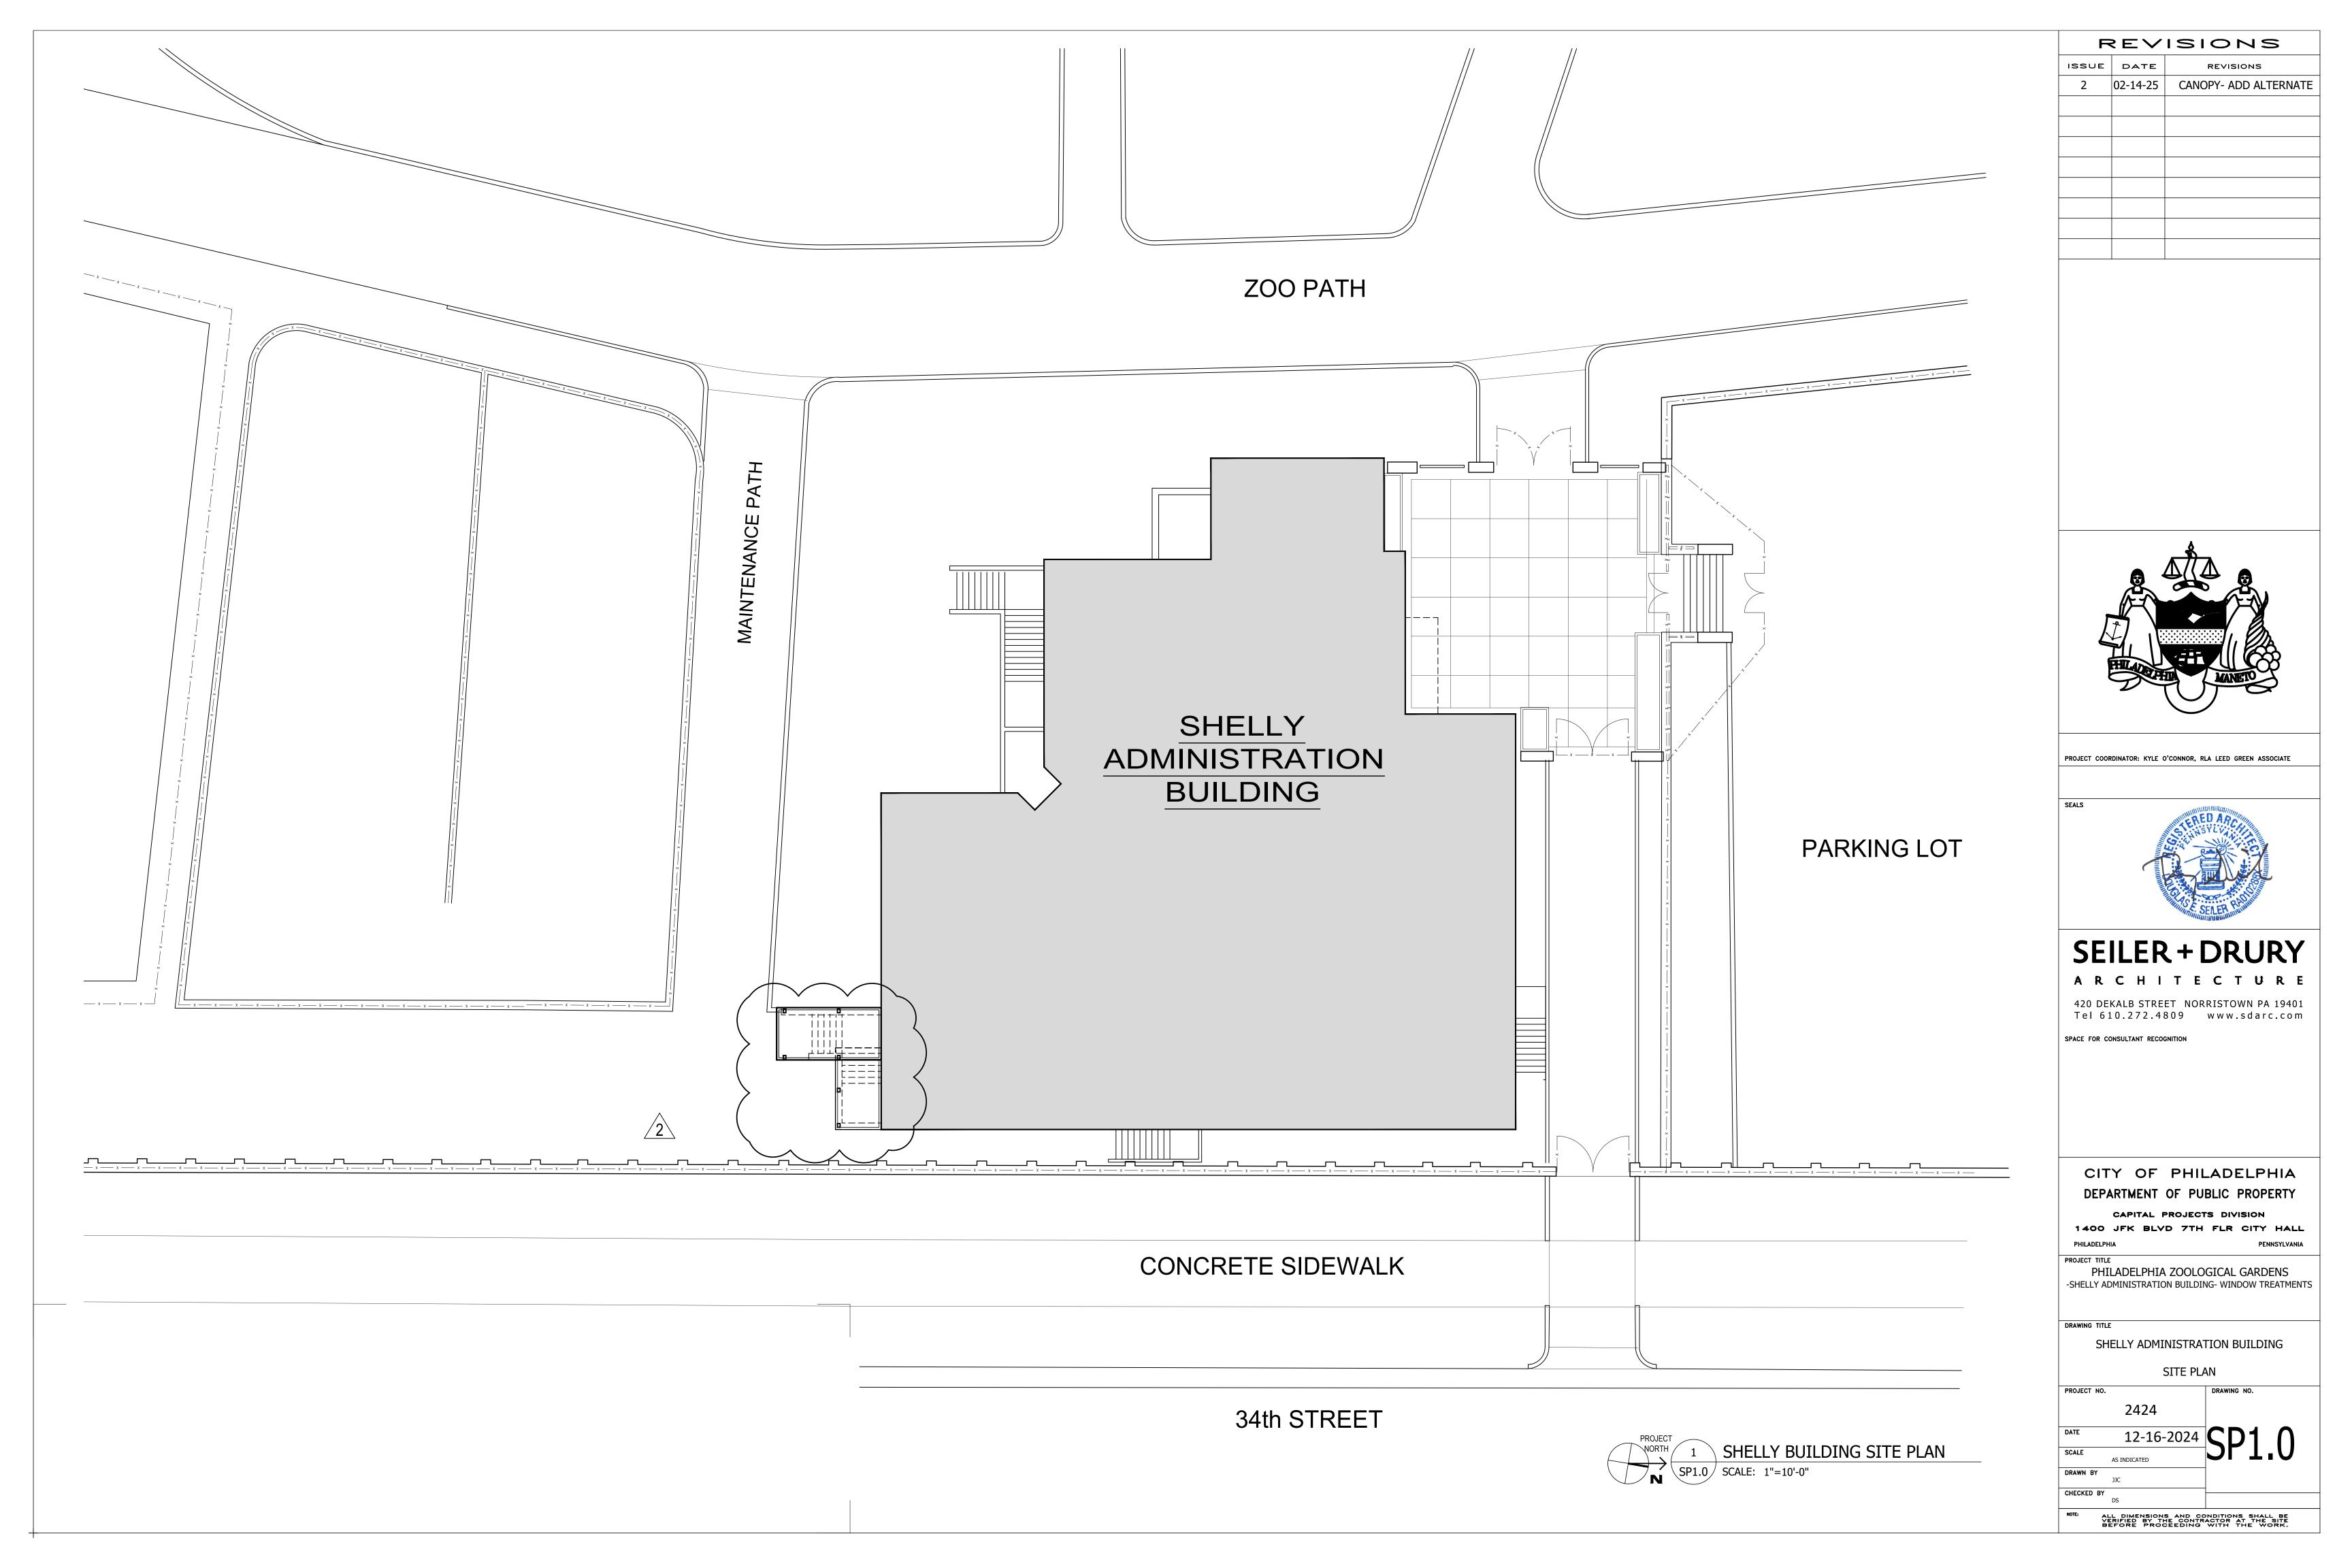

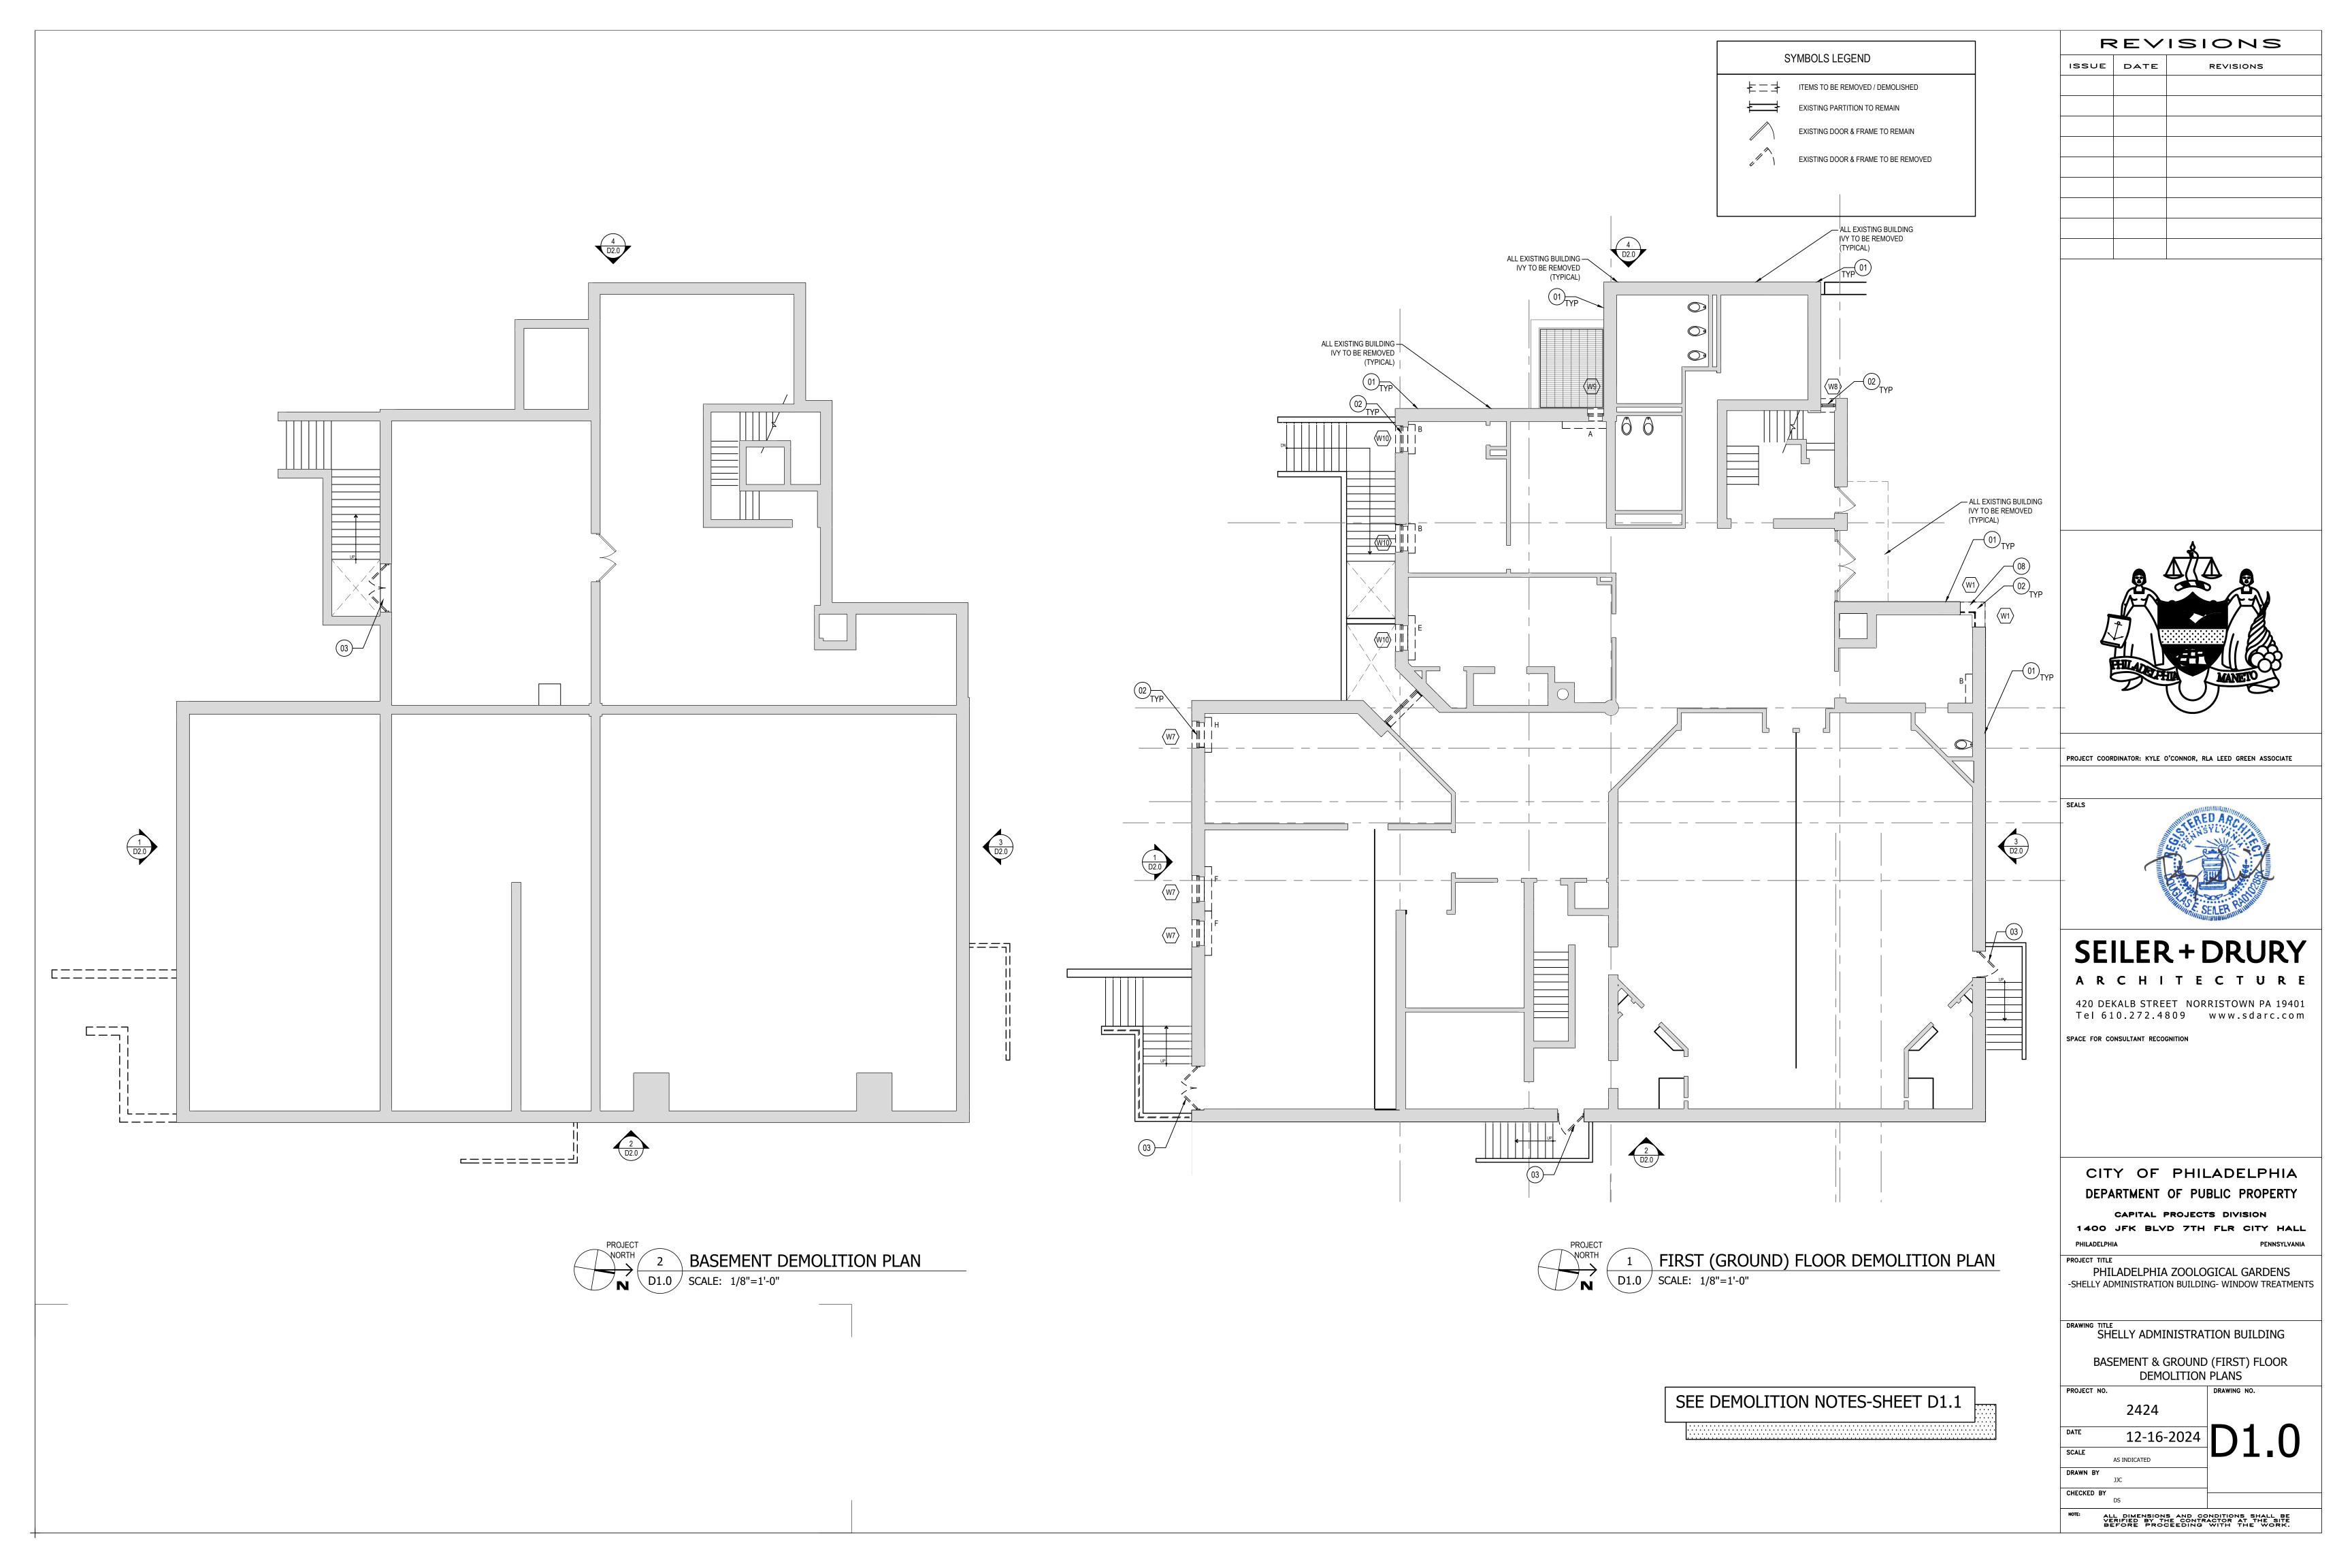

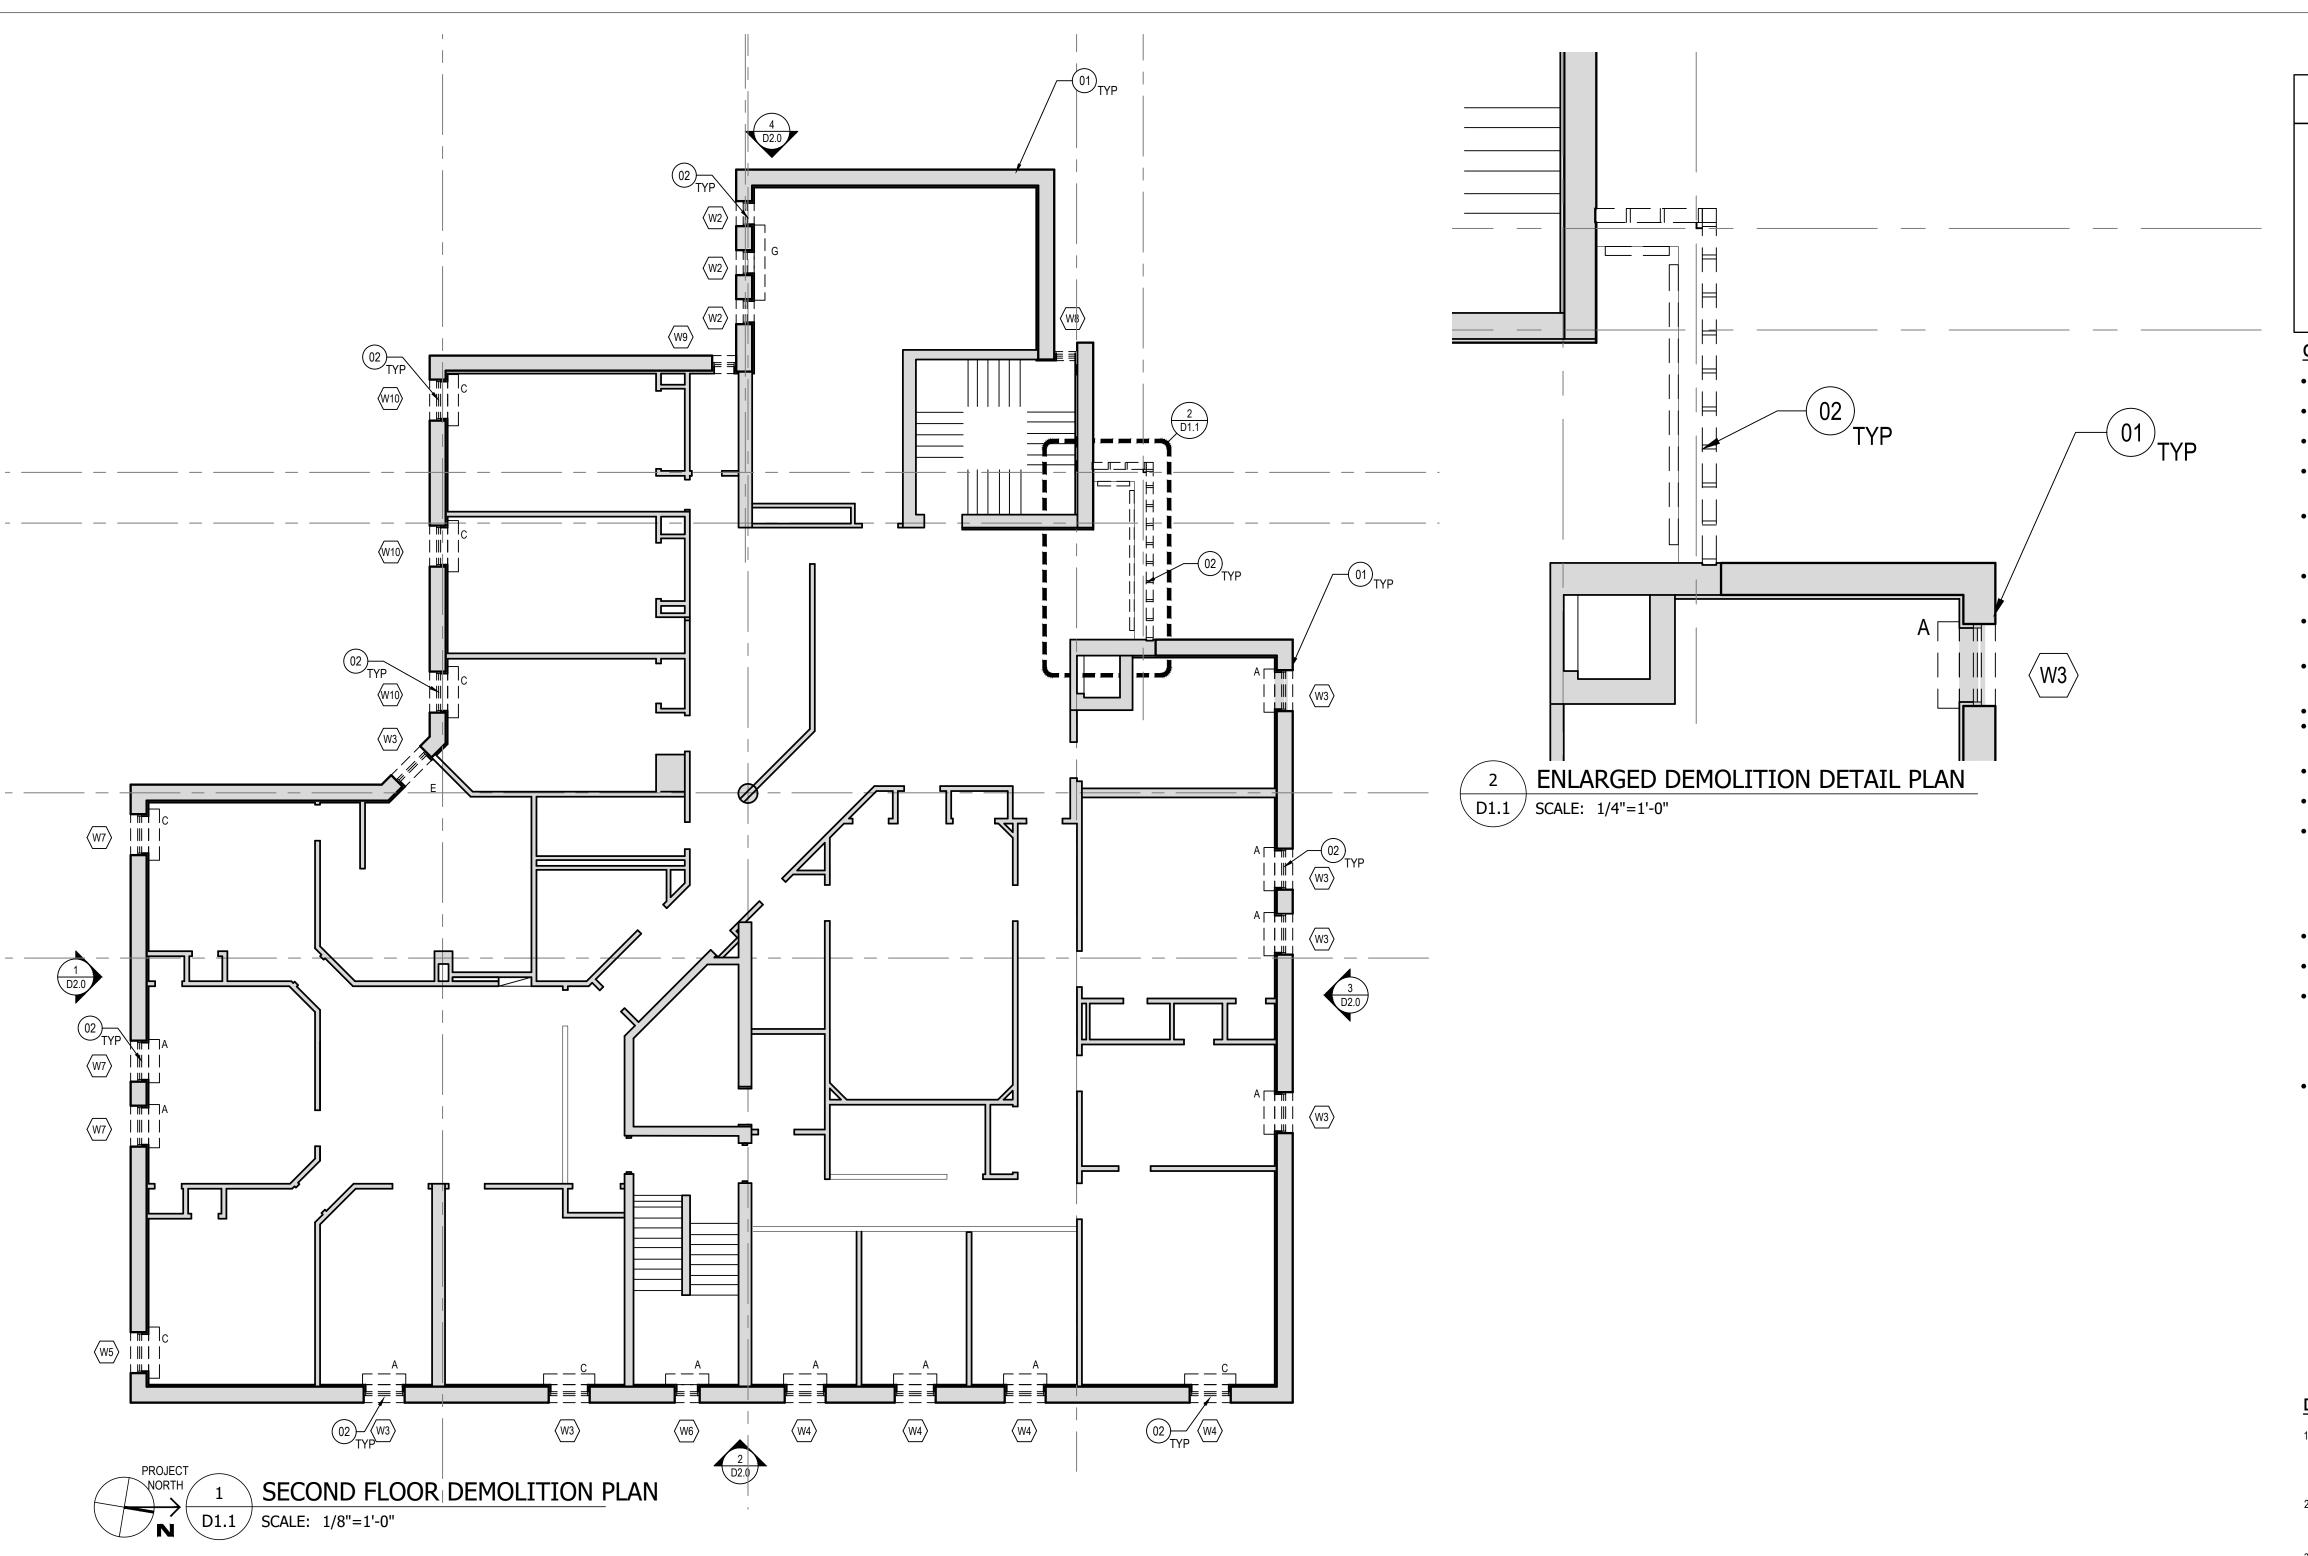

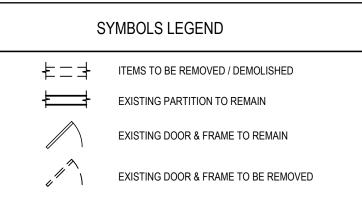

GENERAL DEMO NOTES

- REMOVE ALL DEMOLITION DEBRIS FROM SITE IN ACCORDANCE W/ SPECIFICATIONS & APPLICABLE CODES & REGULATIONS.
 LOCATE, IDENTIFY, DISCONNECT AND SEAL OR CAP OFF
- LOCATE, IDENTIFY, DISCONNECT AND SEAL OR CUTILITIES TO BE REMOVED.
- MAINTAIN EXISTING UTILITIES INDICATED TO REMAIN IN SERVICE AND PROTECT THEM AGAINST DAMAGE.
 REMOVE EXISTING MATERIALS AS SHOWN AND, IF NOT SHOWN
- AS REQUIRED TO ACCOMMODATE THE NEW WORK. INCLUDING ALL MEP ITEMS THAT INTERFERE WITH THE NEW LAYOUT.

 THE OWNER WILL OCCUPY PORTIONS OF THE BUILDING
- ADJACENT TO SELECTIVE DEMOLITION AREA. CONDUCT SELECTIVE DEMOLITION SO OWNER'S OPERATIONS WILL NOT BE DISRUPTED.

 PROMPTLY NOTIFY THE BUILDING OWNER AND ARCHITECT
- PRIOR TO THE REMOVAL OR MODIFICATION OF ANY STRUCTURAL ELEMENT.

 TAKE DOWN EXISTING WORK IN THE REVERSE ORDER OF CONSTRUCTION. DO NOT KNOCK DOWN OR UNDERMINE THE
- WORK IN WAYS THAT WILL CAUSE IT TO FALL.
 PROVIDE SHORING, BRACING AND SUPPORTS AS REQUIRED TO PRESERVE STABILITY AND PREVENT MOVEMENT, SETTLEMENT OR COLLAPSE OF CONSTRUCTION.
- PROTECT CONSTRUCTION INDICATED TO REMAIN.
 ANY AREA OUTSIDE THE LIMIT OF CONTRACT DISTRIBUTED BY
- DEMOLITION SHALL BE RESTORED AT THE CONTRACTORS EXPENSE.
- ERECT AND MAINTAIN DUST BARRIERS TO OCCUPIED AREAS
 PROTECT ALL AREAS FROM THE WEATHER AT ALL TIMES.
 PROMPTLY REMOVE FROM THE SITE AND LEGALLY DISPOSE OF
- ALL DEBRIS AND RUBBISH.

 THERE IS POSSIBILITY THAT HAZARDOUS MATERIALS MAY BE DISCOVERED ON THIS PROJECT. IF MATERIALS SUSPECTED TO BE HAZARDOUS ARE ENCOUNTERED DO NOT DISTURB THEM. THE CONTRACTOR SHALL PROMPTLY INFORM THE ARCHITECT AND OWNER OF THE PRESENCE OF SUCH MATERIALS THE OWNER WILL REMOVE HAZARDOUS MATERIAL UNDER A
- SEPARATE CONTRACT.
 COMPLY WITH REGULATIONS TO PROTECT WORKERS EXPOSED TO HAZARDOUS MATERIAL.
- DISPOSE OF HAZARDOUS MATERIAL PROPERLY ACCORDING TO
- GOVERNING LOCAL STATE AND NATIONAL REQUIREMENT.

 SOME EXISTING FINISHES MAY CONTAIN ASBESTOS, ANY ELEMENTS CONFIRMED BY THE ASBESTOS REPORT TO BE HAZARDOUS SHALL BE ABATED BY A CERTIFIED ASBESTOS ABATEMENT CONTRACTOR PRIOR TO DEMOLITION, ELEMENT REQUIRING ASBESTOS ABATEMENT SHALL BE DEDUCTED FROM THE GENERAL CONTRACTOR BASE BID.
- GC TO COORDINATE WITH THE OWNER FOR A FINAL ASBESTOS REPORT AFTER ALL ASBESTOS CONTAINING MATERIALS ARE ARATED

DEMO KEY NOTES (XX)

- EXISTING IVY TO BE REMOVED IN ITS ENTIRETY (SEE SPECIFICATIONS).
 PATCH AND REPAIR ALL STONE AND/ OR MORTAR DAMAGED OR BY IVY OR
 DAMAGED OR EXPOSED DURING REMOVAL PROCESS. MORTAR AND
 STONE TO MATCH EXISTING ADJACENT MORTAR/ STONE.
- 2. REMOVE EXISTING WINDOWS, FRAMES AND ALL APPURTENANCES.
 PREPARE EXISTING SURFACES TO RECEIVE NEW SCHEDULED WINDOW
 ASSEMBLIES. (SEE A2.0 AND A3.0)
- REMOVE EXISTING DOORS & FRAMES AS SHOWN. PREPARE EXISTING SURFACES TO RECEIVE NEW SCHEDULED DOOR/ FRAME ASSEMBLIES. (SEE SHEET A3.1)
- 4. NOT USED
- 5. NOT USED
- 6. REMOVE EXISTING FINISH CEILING AS REQUIRED IN CONSTRUCTION AREAS (ACT GRID OR GWB) AND LIGHT FIXTURES/ DEVICES, TYPICAL. SALVAGE LIGHT FIXTURES AS REQUIRED FOR REINSTALLATION IN OFFICE SPACE AS REQUIRED BY NEW LAYOUT
- 7. -REMOVE EXISTING RAILING: PREPARE TOP OF RETAINING WALL TO
- 8. REMOVE EXISTING DAMAGED CAST STONE SILL TO BE REPLACED
- 9. MAINTAIN EXISTING SITE SECURITY CAMERAS- LINE IDENTIFY RETAIN LOW VOLTAGE WIRING FOR REINSTALL OF SYSTEM AS REQUIRED.
- 10. REMOVE METAL SOFFIT PANELS AND FASCIA, AS REQUIRED BY NEW CONSTRUCTION, TO BE REPLACED.

REVISIONS

REVISIONS

ISSUE DATE



PROJECT COORDINATOR: KYLE O'CONNOR, RLA LEED GREEN ASSOCIATE



SEILER + DRURY

ARCHITECTURE

420 DEKALB STREET NORRISTOWN PA 19401
Tel 610.272.4809 www.sdarc.com

SPACE FOR CONSULTANT RECOGNITION

CITY OF PHILADELPHIA DEPARTMENT OF PUBLIC PROPERTY

CAPITAL PROJECTS DIVISION

1400 JFK BLVD 7TH FLR CITY HALL

PROJECT TITLE
PHILADELPHIA ZOOLOGICAL GARDENS
-SHELLY ADMINISTRATION BUILDING- WINDOW TREATMENTS

DRAWING TITLE

CHECKED BY

SHELLY ADMINISTRATION BUILDING

EXISTING SECOND FLOOR DEMOLITION PLAN

PROJECT NO.


2424

DATE
12-16-2024

SCALE
AS INDICATED

DS

NOTE: ALL DIMENSIONS AND CONDITIONS SHALL BE VERIFIED BY THE CONTRACTOR AT THE SITE BEFORE PROCEEDING WITH THE WORK.

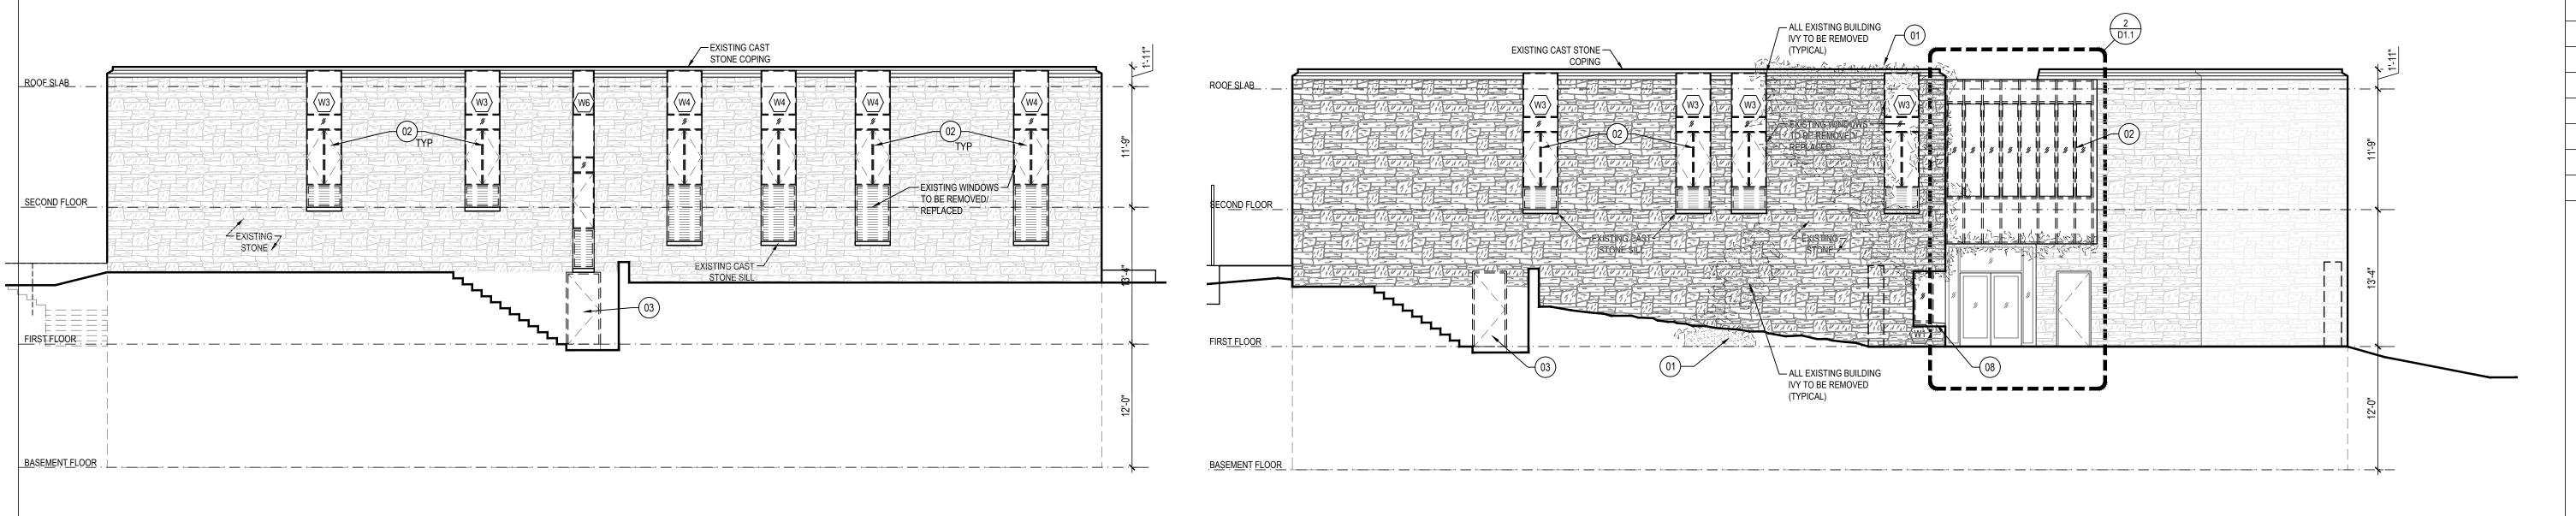


DEMO- EAST ELEVATION D2.0 / SCALE: 1/8"=1'-0"

STONE COPING ALL EXISTING BUILDING -IVY TO BE REMOVED EXISTING WINDOW -TO BE REMOVED/ SECOND FLOOR EXISTING 7 TO BE REMOVED/ REPLACED ALL EXISTING BUILDING — ALL EXISTING BUILDING — STONE SILL IVY TO BE REMOVED IVY TO BE REMOVED (TYPICAL) (TYPICAL)

> **DEMO- WEST ELEVATION** D2.0 \int SCALE: 1/8"=1'-0"

BASEMENT FLOOR

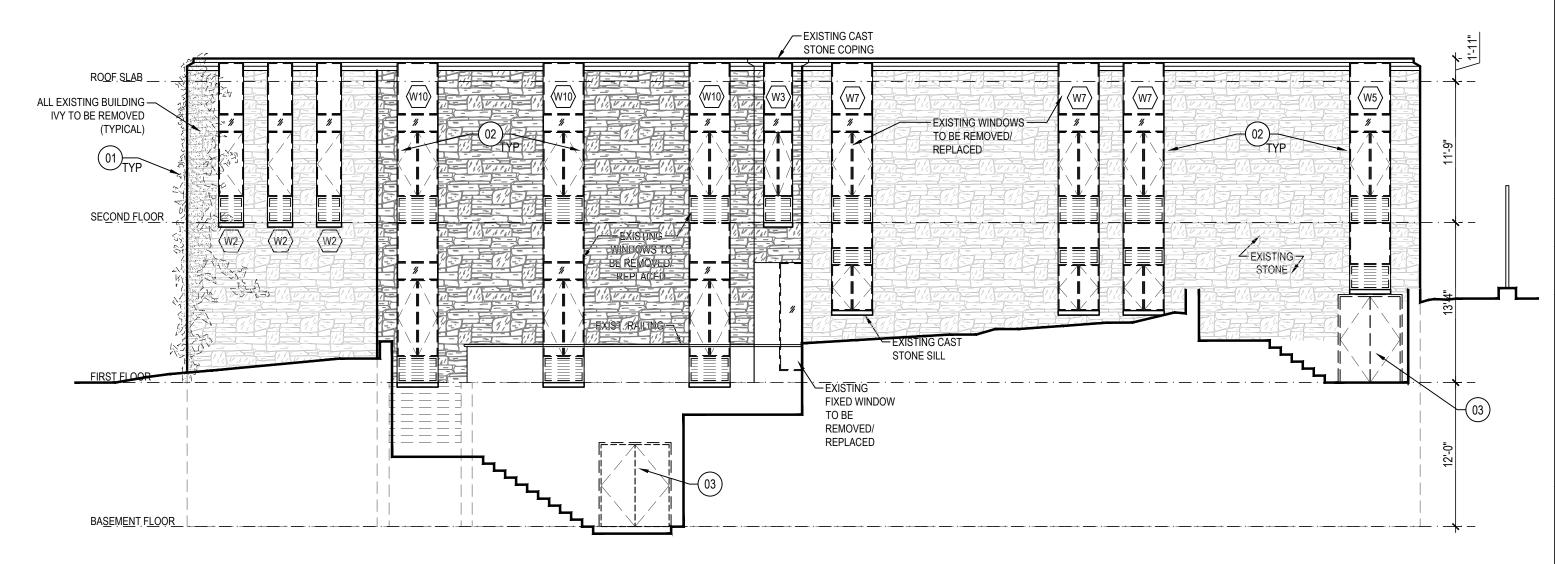

DEMO- SOUTH ELEVATION

DEMO- NORTH ELEVATION

 \bigcirc D2.0 \bigcirc SCALE: 1/8"=1'-0"

DEMO KEY NOTES (XX)

1. EXISTING IVY TO BE REMOVED IN ITS ENTIRETY (SEE SPECIFICATIONS). PATCH AND REPAIR ALL STONE AND/ OR MORTAR DAMAGED OR BY IVY OR DAMAGED OR EXPOSED DURING REMOVAL PROCESS. MORTAR AND

STONE TO MATCH EXISTING ADJACENT MORTAR/ STONE.

- 2. REMOVE EXISTING WINDOWS, FRAMES AND ALL APPURTENANCES. PREPARE EXISTING SURFACES TO RECEIVE NEW SCHEDULED WINDOW ASSEMBLIES. (SEE A2.0 AND A3.0)
- 3. REMOVE EXISTING DOORS & FRAMES AS SHOWN. PREPARE EXISTING SURFACES TO RECEIVE NEW SCHEDULED DOOR/ FRAME ASSEMBLIES. (SEE SHEET A3.1)
- NOT USED
- NOT USED
- 6. REMOVE EXISTING FINISH CEILING AS REQUIRED IN CONSTRUCTION AREAS (ACT GRID OR GWB) AND LIGHT FIXTURES/ DEVICES, TYPICAL. SALVAGE LIGHT FIXTURES AS REQUIRED FOR REINSTALLATION IN OFFICE SPACE AS REQUIRED BY NEW LAYOUT
- 8. REMOVE EXISTING DAMAGED CAST STONE SILL TO BE REPLACED
- 9. MAINTAIN EXISTING SITE SECURITY CAMERAS- LINE IDENTIFY RETAIN LOW VOLTAGE WIRING FOR REINSTALL OF SYSTEM AS REQUIRED.
- CONSTRUCTION, TO BE REPLACED.

10. REMOVE METAL SOFFIT PANELS AND FASCIA, AS REQUIRED BY NEW

GENERAL DEMO NOTES

- REMOVE ALL DEMOLITION DEBRIS FROM SITE IN ACCORDANCE W/ SPECIFICATIONS & APPLICABLE CODES & REGULATIONS.
- LOCATE, IDENTIFY, DISCONNECT AND SEAL OR CAP OFF
- UTILITIES TO BE REMOVED. MAINTAIN EXISTING UTILITIES INDICATED TO REMAIN IN SERVICE AND PROTECT THEM AGAINST DAMAGE.
- REMOVE EXISTING MATERIALS AS SHOWN AND, IF NOT SHOWN AS REQUIRED TO ACCOMMODATE THE NEW WORK. INCLUDING ALL MEP ITEMS THAT INTERFERE WITH THE NEW LAYOUT.
- THE OWNER WILL OCCUPY PORTIONS OF THE BUILDING ADJACENT TO SELECTIVE DEMOLITION AREA. CONDUCT SELECTIVE DEMOLITION SO OWNER'S OPERATIONS WILL NOT BE
- PROMPTLY NOTIFY THE BUILDING OWNER AND ARCHITECT PRIOR TO THE REMOVAL OR MODIFICATION OF ANY STRUCTURAL ELEMENT.
- TAKE DOWN EXISTING WORK IN THE REVERSE ORDER OF CONSTRUCTION. DO NOT KNOCK DOWN OR UNDERMINE THE WORK IN WAYS THAT WILL CAUSE IT TO FALL.
- PROVIDE SHORING, BRACING AND SUPPORTS AS REQUIRED TO PRESERVE STABILITY AND PREVENT MOVEMENT, SETTLEMENT OR COLLAPSE OF CONSTRUCTION. PROTECT CONSTRUCTION INDICATED TO REMAIN.
- ANY AREA OUTSIDE THE LIMIT OF CONTRACT DISTRIBUTED BY DEMOLITION SHALL BE RESTORED AT THE CONTRACTORS
- ERECT AND MAINTAIN DUST BARRIERS TO OCCUPIED AREAS PROTECT ALL AREAS FROM THE WEATHER AT ALL TIMES.
- PROMPTLY REMOVE FROM THE SITE AND LEGALLY DISPOSE OF ALL DEBRIS AND RUBBISH. THERE IS POSSIBILITY THAT HAZARDOUS MATERIALS MAY BE
- DISCOVERED ON THIS PROJECT. IF MATERIALS SUSPECTED TO BE HAZARDOUS ARE ENCOUNTERED DO NOT DISTURB THEM. THE CONTRACTOR SHALL PROMPTLY INFORM THE ARCHITECT AND OWNER OF THE PRESENCE OF SUCH MATERIALS THE OWNER WILL REMOVE HAZARDOUS MATERIAL UNDER A SEPARATE CONTRACT.
- COMPLY WITH REGULATIONS TO PROTECT WORKERS EXPOSED TO HAZARDOUS MATERIAL.

REQUIRING ASBESTOS ABATEMENT SHALL BE DEDUCTED FROM

- DISPOSE OF HAZARDOUS MATERIAL PROPERLY ACCORDING TO GOVERNING LOCAL STATE AND NATIONAL REQUIREMENT. SOME EXISTING FINISHES MAY CONTAIN ASBESTOS, ANY ELEMENTS CONFIRMED BY THE ASBESTOS REPORT TO BE HAZARDOUS SHALL BE ABATED BY A CERTIFIED ASBESTOS ABATEMENT CONTRACTOR PRIOR TO DEMOLITION, ELEMENT
- THE GENERAL CONTRACTOR BASE BID. GC TO COORDINATE WITH THE OWNER FOR A FINAL ASBESTOS REPORT AFTER ALL ASBESTOS CONTAINING MATERIALS ARE ABATED.



REVISIONS

REVISIONS

PROJECT COORDINATOR: KYLE O'CONNOR, RLA LEED GREEN ASSOCIATE



SEILER + DRURY

ARCHITECTURE

420 DEKALB STREET NORRISTOWN PA 19401 Tel 610.272.4809 www.sdarc.com

SPACE FOR CONSULTANT RECOGNITION

CITY OF PHILADELPHIA DEPARTMENT OF PUBLIC PROPERTY

CAPITAL PROJECTS DIVISION 1400 JFK BLVD 7TH FLR CITY HALL

PROJECT TITLE

PHILADELPHIA ZOOLOGICAL GARDENS -SHELLY ADMINISTRATION BUILDING- WINDOW TREATMENTS


DRAWING TITLE


SHELLY ADMINISTRATION BUILDING

DEMOLITION-EXTERIOR ELEVATIONS

PROJECT NO. DRAWING NO. 2424 12-16-2024 SCALE AS INDICATED CHECKED BY

ALL DIMENSIONS AND CONDITIONS SHALL BE VERIFIED BY THE CONTRACTOR AT THE SITE BEFORE PROCEEDING WITH THE WORK.

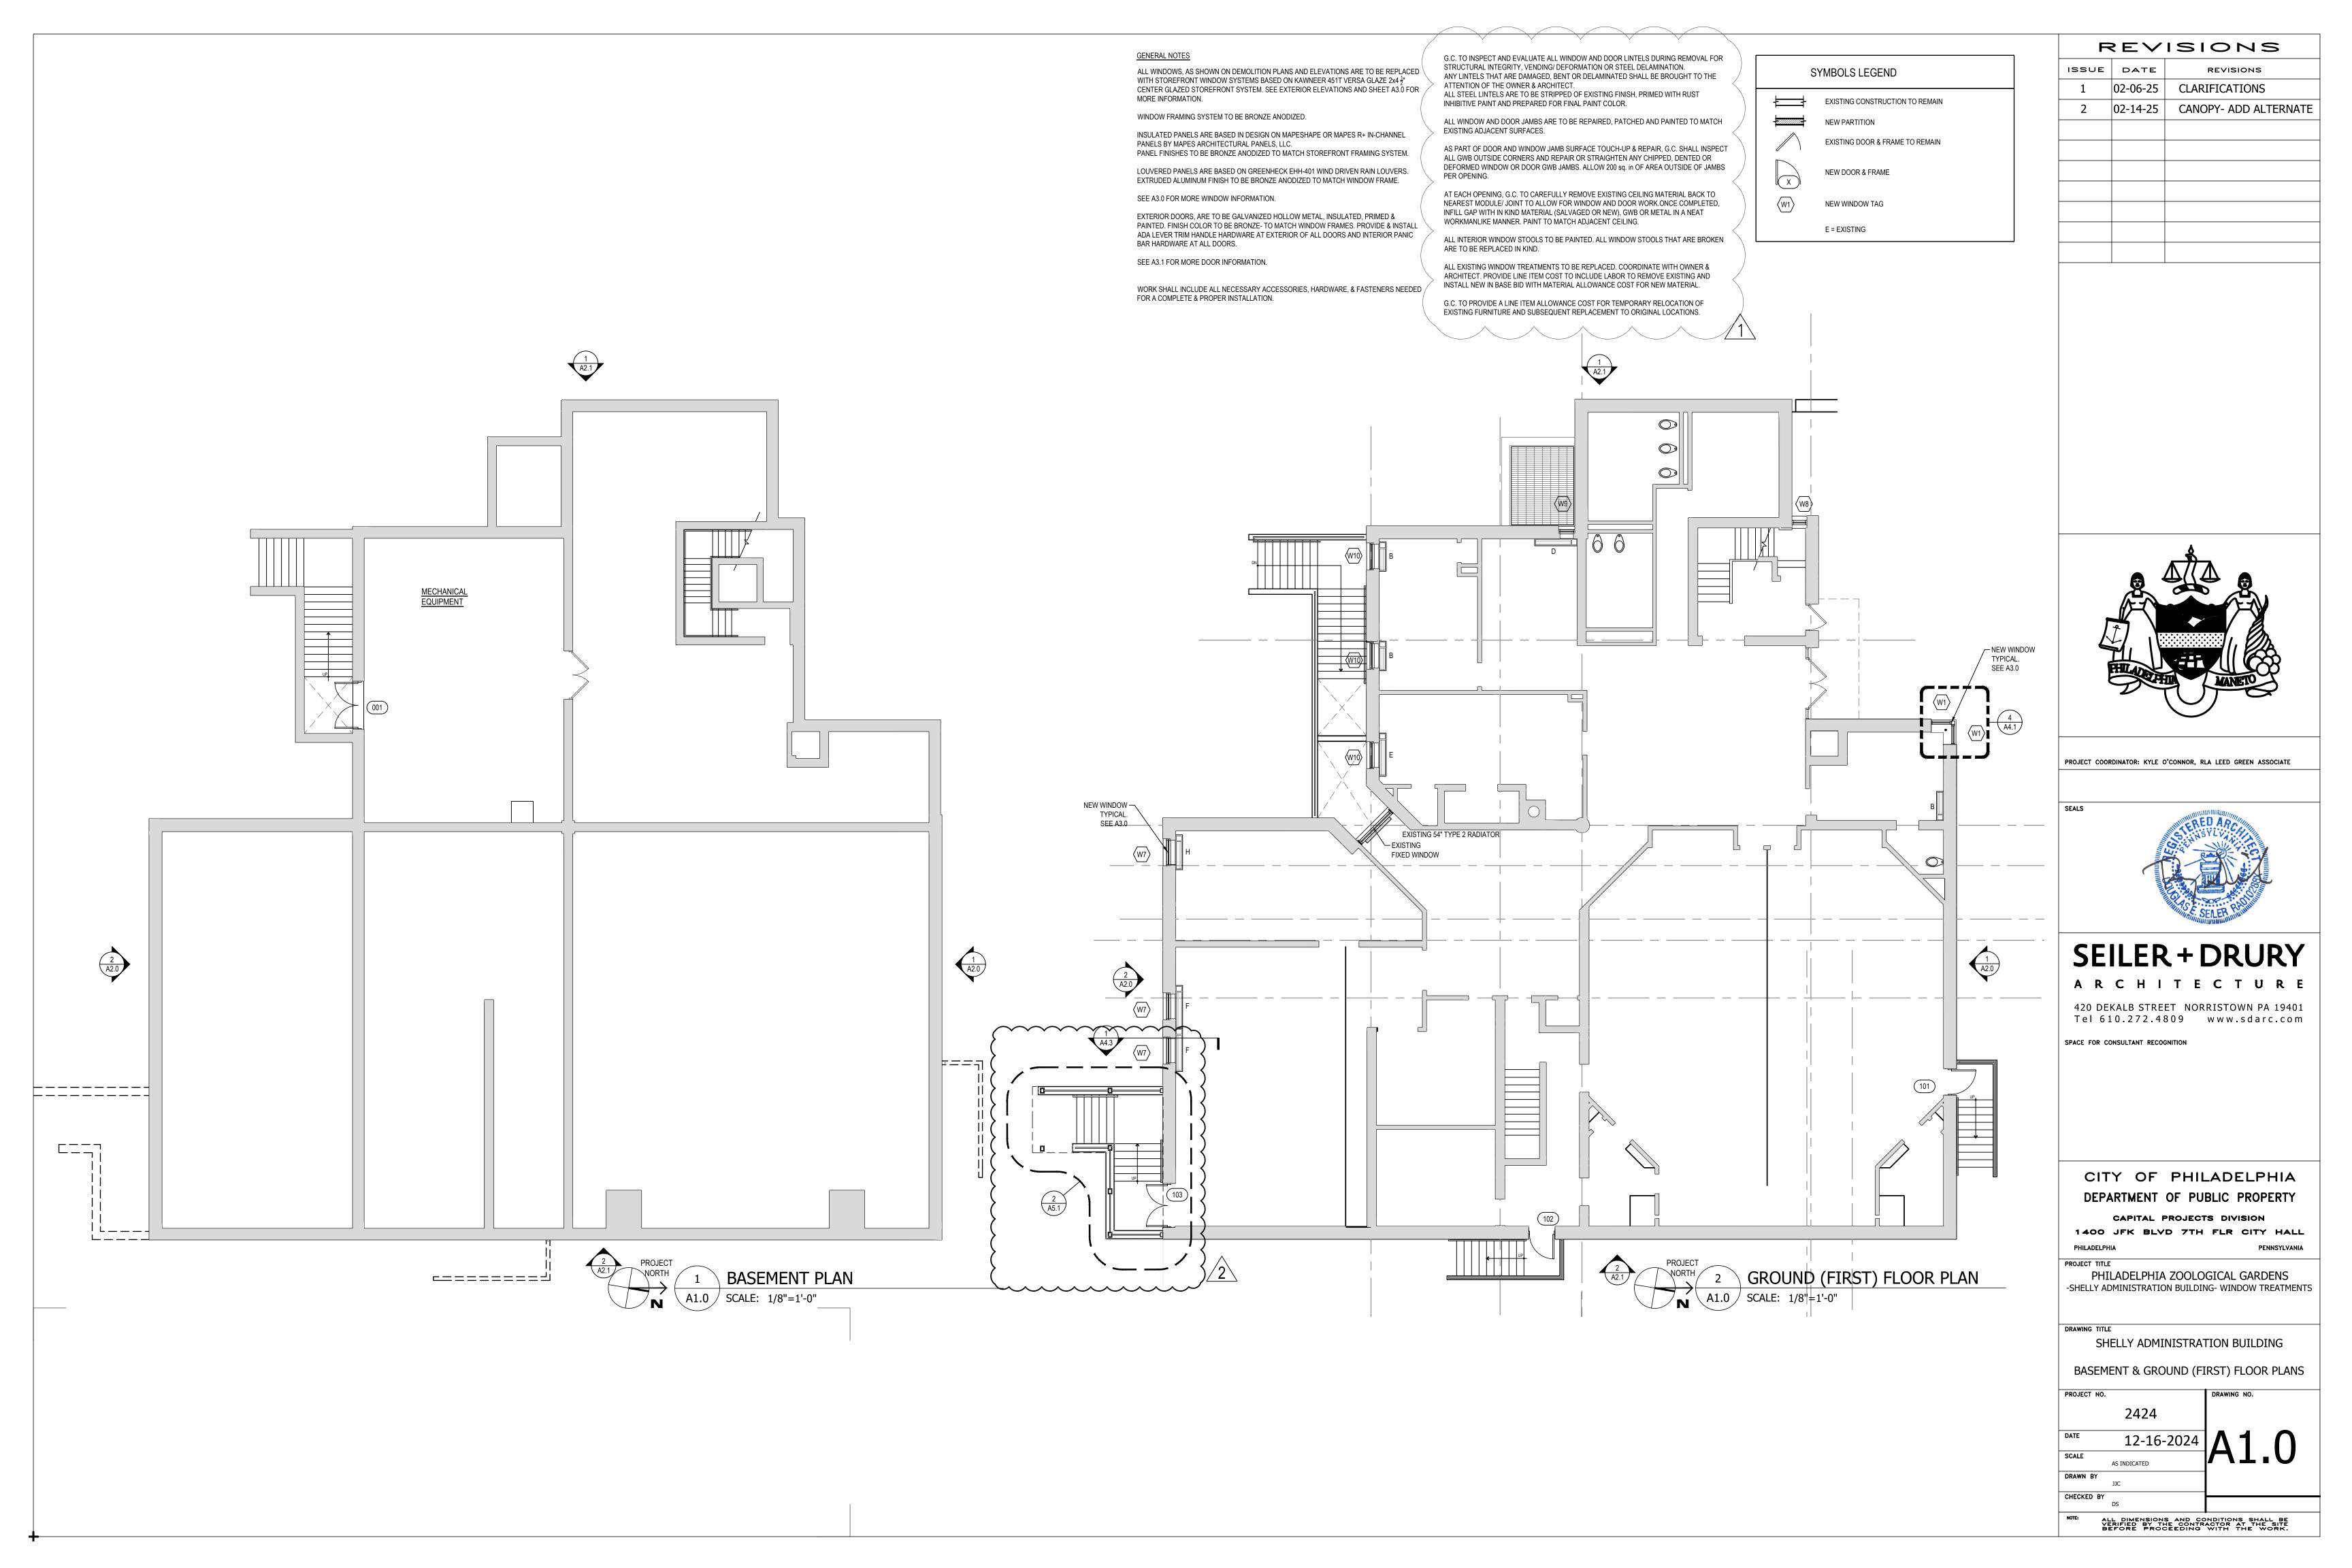

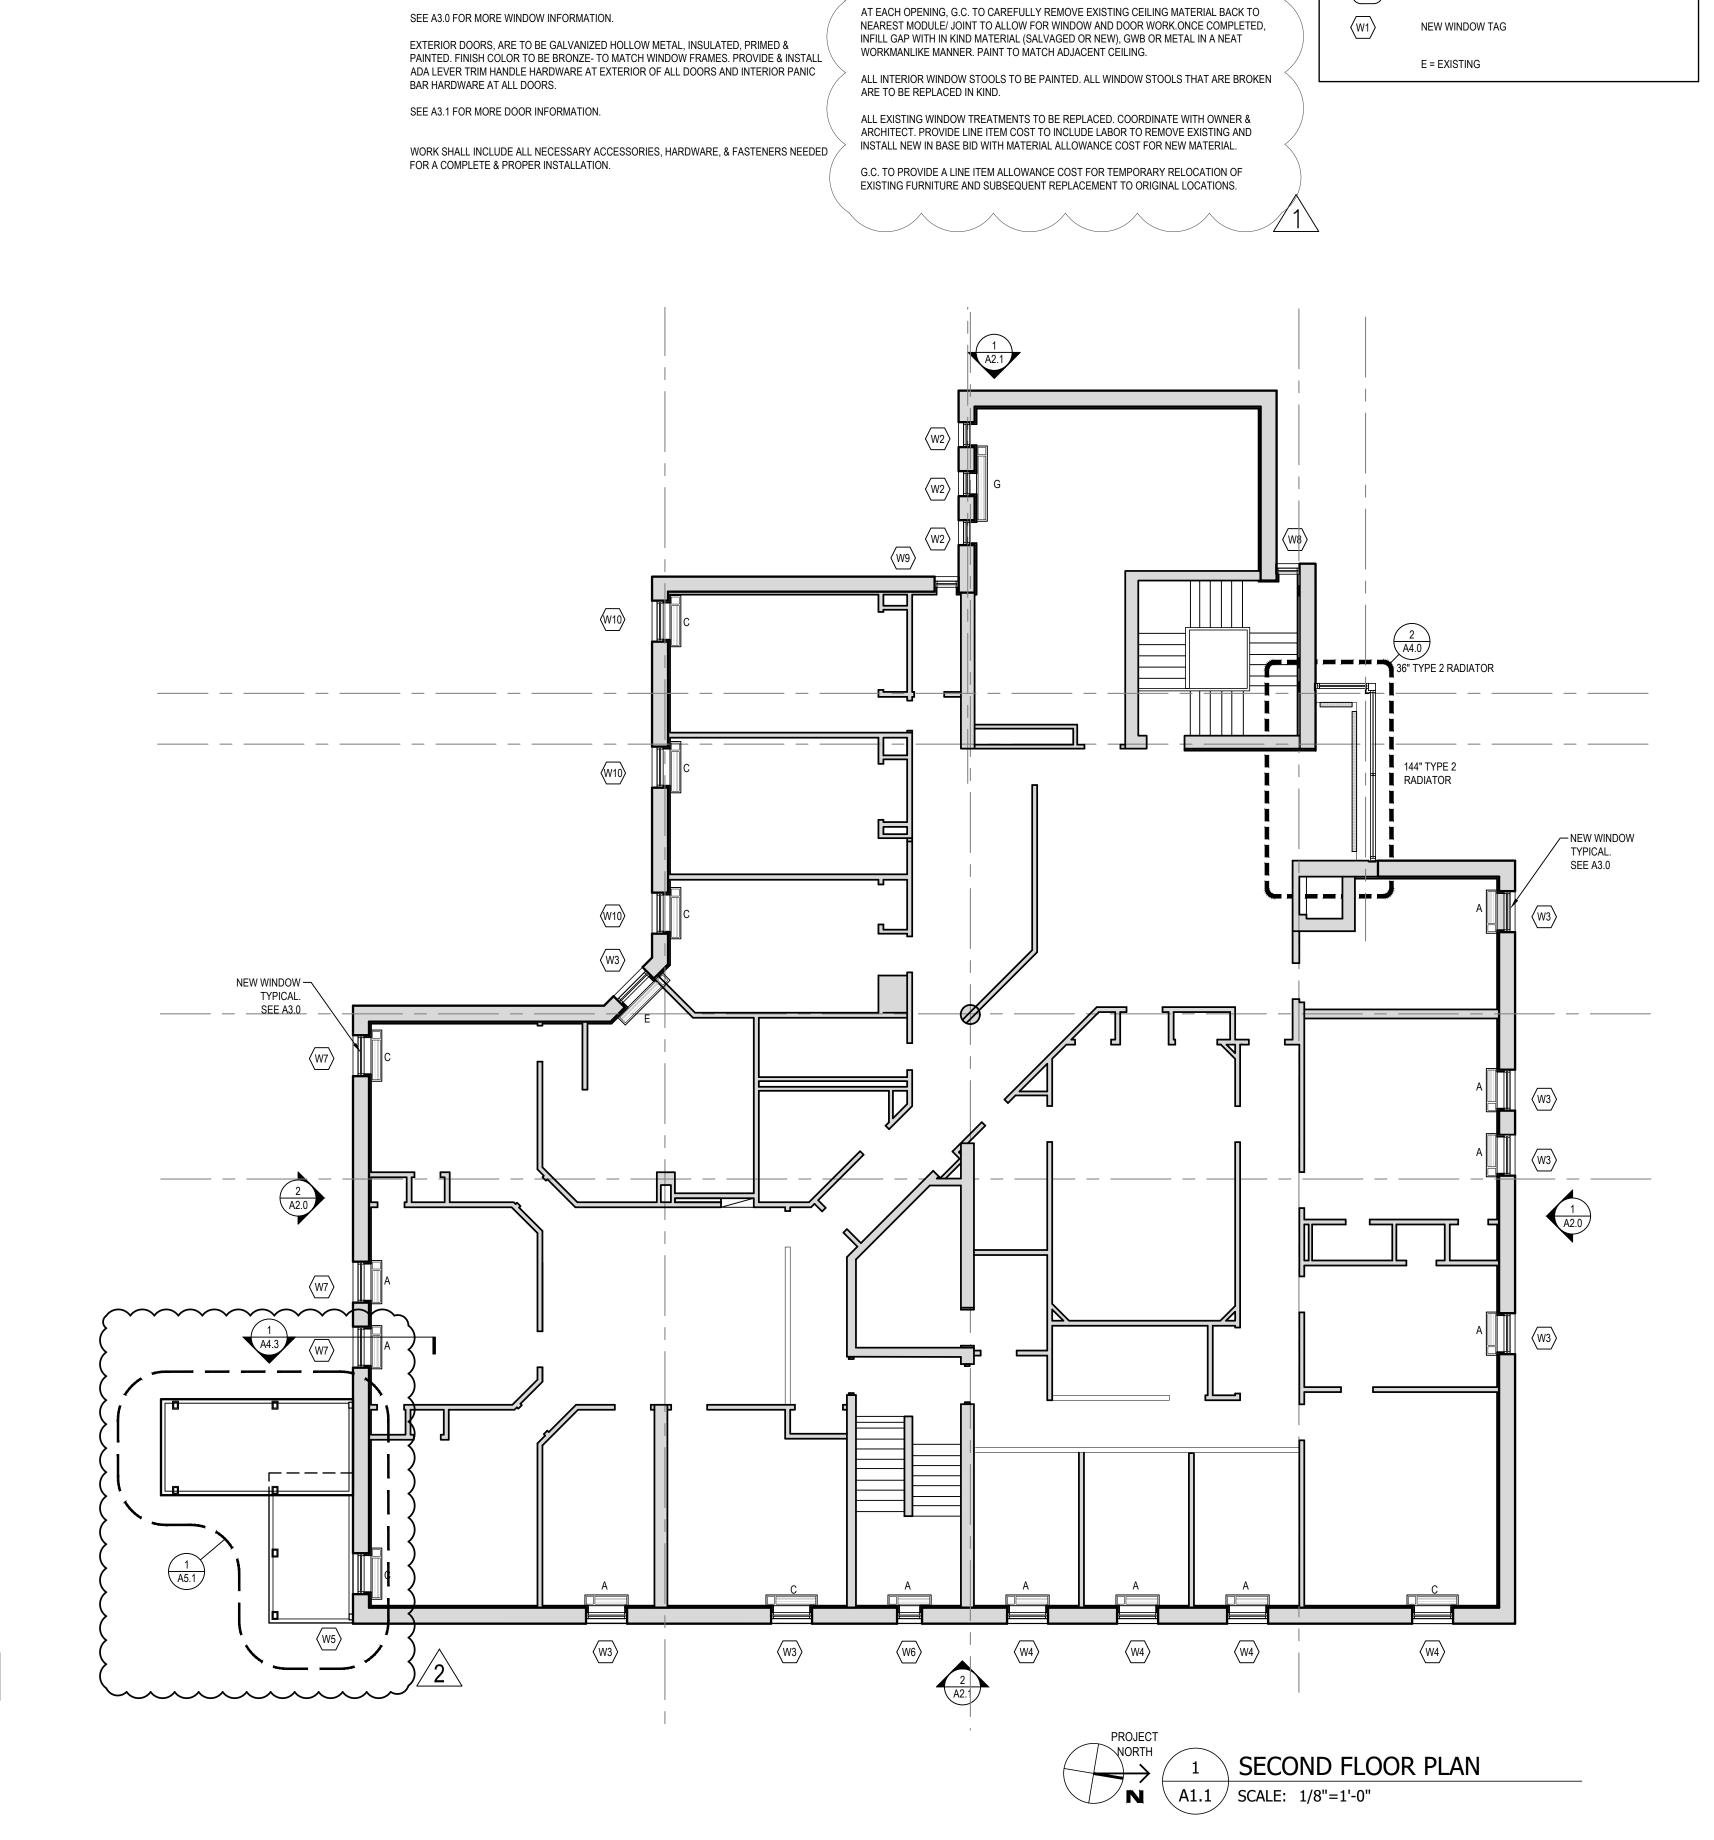

G.C. TO INSPECT AND EVALUATE ALL WINDOW AND DOOR LINTELS DURING REMOVAL FOR

ANY LINTELS THAT ARE DAMAGED, BENT OR DELAMINATED SHALL BE BROUGHT TO THE

ALL WINDOW AND DOOR JAMBS ARE TO BE REPAIRED, PATCHED AND PAINTED TO MATCH

AS PART OF DOOR AND WINDOW JAMB SURFACE TOUCH-UP & REPAIR, G.C. SHALL INSPECT

ALL GWB OUTSIDE CORNERS AND REPAIR OR STRAIGHTEN ANY CHIPPED, DENTED OR DEFORMED WINDOW OR DOOR GWB JAMBS. ALLOW 200 sq. in OF AREA OUTSIDE OF JAMBS

ALL STEEL LINTELS ARE TO BE STRIPPED OF EXISTING FINISH, PRIMED WITH RUST

SYMBOLS LEGEND

EXISTING CONSTRUCTION TO REMAIN

NEW DOOR & FRAME

EXISTING DOOR & FRAME TO REMAIN

NEW PARTITION

STRUCTURAL INTEGRITY, VENDING/ DEFORMATION OR STEEL DELAMINATION.

ATTENTION OF THE OWNER & ARCHITECT.

EXISTING ADJACENT SURFACES.

INHIBITIVE PAINT AND PREPARED FOR FINAL PAINT COLOR.

GENERAL NOTES

MORE INFORMATION.

WINDOW FRAMING SYSTEM TO BE BRONZE ANODIZED.

PANELS BY MAPES ARCHITECTURAL PANELS, LLC.

ALL WINDOWS, AS SHOWN ON DEMOLITION PLANS AND ELEVATIONS ARE TO BE REPLACED

CENTER GLAZED STOREFRONT SYSTEM. SEE EXTERIOR ELEVATIONS AND SHEET A3.0 FOR


WITH STOREFRONT WINDOW SYSTEMS BASED ON KAWNEER 451T VERSA GLAZE 2x4 2"

INSULATED PANELS ARE BASED IN DESIGN ON MAPESHAPE OR MAPES R+ IN-CHANNEL

PANEL FINISHES TO BE BRONZE ANODIZED TO MATCH STOREFRONT FRAMING SYSTEM.


LOUVERED PANELS ARE BASED ON GREENHECK EHH-401 WIND DRIVEN RAIN LOUVERS.

EXTRUDED ALUMINUM FINISH TO BE BRONZE ANODIZED TO MATCH WINDOW FRAME.

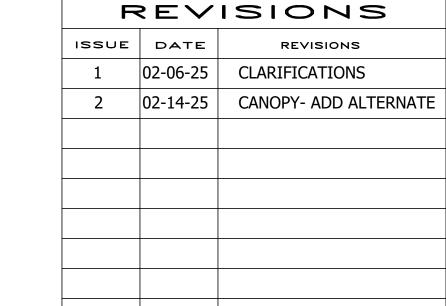



PROJECT COORDINATOR: KYLE O'CONNOR, RLA LEED GREEN ASSOCIATE

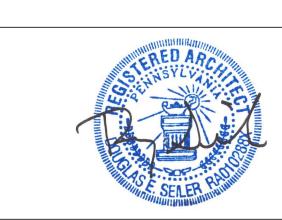

SEILER + DRURY

A R C H I T E C T U R E

420 DEKALB STREET NORRISTOWN PA 19401
Tel 610.272.4809 www.sdarc.com

SPACE FOR CONSULTANT RECOGNITION

CITY OF PHILADELPHIA DEPARTMENT OF PUBLIC PROPERTY

CAPITAL PROJECTS DIVISION

1400 JFK BLVD 7TH FLR CITY HALL

PHILADELPHIA PENNSYLVANIA

PROJECT TITLE
PHILADELPHIA ZOOLOGICAL GARDENS
-SHELLY ADMINISTRATION BUILDING- WINDOW TREATMENTS

DRAWING TITLE

SHELLY ADMINISTRATION BUILDING

SECOND FLOOR PLAN AND PLAN DETAIL

PROJECT NO. 2424

DATE 12-16


SCALE AS INDICATED


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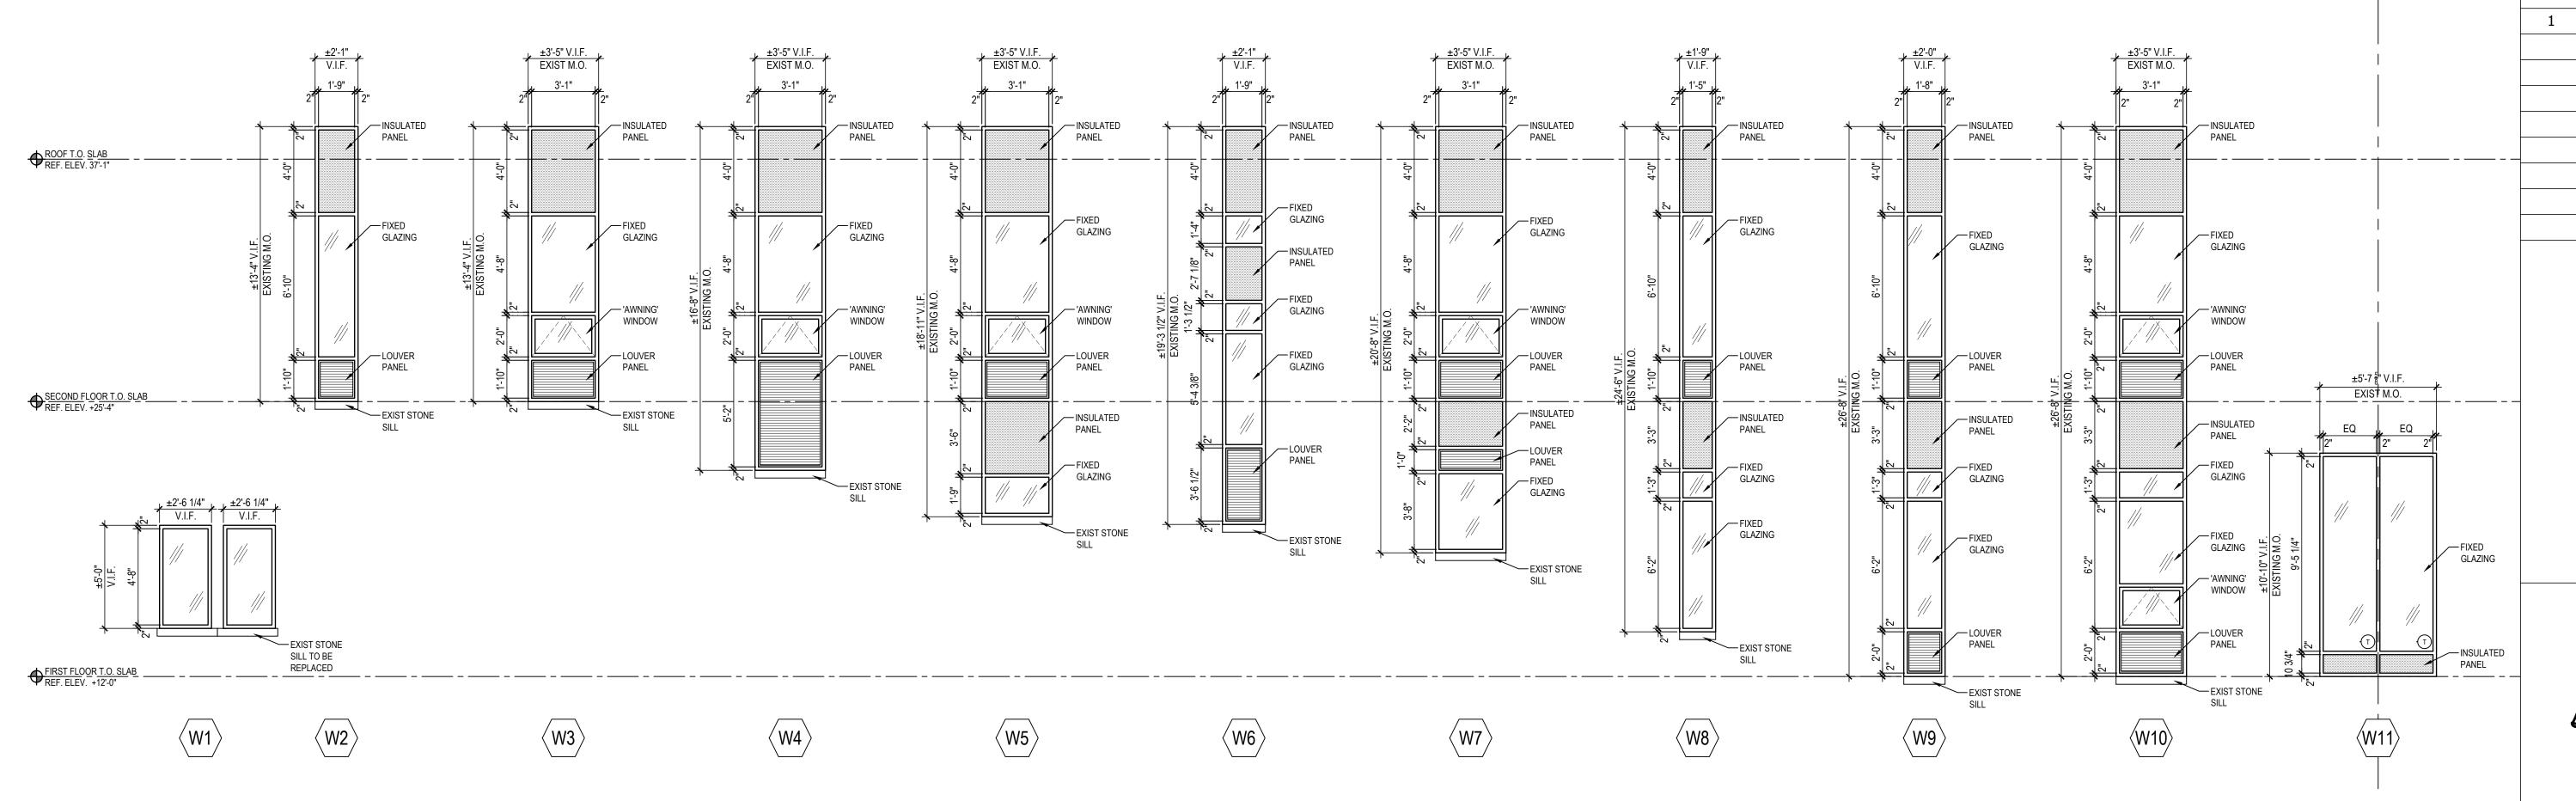
JJC

CHECKED BY

ALL DIMENSIONS AND CONDITIONS SHALL BE VERIFIED BY THE CONTRACTOR AT THE SITE BEFORE PROCEEDING WITH THE WORK.



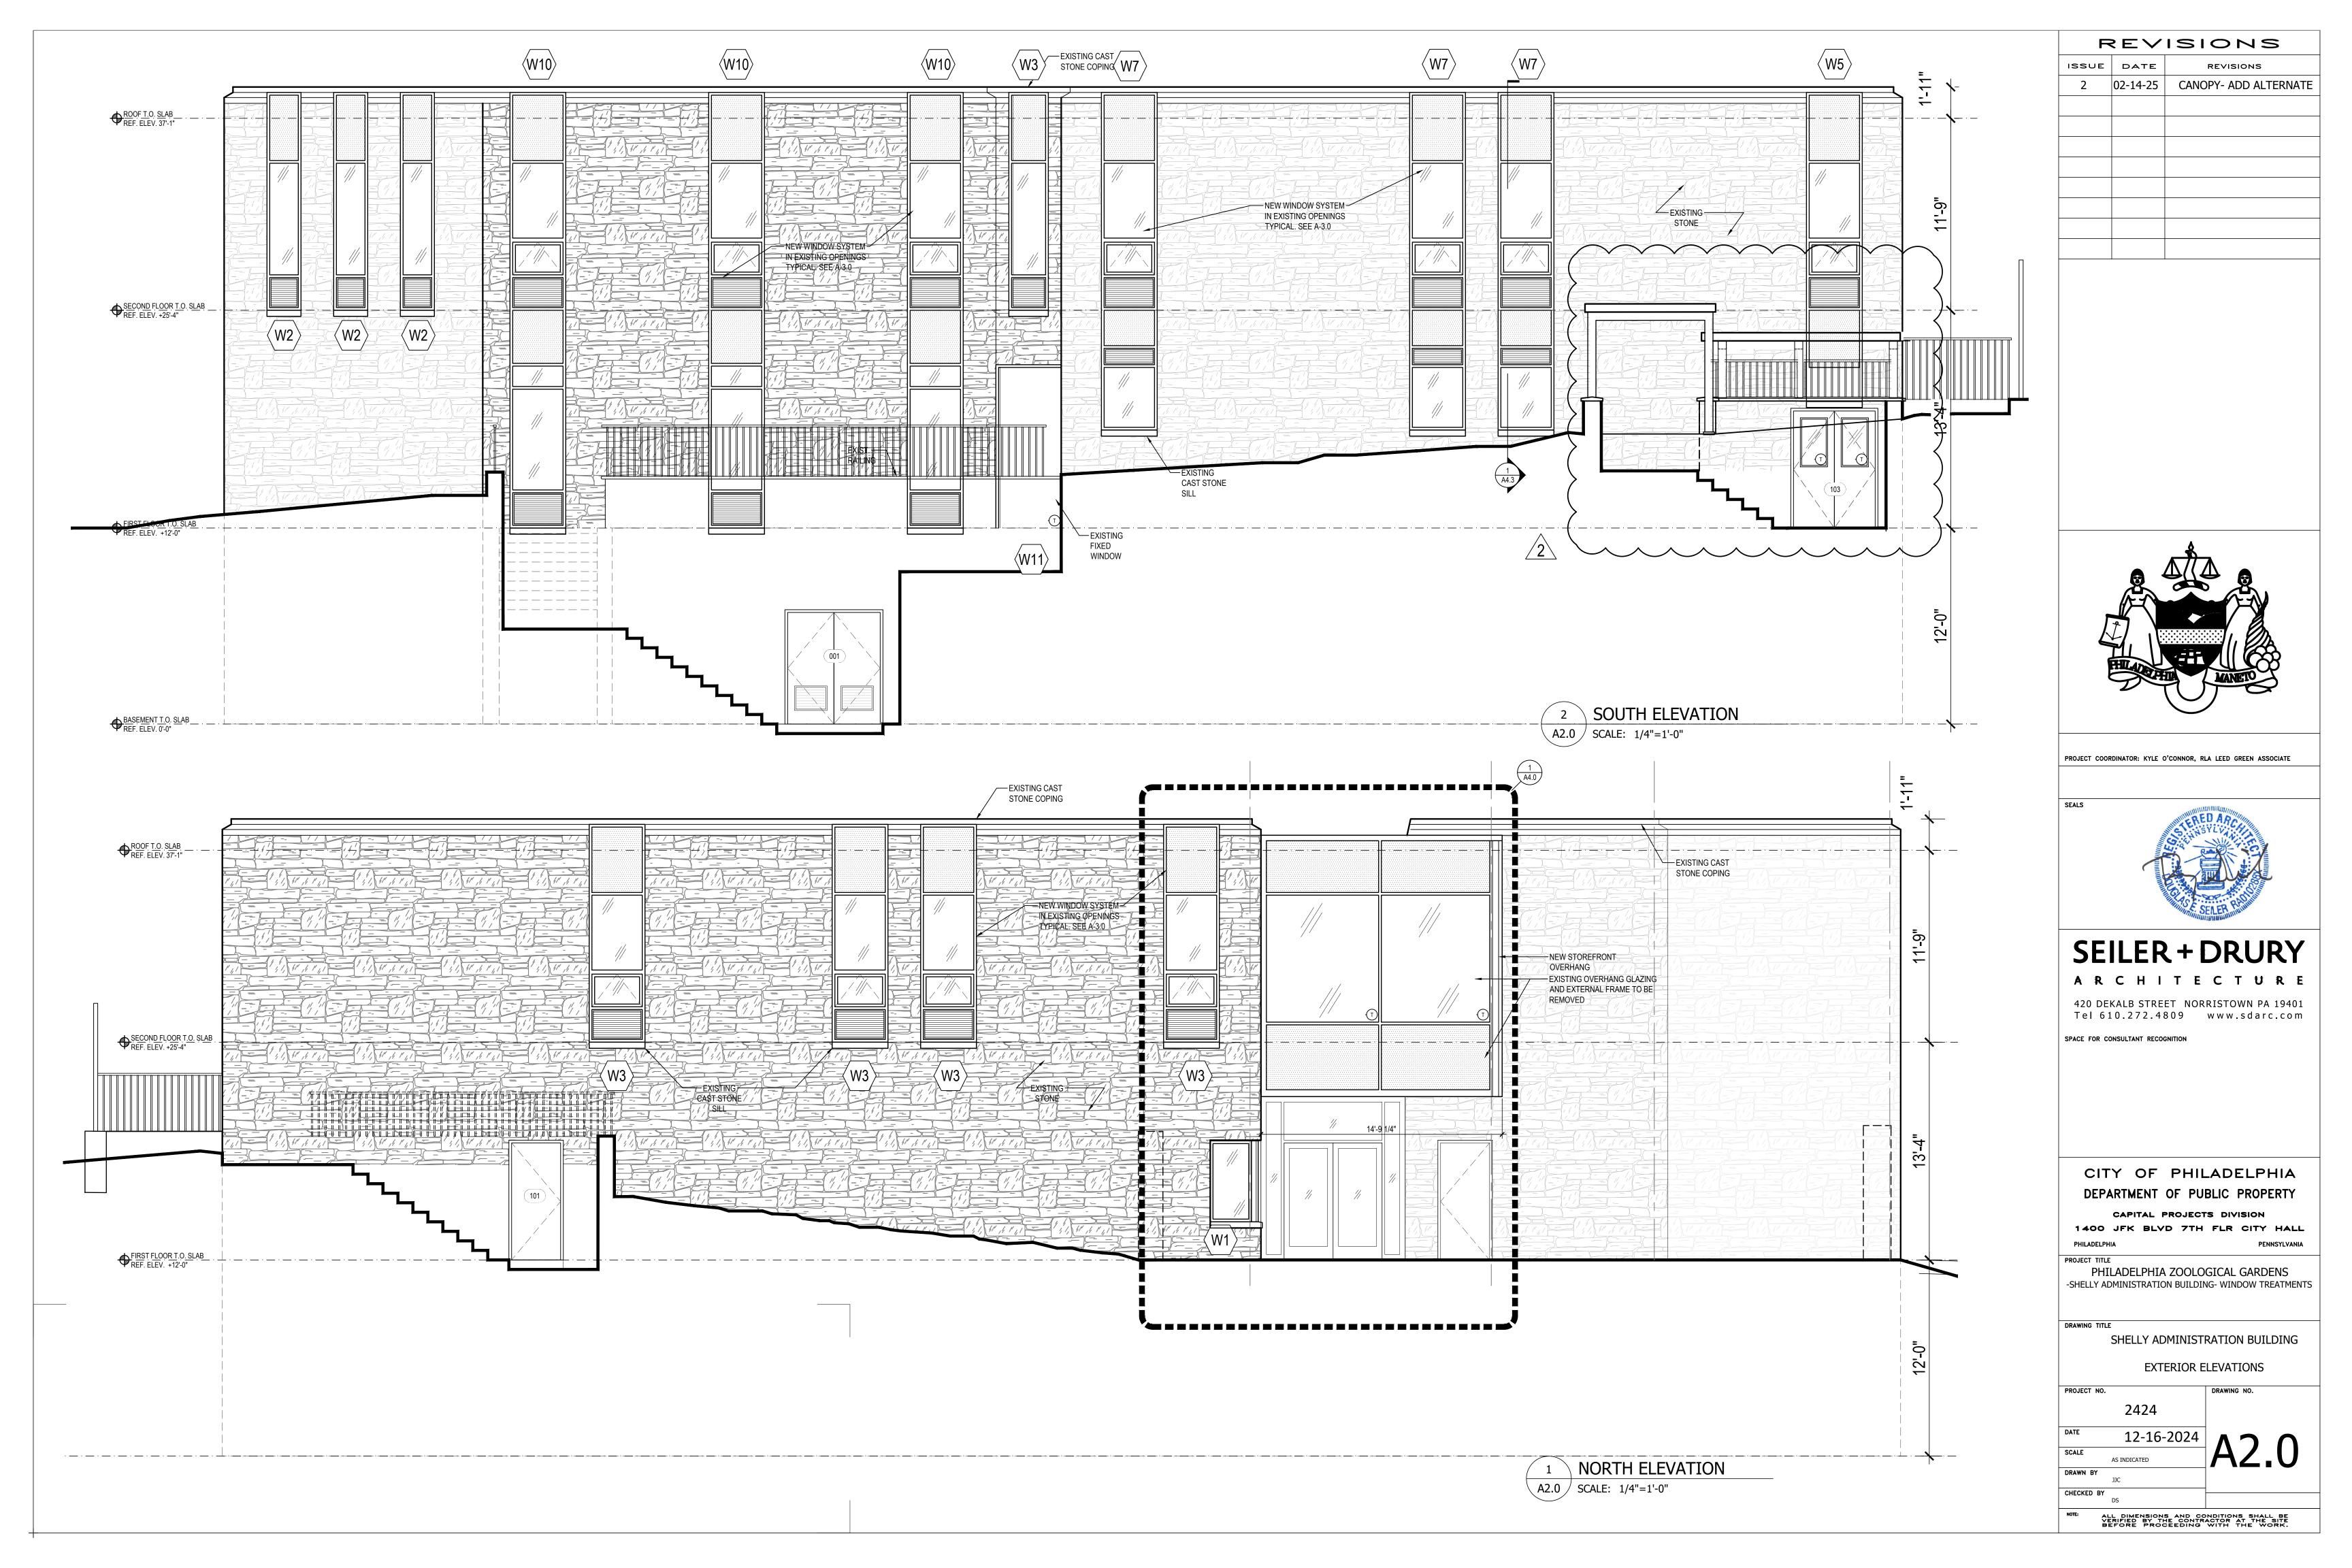

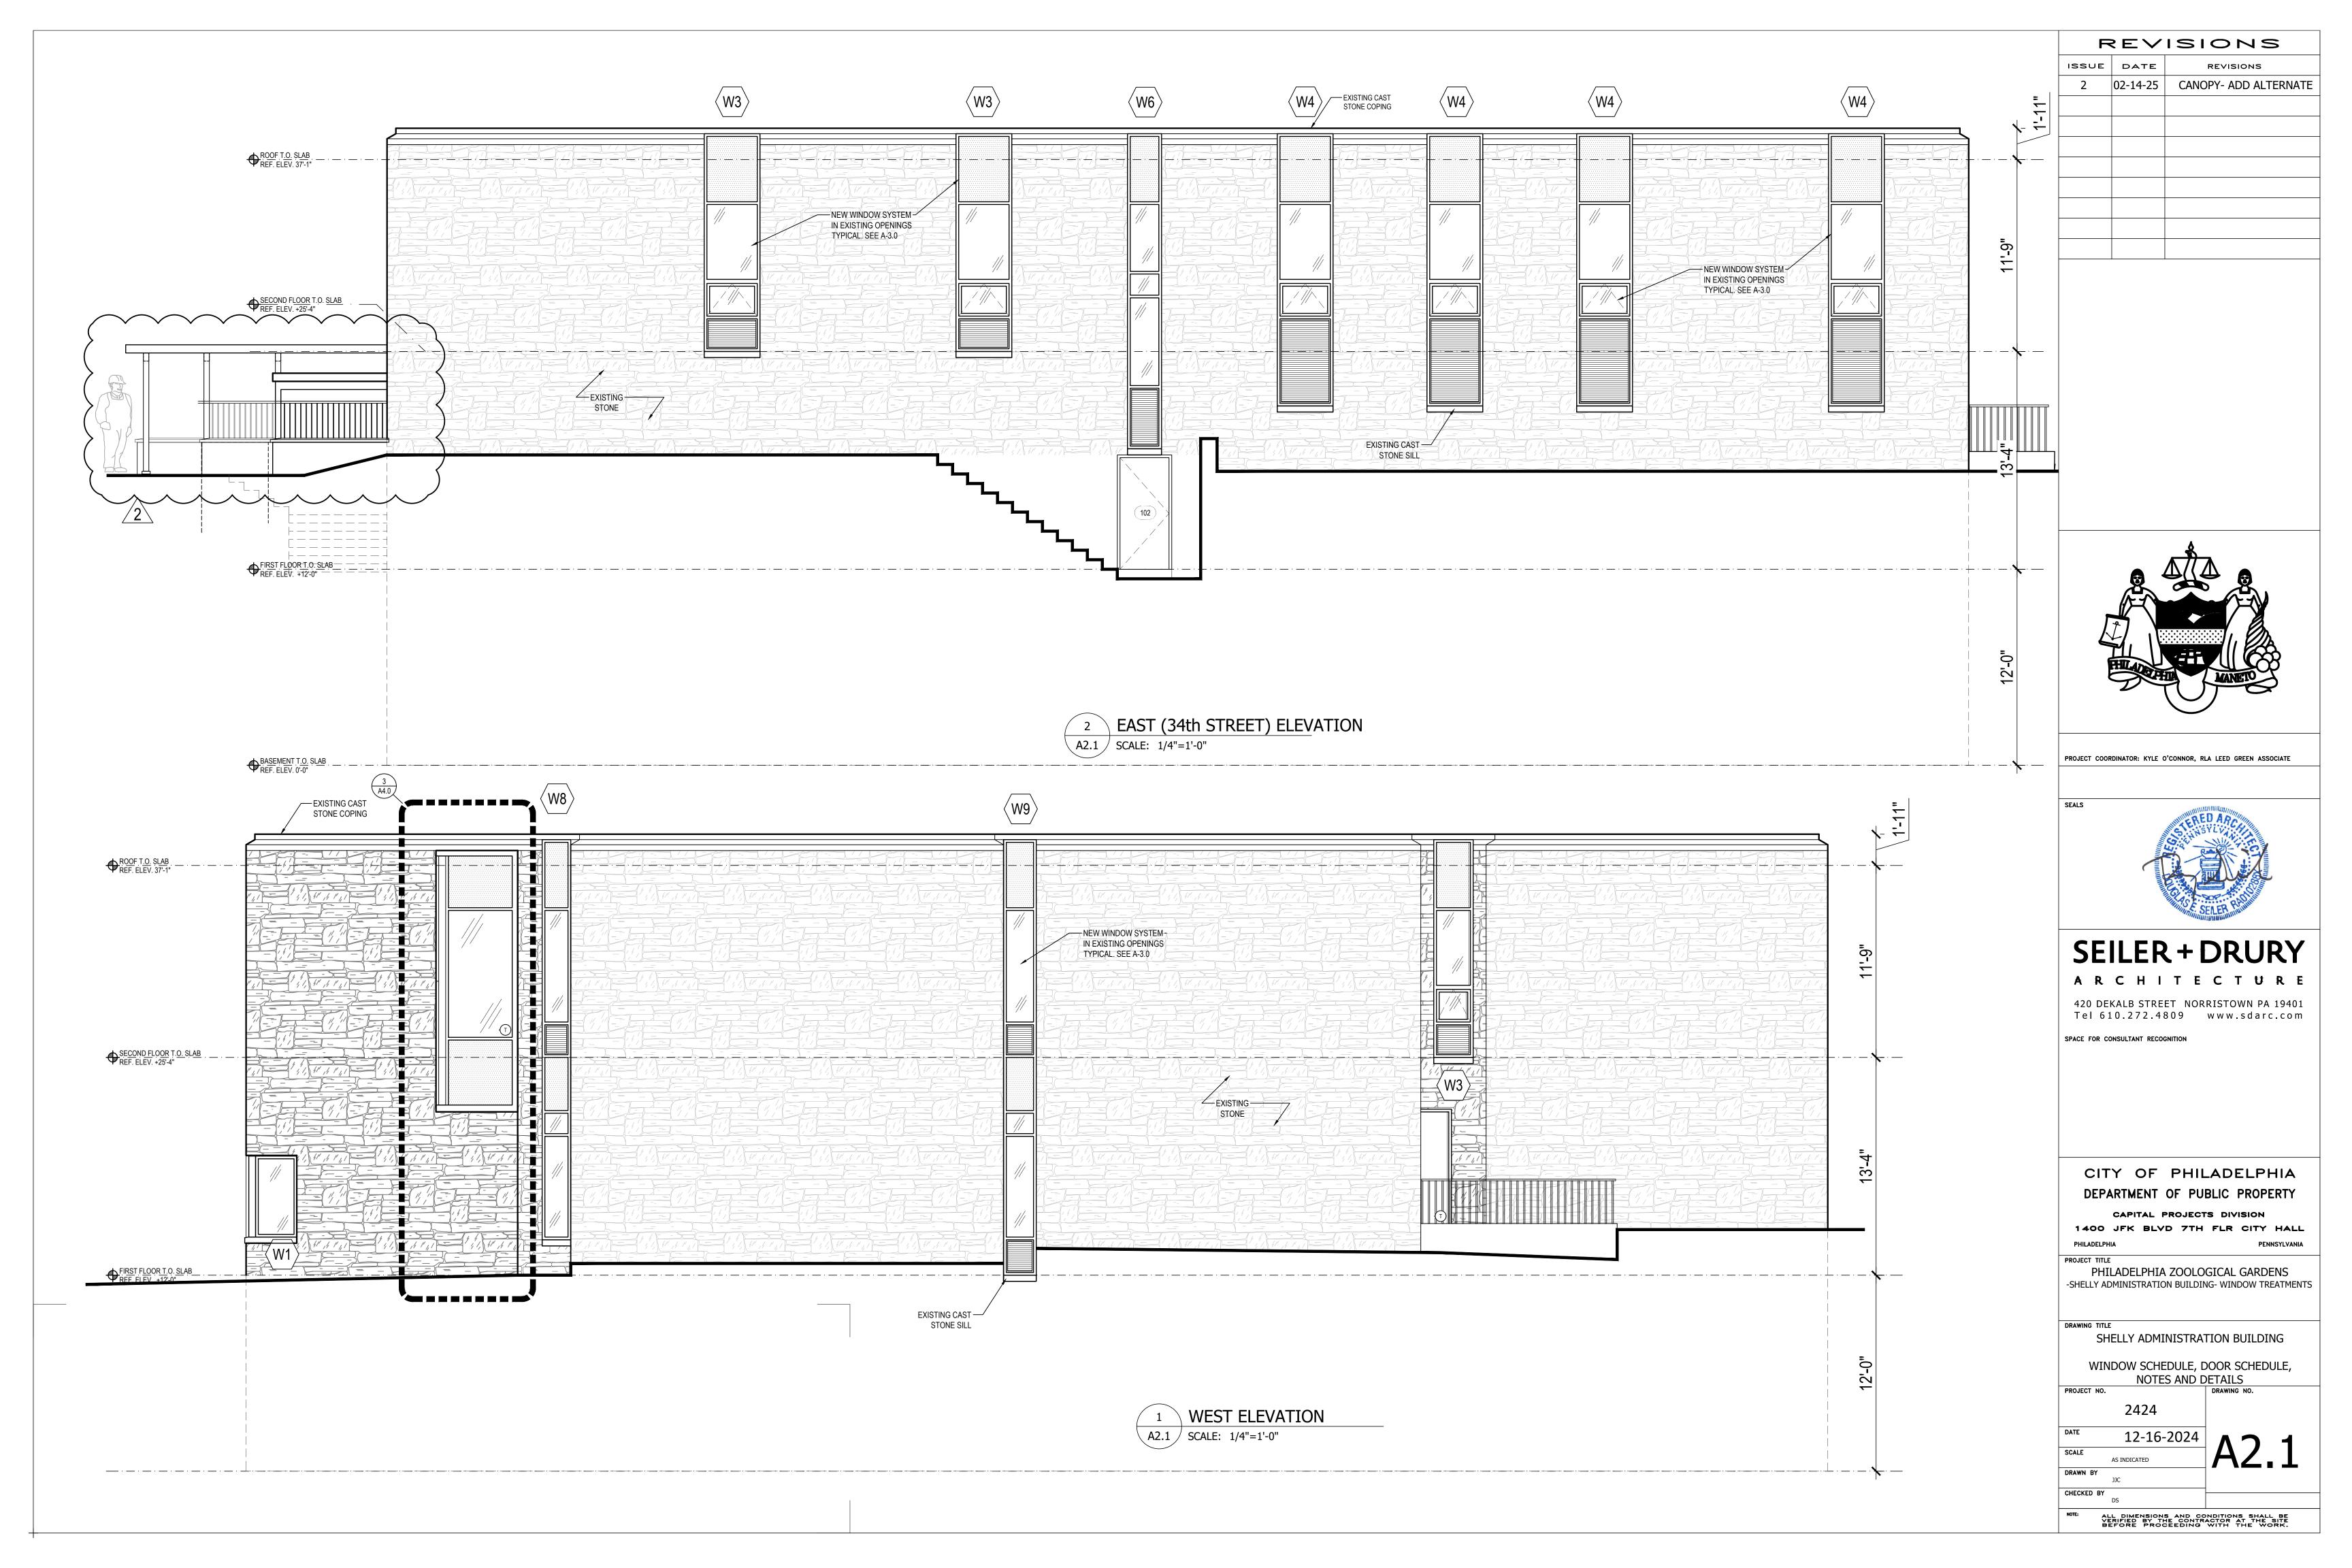

REVISIONS

02-06-25

REVISIONS

CLARIFICATIONS

DOOR & WINDOW GENERAL NOTES

G.C. TO INSPECT AND EVALUATE ALL WINDOW AND DOOR LINTELS DURING REMOVAL FOR STRUCTURAL INTEGRITY, VENDING/ DEFORMATION OR STEEL

ANY LINTELS THAT ARE DAMAGED, BENT OR DELAMINATED SHALL BE BROUGHT TO THE ATTENTION OF THE OWNER & ARCHITECT. ALL STEEL LINTELS ARE TO BE STRIPPED OF EXISTING FINISH, PRIMED WITH RUST INHIBITIVE PAINT AND PREPARED FOR FINAL PAINT COLOR.

ALL WINDOW AND DOOR JAMBS ARE TO BE REPAIRED, PATCHED AND PAINTED TO MATCH EXISTING ADJACENT SURFACES.

AS PART OF DOOR AND WINDOW JAMB SURFACE TOUCH-UP & REPAIR, G.C. SHALL INSPECT ALL GWB OUTSIDE CORNERS AND REPAIR OR STRAIGHTEN ANY CHIPPED, DENTED OR DEFORMED WINDOW OR DOOR GWB JAMBS. ALLOW 200 sq. in OF AREA OUTSIDE OF JAMBS PER OPENING.

AT EACH OPENING, G.C. TO CAREFULLY REMOVE EXISTING CEILING MATERIAL BACK TO NEAREST MODULE/ JOINT TO ALLOW FOR WINDOW AND DOOR WORK.ONCE COMPLETED, INFILL GAP WITH IN KIND MATERIAL (SALVAGED OR NEW), GWB OR METAL IN A NEAT WORKMANLIKE MANNER. PAINT TO MATCH ADJACENT CEILING.

ALL INTERIOR WINDOW STOOLS TO BE PAINTED. ALL WINDOW STOOLS THAT ARE BROKEN ARE TO BE REPLACED IN KIND.

ALL EXISTING WINDOW TREATMENTS TO BE REPLACED. COORDINATE WITH OWNER & ARCHITECT. PROVIDE LINE ITEM COST TO INCLUDE LABOR TO REMOVE EXISTING AND INSTALL NEW IN BASE BID WITH MATERIAL ALLOWANCE COST FOR

G.C. TO PROVIDE A LINE ITEM ALLOWANCE COST FOR TEMPORARY RELOCATION OF EXISTING FURNITURE AND SUBSEQUENT REPLACEMENT TO ORIGINAL

WINDOW SCHEDULE A3.0 \int SCALE: 1/4"=1'-0"

						WINDO\	N SCH	EDULI	E		
NO.	MANUF.	SERIES	SERIES MAT.	OPERATION	FIN.	GLASS	SIZ	Æ	MISC NOTES	QUANTITY	COMMENTS
110.	107/11401	OLIVILO		OF ETATION	i iiv.	OLAGO	WIDTH	HEIGHT	WIIOO NOTEO	QOANTITI	
W1	KAWNEER	451T	ALUM	FIXED	ANOD.	DOUBLE PANE LOW-E	(2) 2'-6 1/4"	5'-0"	VERIFY ALL SIZES IN FIELD	1	BRONZE ANODIZED
W2	KAWNEER	451T	ALUM	FIXED	ANOD.	DOUBLE PANE LOW-E	2'-1"	13'-4"	VERIFY ALL SIZES IN FIELD	3	BRONZE ANODIZED
W3	KAWNEER	451T	ALUM	FIXED/ CASEMENT	ANOD.	DOUBLE PANE LOW-E	3'-5"	13'-4"	VERIFY ALL SIZES IN FIELD	7	BRONZE ANODIZED
W4	KAWNEER	451T	ALUM	FIXED/ CASEMENT	ANOD.	DOUBLE PANE LOW-E	3'-5"	16'-8"	VERIFY ALL SIZES IN FIELD	4	BRONZE ANODIZED
W5	KAWNEER	451T	ALUM	FIXED/ CASEMENT	ANOD.	DOUBLE PANE LOW-E	3'-5"	18'-11"	VERIFY ALL SIZES IN FIELD	1	BRONZE ANODIZED
W6	KAWNEER	451T	ALUM	FIXED	ANOD.	DOUBLE PANE LOW-E	2'-1"	19'-4"	VERIFY ALL SIZES IN FIELD	1	BRONZE ANODIZED
W7	KAWNEER	451T	ALUM	FIXED/ CASEMENT	ANOD.	DOUBLE PANE LOW-E	3'-5"	20'-8"	VERIFY ALL SIZES IN FIELD	3	BRONZE ANODIZED
W8	KAWNEER	451T	ALUM	FIXED	ANOD.	DOUBLE PANE LOW-E	1'-9"	24'-6"	VERIFY ALL SIZES IN FIELD	1	BRONZE ANODIZED
W9	KAWNEER	451T	ALUM	FIXED	ANOD.	DOUBLE PANE LOW-E	2'-0''	26'-8"	VERIFY ALL SIZES IN FIELD	1	BRONZE ANODIZED
W10	KAWNEER	451T	ALUM	FIXED/ CASEMENT	ANOD.	DOUBLE PANE LOW-E	3'-5"	26'-8"	VERIFY ALL SIZES IN FIELD	3	BRONZE ANODIZED
W11	KAWNEER	451T	ALUM	FIXED	ANOD.	DOUBLE PANE LOW-E	5'-7" 5/8"	10'-10"	VERIFY ALL SIZES IN FIELD	1	BRONZE ANODIZED

NOTES: ALL GLAZING TO HAVE ANTI BIRD STRIKE FILM OR DECALS. SOLYX BIRD SAFETY WINDOW FILMS OR EQUAL. FINAL PATTERN AS SELECTED BY OWNER. KAWNEER 451T VERSA GLAZE CENTER GLAZE

ALL WINDOWS, AS SHOWN ON DEMOLITION PLANS AND ELEVATIONS ARE TO BE REPLACED WITH STOREFRONT WINDOW SYSTEMS BASED ON KAWNEER 451T VERSA GLAZE 2x4 ½" CENTER GLAZED STOREFRONT SYSTEM. SEE EXTERIOR ELEVATIONS AND THIS SHEET FOR MORE INFORMATION.

WINDOW FRAMING SYSTEM TO BE BRONZE ANODIZED.

GC TO OBTAIN COLOR SAMPLES OF ALL WINDOW COMPONENTS FOR COLOR COORDINATION AND APPROVAL.

INSULATED PANELS ARE BASED IN DESIGN ON MAPESHAPE OR MAPES R+ IN-CHANNEL PANELS BY MAPES ARCHITECTURAL PANELS, LLC.

LOUVERED PANELS ARE BASED ON GREENHECK EHH-401 WIND DRIVEN RAIN LOUVERS. EXTRUDED ALUMINUM FINISH TO BE BRONZE TO MATCH WINDOW FRAME.

WORK SHALL INCLUDE ALL NECESSARY ACCESSORIES, HARDWARE, & FASTENERS NEEDED FOR A COMPLETE & PROPER INSTALLATION.



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CAPITAL PROJECTS DIVISION

1400 JFK BLVD 7TH FLR CITY HALL

PHILADELPHIA ZOOLOGICAL GARDENS -SHELLY ADMINISTRATION BUILDING- WINDOW TREATMENTS

SHELLY ADMINISTRATION BUILDING

WINDOW SCHEDULE, DOOR SCHEDULE, NOTES AND DETAILS

PROJECT NO. 2424

12-16-2024 SCALE

AS INDICATED

ALL DIMENSIONS AND CONDITIONS SHALL BE VERIFIED BY THE CONTRACTOR AT THE SITE BEFORE PROCEEDING WITH THE WORK.

PANEL FINISHES TO BE BRONZE ANODIZED TO MATCH STOREFRONT FRAMING SYSTEM.

OR SCHEDUL	E.													SYMBOL (XXX)
LOCATION	DOOR			SIZE			FRAME					DATING	ПОМ	NOTES
	TYPE	MAT'L	FINISH*	WIDTH	HEIGHT	THICK	TYPE	MAT'L	FINISH*	JAMB	HEAD	RATING DD	אטח	NOTES
IENT FLOOR														
	'A'	HM INSUL.	PAINTED	(2) 2 ¹⁰	7°	1-3/4"	F1	НМ	PAINTED				1	PROVIDE 24"x18" LOUVER EACH LEAF
(GROUND) FLOOR				•					•			•		
	'B'	HM INSUL	PAINTED	28	7°	1 3/4 "	F2	НМ	PAINTED				2	
	'B'	HM INSUL	PAINTED	3'-0"	7'-0"	1 3/4 "	F2	НМ	PAINTED				2	
	'C'	HM INSUL GLASS	PAINTED	(2) 3'-0"	7'-0"	1 3/4 "	F3	НМ	PAINTED				3	PROVIDE TEMPERED GLASS
		TYPE MENT FLOOR EXTERIOR MECHANICAL EQUIPMENT (GROUND) FLOOR EXTERIOR NORTH ELEVATION EXTERIOR EAST ELEVATION EXTERIOR SOUTH EXTERIOR SOUTH	LOCATION TYPE MAT'L MENT FLOOR EXTERIOR MECHANICAL EQUIPMENT (GROUND) FLOOR EXTERIOR NORTH BLEVATION EXTERIOR EAST BLEVATION EXTERIOR SOUTH EXTERIOR SOUTH ICI HM INSUL	LOCATION TYPE MAT'L FINISH* MENT FLOOR EXTERIOR MECHANICAL EQUIPMENT A' HM INSUL PAINTED (GROUND) FLOOR EXTERIOR NORTH BLEVATION EXTERIOR EAST BLEVATION EXTERIOR SOUTH BY HM INSUL PAINTED EXTERIOR SOUTH C' HM INSUL PAINTED	LOCATION TYPE MAT'L FINISH* WIDTH MENT FLOOR EXTERIOR MECHANICAL PAINTED (2) 2 ¹⁰ (GROUND) FLOOR EXTERIOR NORTH PLEVATION EXTERIOR EAST PLEVATION EXTERIOR SOUTH IC HM INSUL PAINTED (2) 3'-0" PAINTED (2) 3'-0"	LOCATION TYPE MAT'L FINISH* WIDTH HEIGHT MENT FLOOR EXTERIOR MECHANICAL PAINTED (2) 2 ¹⁰ 7° (GROUND) FLOOR EXTERIOR NORTH ELEVATION BY HM INSUL PAINTED 2 ⁸ 7° EXTERIOR EAST ELEVATION EXTERIOR SOUTH COLUMN INSUL PAINTED 3'-0" 7'-0" EXTERIOR SOUTH COLUMN INSUL PAINTED (2) 3'-0" 7'-0"	LOCATION TYPE MAT'L FINISH* WIDTH HEIGHT THICK MENT FLOOR EXTERIOR MECHANICAL PAINTED (2) 2 ¹⁰ 7° 1-3/4" (GROUND) FLOOR EXTERIOR NORTH PLEVATION PAINTED PAINTED 2 ⁸ 7° 13/4" EXTERIOR EAST PLEVATION PAINTED 3'-0" 7'-0" 13/4" EXTERIOR SOUTH PAINTED (2) 3'-0" 7'-0" 13/4"	LOCATION TYPE MAT'L FINISH* WIDTH HEIGHT THICK TYPE MENT FLOOR EXTERIOR MECHANICAL PAINTED (2) 2 ¹⁰ 7° 1-3/4" F1 (GROUND) FLOOR EXTERIOR NORTH PLEVATION PAINTED PAINTED 2 ⁸ 7° 13/4" F2 EXTERIOR EAST PLEVATION PAINTED PAINTED 3'-0" 7'-0" 13/4" F2 EXTERIOR SOUTH PAINTED (2) 3'-0" 7'-0" 13/4" F2	DOOR	LOCATION TYPE MAT'L FINISH* WIDTH HEIGHT THICK TYPE MAT'L FINISH* MENT FLOOR EXTERIOR MECHANICAL PAINTED (2) 2 ¹⁰ 7° 1-3/4" F1 HM PAINTED (GROUND) FLOOR EXTERIOR NORTH ELEVATION B' HM INSUL PAINTED 2 ⁸ 7° 13/4" F2 HM PAINTED EXTERIOR EAST ELEVATION B' HM INSUL PAINTED (2) 3'-0" 7'-0" 13/4" F2 HM PAINTED EXTERIOR SOUTH C' HM INSUL PAINTED (2) 3'-0" 7'-0" 13/4" F2 HM PAINTED	DOOR	DOOR TYPE MAT'L FINISH* WIDTH HEIGHT THICK TYPE MAT'L FINISH* JAMB HEAD	DOOR	LOCATION

*FINAL COLOR TO BE SELECTED BY OWNER

- 1. ALL DOORS ARE REPLACING EXISTING DOORS. GC TO VERIFY ALL MEASUREMENTS IN FIELD TO AVOID ANY DISCREPANCIES 5. ALL DOOR CLOSERS TO MEET ADA COMPLIANCE SPECIFICATIONS
- 2. G.C. SHALL ARRANGE A MEETING WITH OWNER AND ARCHITECT TO VERIFY HARDWARE FUNCTIONS PRIOR TO ANY
- ORDERING OR PURCHASING. 3. G.C. SHALL PROVIDE DOOR AND HARDWARE SUBMITTALS AND SHOP DRAWINGS FOR REVIEW AND APPROVAL PRIOR TO
- PURCHASING AND INSTALLING. 4. EXTERIOR DOORS, ARE TO BE GALVANIZED HOLLOW METAL, INSULATED, PRIMED & PAINTED. FINISH COLOR TO BE BRONZE- 10. ALL HARDWARE TO BE COMPATIBLE WITH MEDCO 6-PIN CORES TO MATCH WINDOW FRAMES. PROVIDE & INSTALL ADA LEVER TRIM HANDLE HARDWARE AT EXTERIOR OF ALL DOORS AND 11. CONTRACTOR TO SAVE EXISTING CORES FOR RE-USE IN NEW SYSTEM. INTERIOR PANIC BAR HARDWARE AT ALL DOORS.
- 6. G.C. TO PROVIDE WALL MOUNTED DOOR STOPS FOR HINGED DOORS, UNLESS OTHERWISE NOTED. 7. G.C. SHALL PROVIDE R.O. AS REQUIRED BY DOOR MANUF. SPECIFICATIONS
- 8. PROVIDE THRESHOLDS WITH THERMAL BREAK & WEATHER STRIPPING AT ALL EXTERIOR DOORS. 9. ALL DOORS ARE TO HAVE TEMPERED GLASS WHERE GLASS IS INDICATED.

HARDWARE SCHEDULE AND NOTES

<u>HARDWARE SET #1</u> EXTERIOR DOUBLE EGRESS DOOR AT MECHANICAL ROOM BUTT HINGES (PER LEAF) OR CONTINUOUS ROTON HINGE 1 SET PANIC BAR HARDWARE (PER LEAF) WITH FLUSH BOLTS DOOR CLOSER TO MEET ADA (PER LEAF)

1 SET DOOR SILENCERS (PER LEAF) BRUSHED ALUMINUM KICK PLATE (INTERIOR/ PER LEAF) LOUVER (PER LEAF) SEE DOOR TYPES 1 SET DOOR STOPS (CONSULT WITH OWNER FOR LOCATION)

* VERIFY DOOR FUNCTION WITH OWNER

<u>HARDWARE SET #2</u> EXTERIOR EGRESS DOOR - GROUND FLOOR BUTT HINGES OR CONTINUOUS ROTON HINGE 1 SET PANIC BAR HARDWARE DOOR CLOSER (TO MEET ADA)

DOOR SILENCERS

BRUSHED ALUMINUM KICK PLATE (INTERIOR) 1 SET DOOR STOPS (CONSULT WITH OWNER FOR LOCATION)

* VERIFY DOOR FUNCTION WITH OWNER

1 SET

EXTERIOR DOUBLE EGRESS DOOR - GROUND FLOOR BUTT HINGES (PER LEAF) OR CONTINUOUS ROTON HINGE PANIC BAR HARDWARE (PER LEAF) WITH FLUSH BOLTS

DOOR CLOSER TO MEET ADA (PER LEAF) 1 SET DOOR SILENCERS (PER LEAF)

* VERIFY DOOR FUNCTION WITH OWNER

BRUSHED ALUMINUM KICK PLATE (INTERIOR/ PER LEAF) DOOR STOPS (CONSULT WITH OWNER FOR LOCATION)

DOOR & WINDOW GENERAL NOTES

G.C. TO INSPECT AND EVALUATE ALL WINDOW AND DOOR LINTELS DURING REMOVAL FOR STRUCTURAL INTEGRITY, VENDING/ DEFORMATION OR STEEL DELAMINATION.

ANY LINTELS THAT ARE DAMAGED, BENT OR DELAMINATED SHALL BE BROUGHT TO THE ATTENTION OF THE OWNER & ARCHITECT. ALL STEEL LINTELS ARE TO BE STRIPPED OF EXISTING FINISH, PRIMED WITH RUST INHIBITIVE PAINT AND PREPARED FOR FINAL PAINT COLOR.

ALL WINDOW AND DOOR JAMBS ARE TO BE REPAIRED, PATCHED AND PAINTED TO MATCH EXISTING ADJACENT SURFACES.


AS PART OF DOOR AND WINDOW JAMB SURFACE TOUCH-UP & REPAIR, G.C. SHALL INSPECT ALL GWB OUTSIDE CORNERS AND REPAIR OR STRAIGHTEN ANY CHIPPED, DENTED OR DEFORMED WINDOW OR DOOR GWB JAMBS. ALLOW 200 sq. in OF AREA OUTSIDE OF JAMBS PER OPENING.


AT EACH OPENING, G.C. TO CAREFULLY REMOVE EXISTING CEILING MATERIAL BACK TO NEAREST MODULE/ JOINT TO ALLOW FOR WINDOW AND DOOR WORK.ONCE COMPLETED, INFILL GAP WITH IN KIND MATERIAL (SALVAGED OR NEW), GWB OR METAL IN A NEAT WORKMANLIKE MANNER. PAINT TO MATCH ADJACENT CEILING.

ALL INTERIOR WINDOW STOOLS TO BE PAINTED. ALL WINDOW STOOLS THAT ARE BROKEN ARE TO BE REPLACED IN KIND.

ALL EXISTING WINDOW TREATMENTS TO BE REPLACED. COORDINATE WITH OWNER & ARCHITECT. PROVIDE LINE ITEM COST TO INCLUDE LABOR TO REMOVE EXISTING AND INSTALL NEW IN BASE BID WITH MATERIAL ALLOWANCE COST FOR NEW MATERIAL.

G.C. TO PROVIDE A LINE ITEM ALLOWANCE COST FOR TEMPORARY RELOCATION OF EXISTING FURNITURE AND SUBSEQUENT REPLACEMENT TO ORIGINAL LOCATIONS.

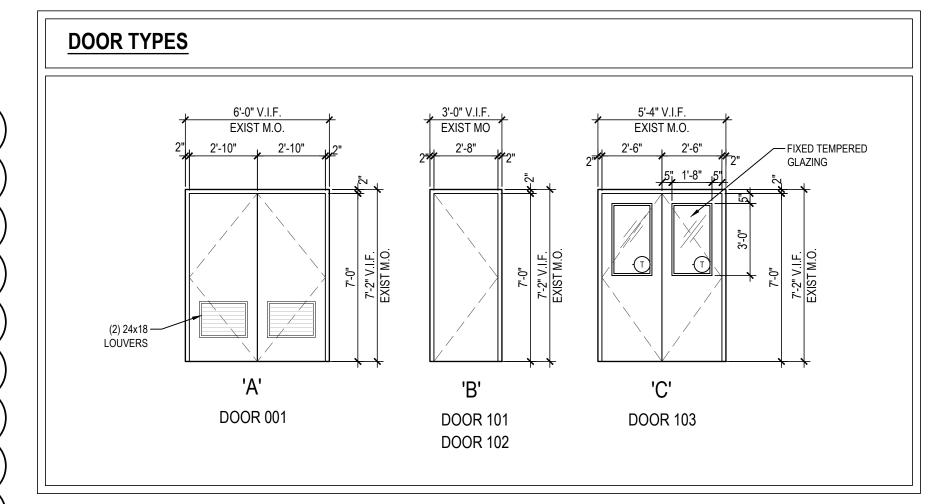

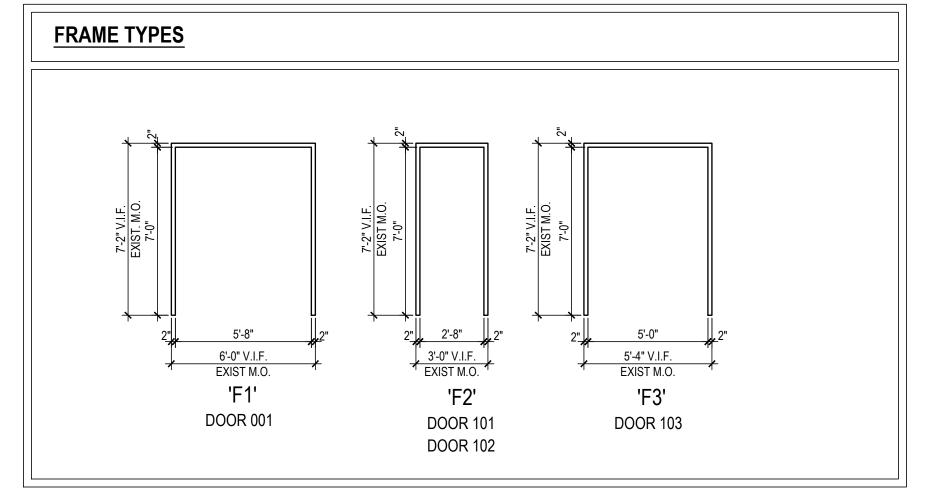



REVISIONS

1 | 02-06-25 | CLARIFICATIONS

REVISIONS

ISSUE DATE

PROJECT COORDINATOR: KYLE O'CONNOR, RLA LEED GREEN ASSOCIATE



SEILER + DRURY

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CAPITAL PROJECTS DIVISION 1400 JFK BLVD 7TH FLR CITY HALL

PROJECT TITLE PHILADELPHIA ZOOLOGICAL GARDENS

-SHELLY ADMINISTRATION BUILDING- WINDOW TREATMENTS

DRAWING TITLE


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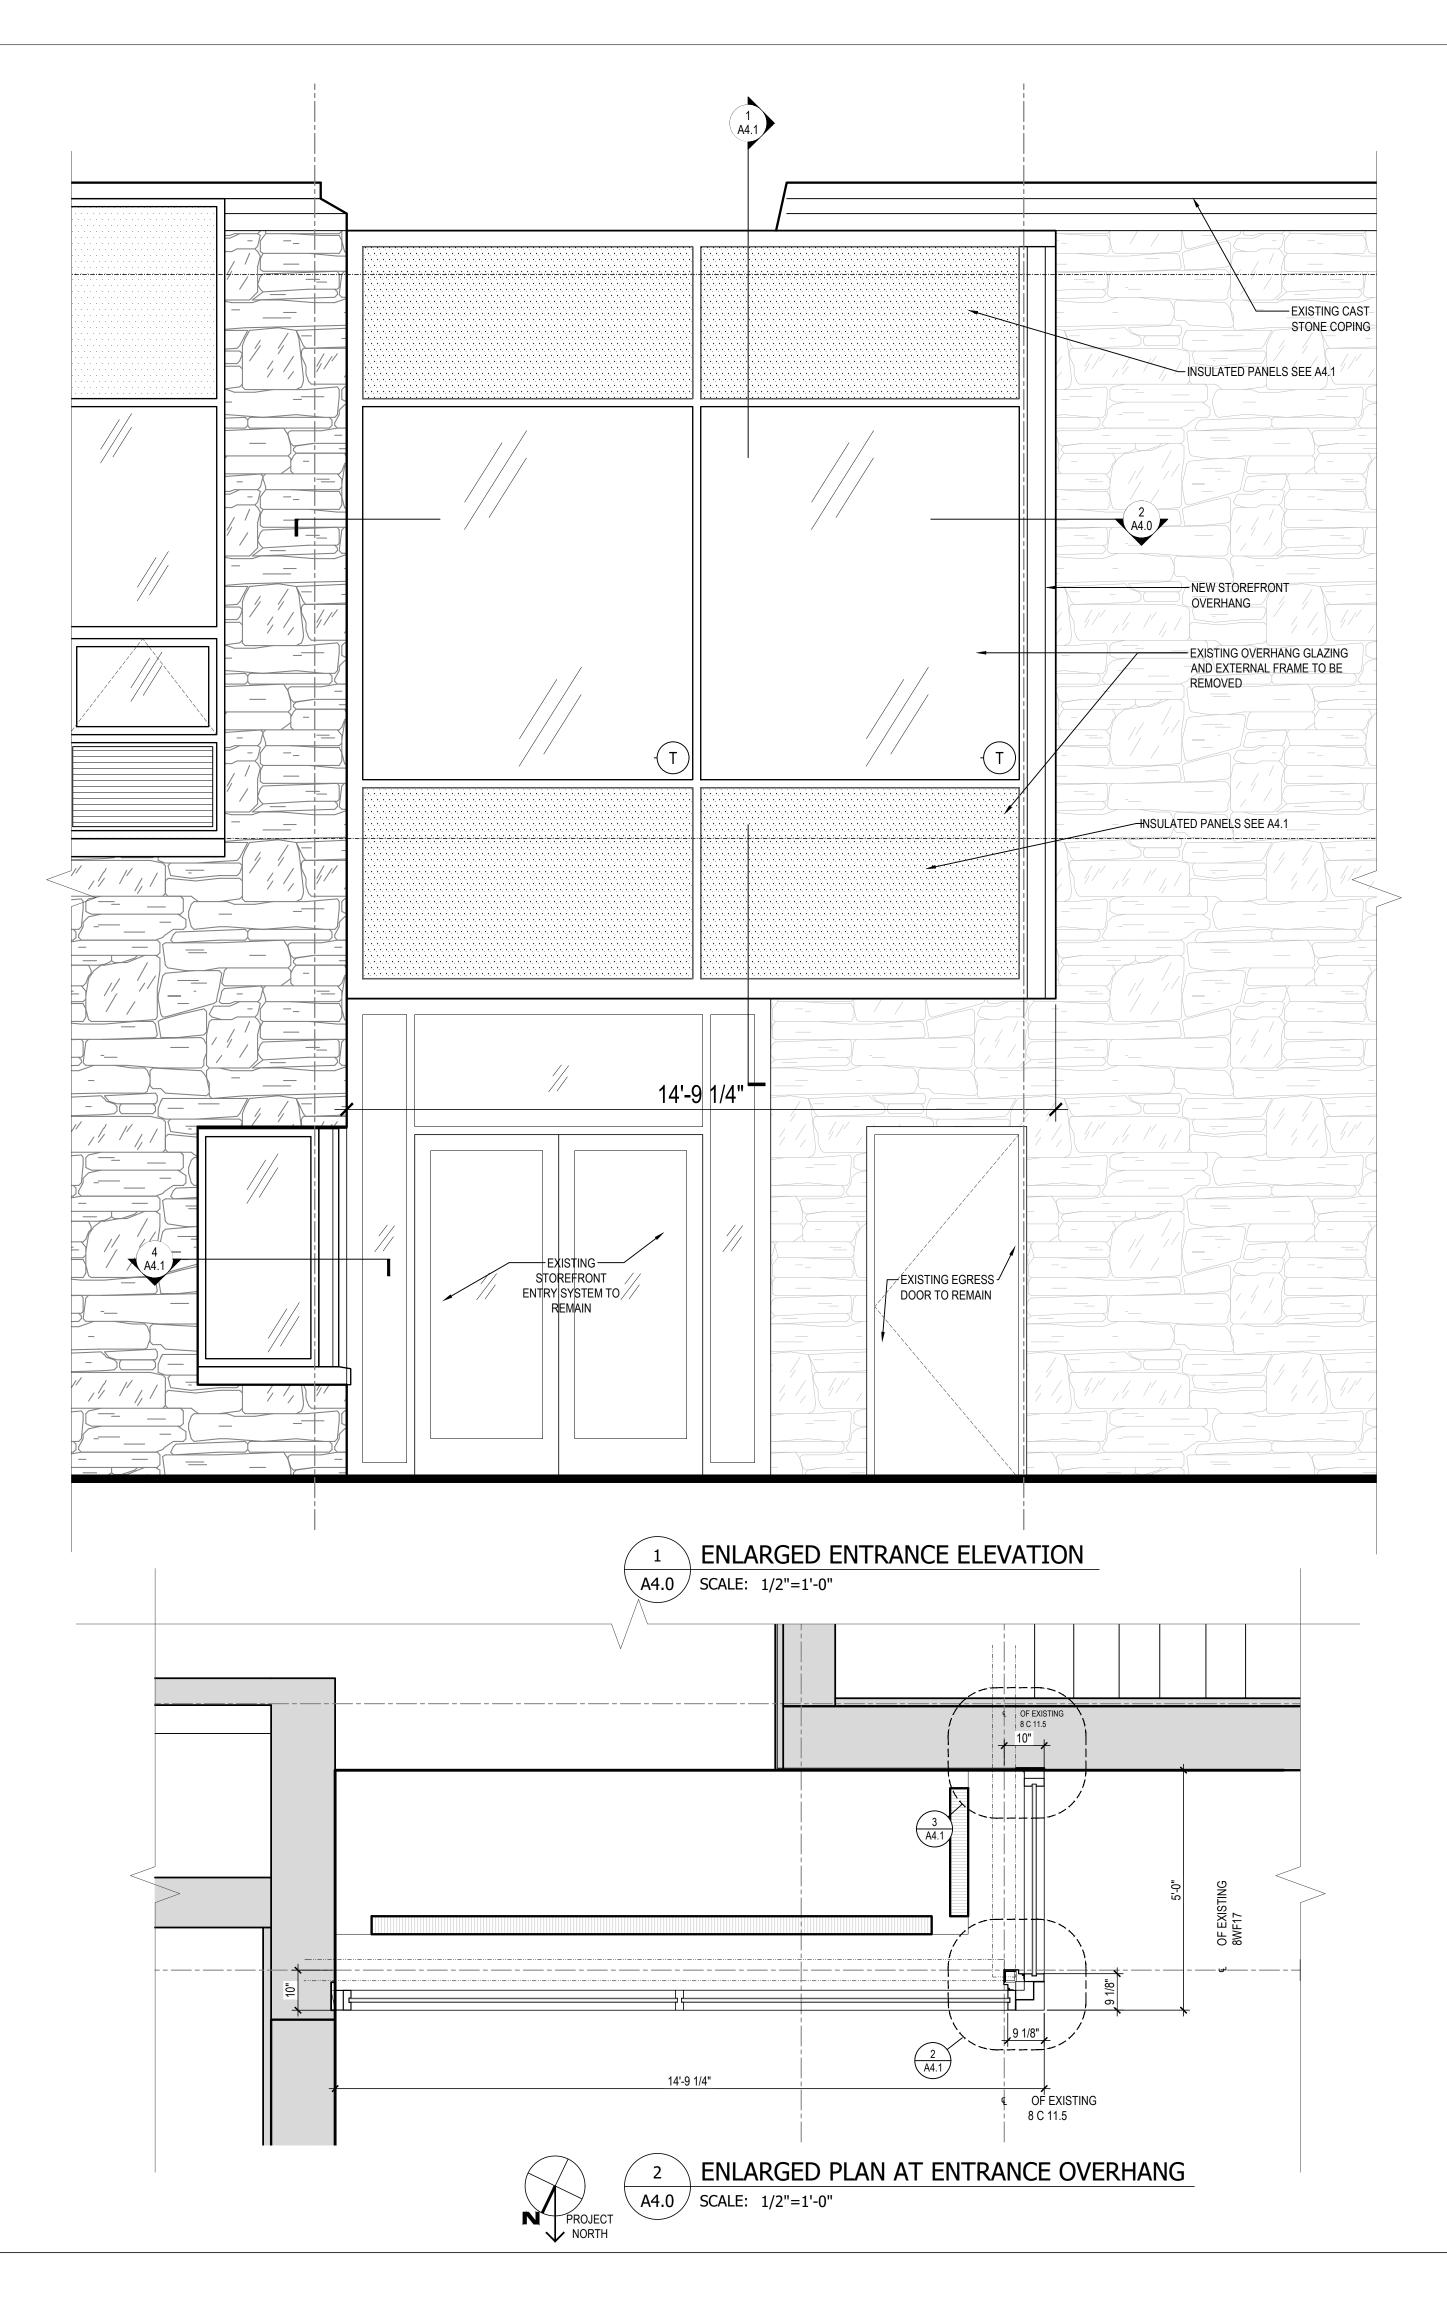
SHELLY ADMINISTRATION BUILDING

WINDOW & DOOR NOTES AND DETAILS

PROJECT NO. DRAWING NO. 2424 12-16-2024 SCALE AS INDICATED

ALL DIMENSIONS AND CONDITIONS SHALL BE VERIFIED BY THE CONTRACTOR AT THE SITE BEFORE PROCEEDING WITH THE WORK.



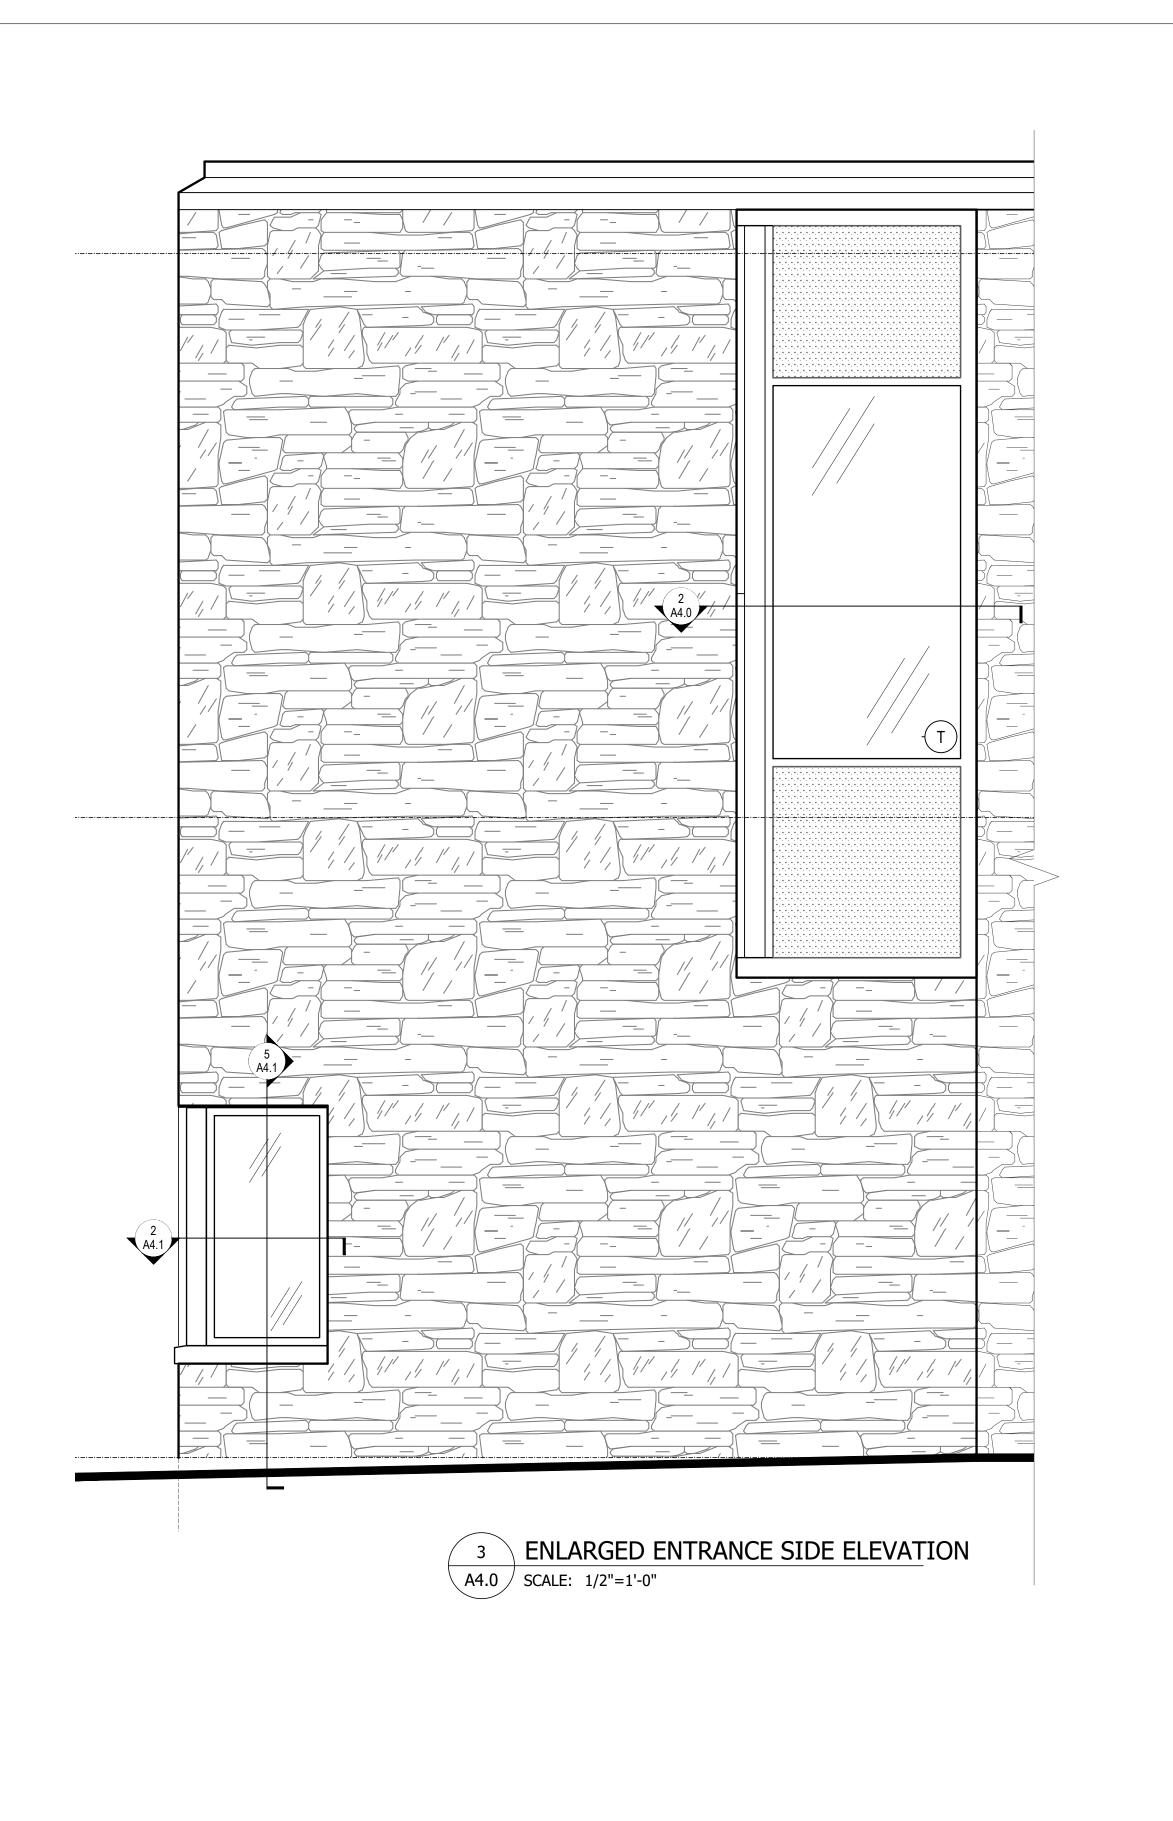



REVISIONS

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PHILADELPHIA PENNSYLVAN

PROJECT TITLE
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-SHELLY ADMINISTRATION BUILDING- WINDOW TREATMENTS

AWING TITLE

SHELLY ADMINISTRATION BUILDING

WINDOW DETAILS AND NOTES

PROJECT NO. DRAWING NO.

DATE 12-16-2024

SCALE AS INDICATED


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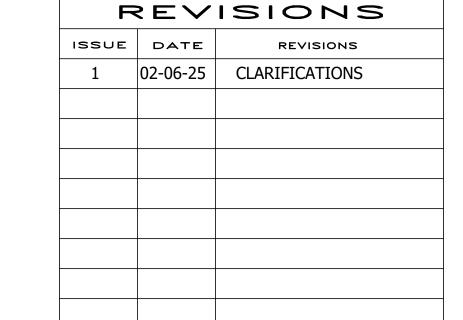
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PHILADELPHIA ZOOLOGICAL GARDENS -SHELLY ADMINISTRATION BUILDING- WINDOW TREATMENTS

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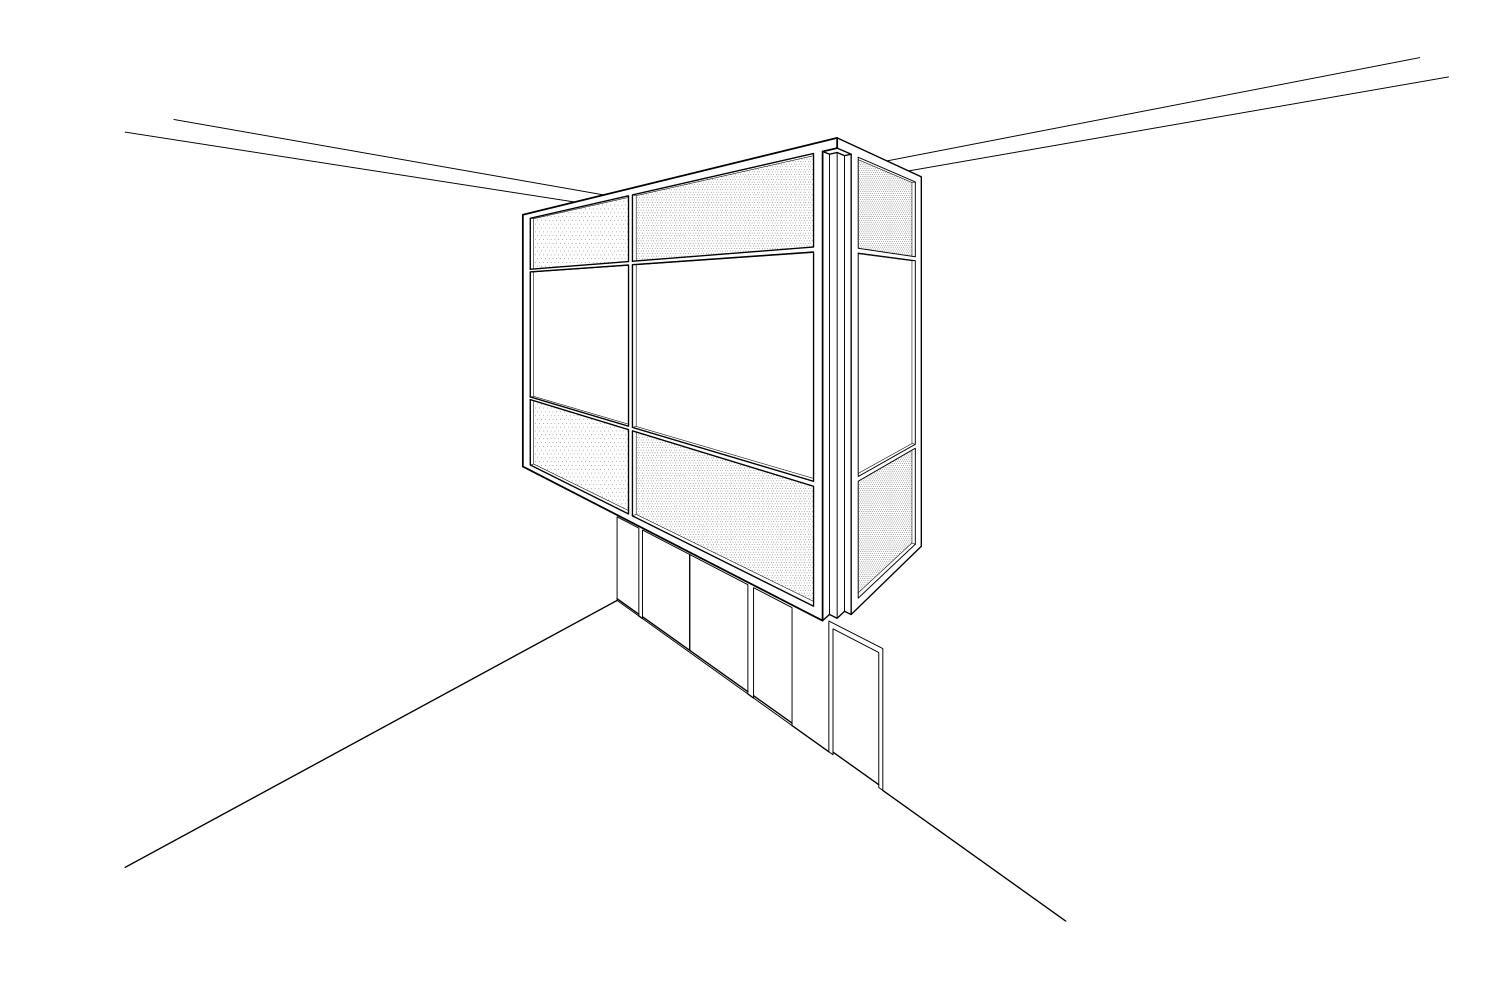
SHELLY ADMINISTRATION BUILDING


WINDOW DETAILS AND NOTES

PROJECT NO. 2424

12-16-2024

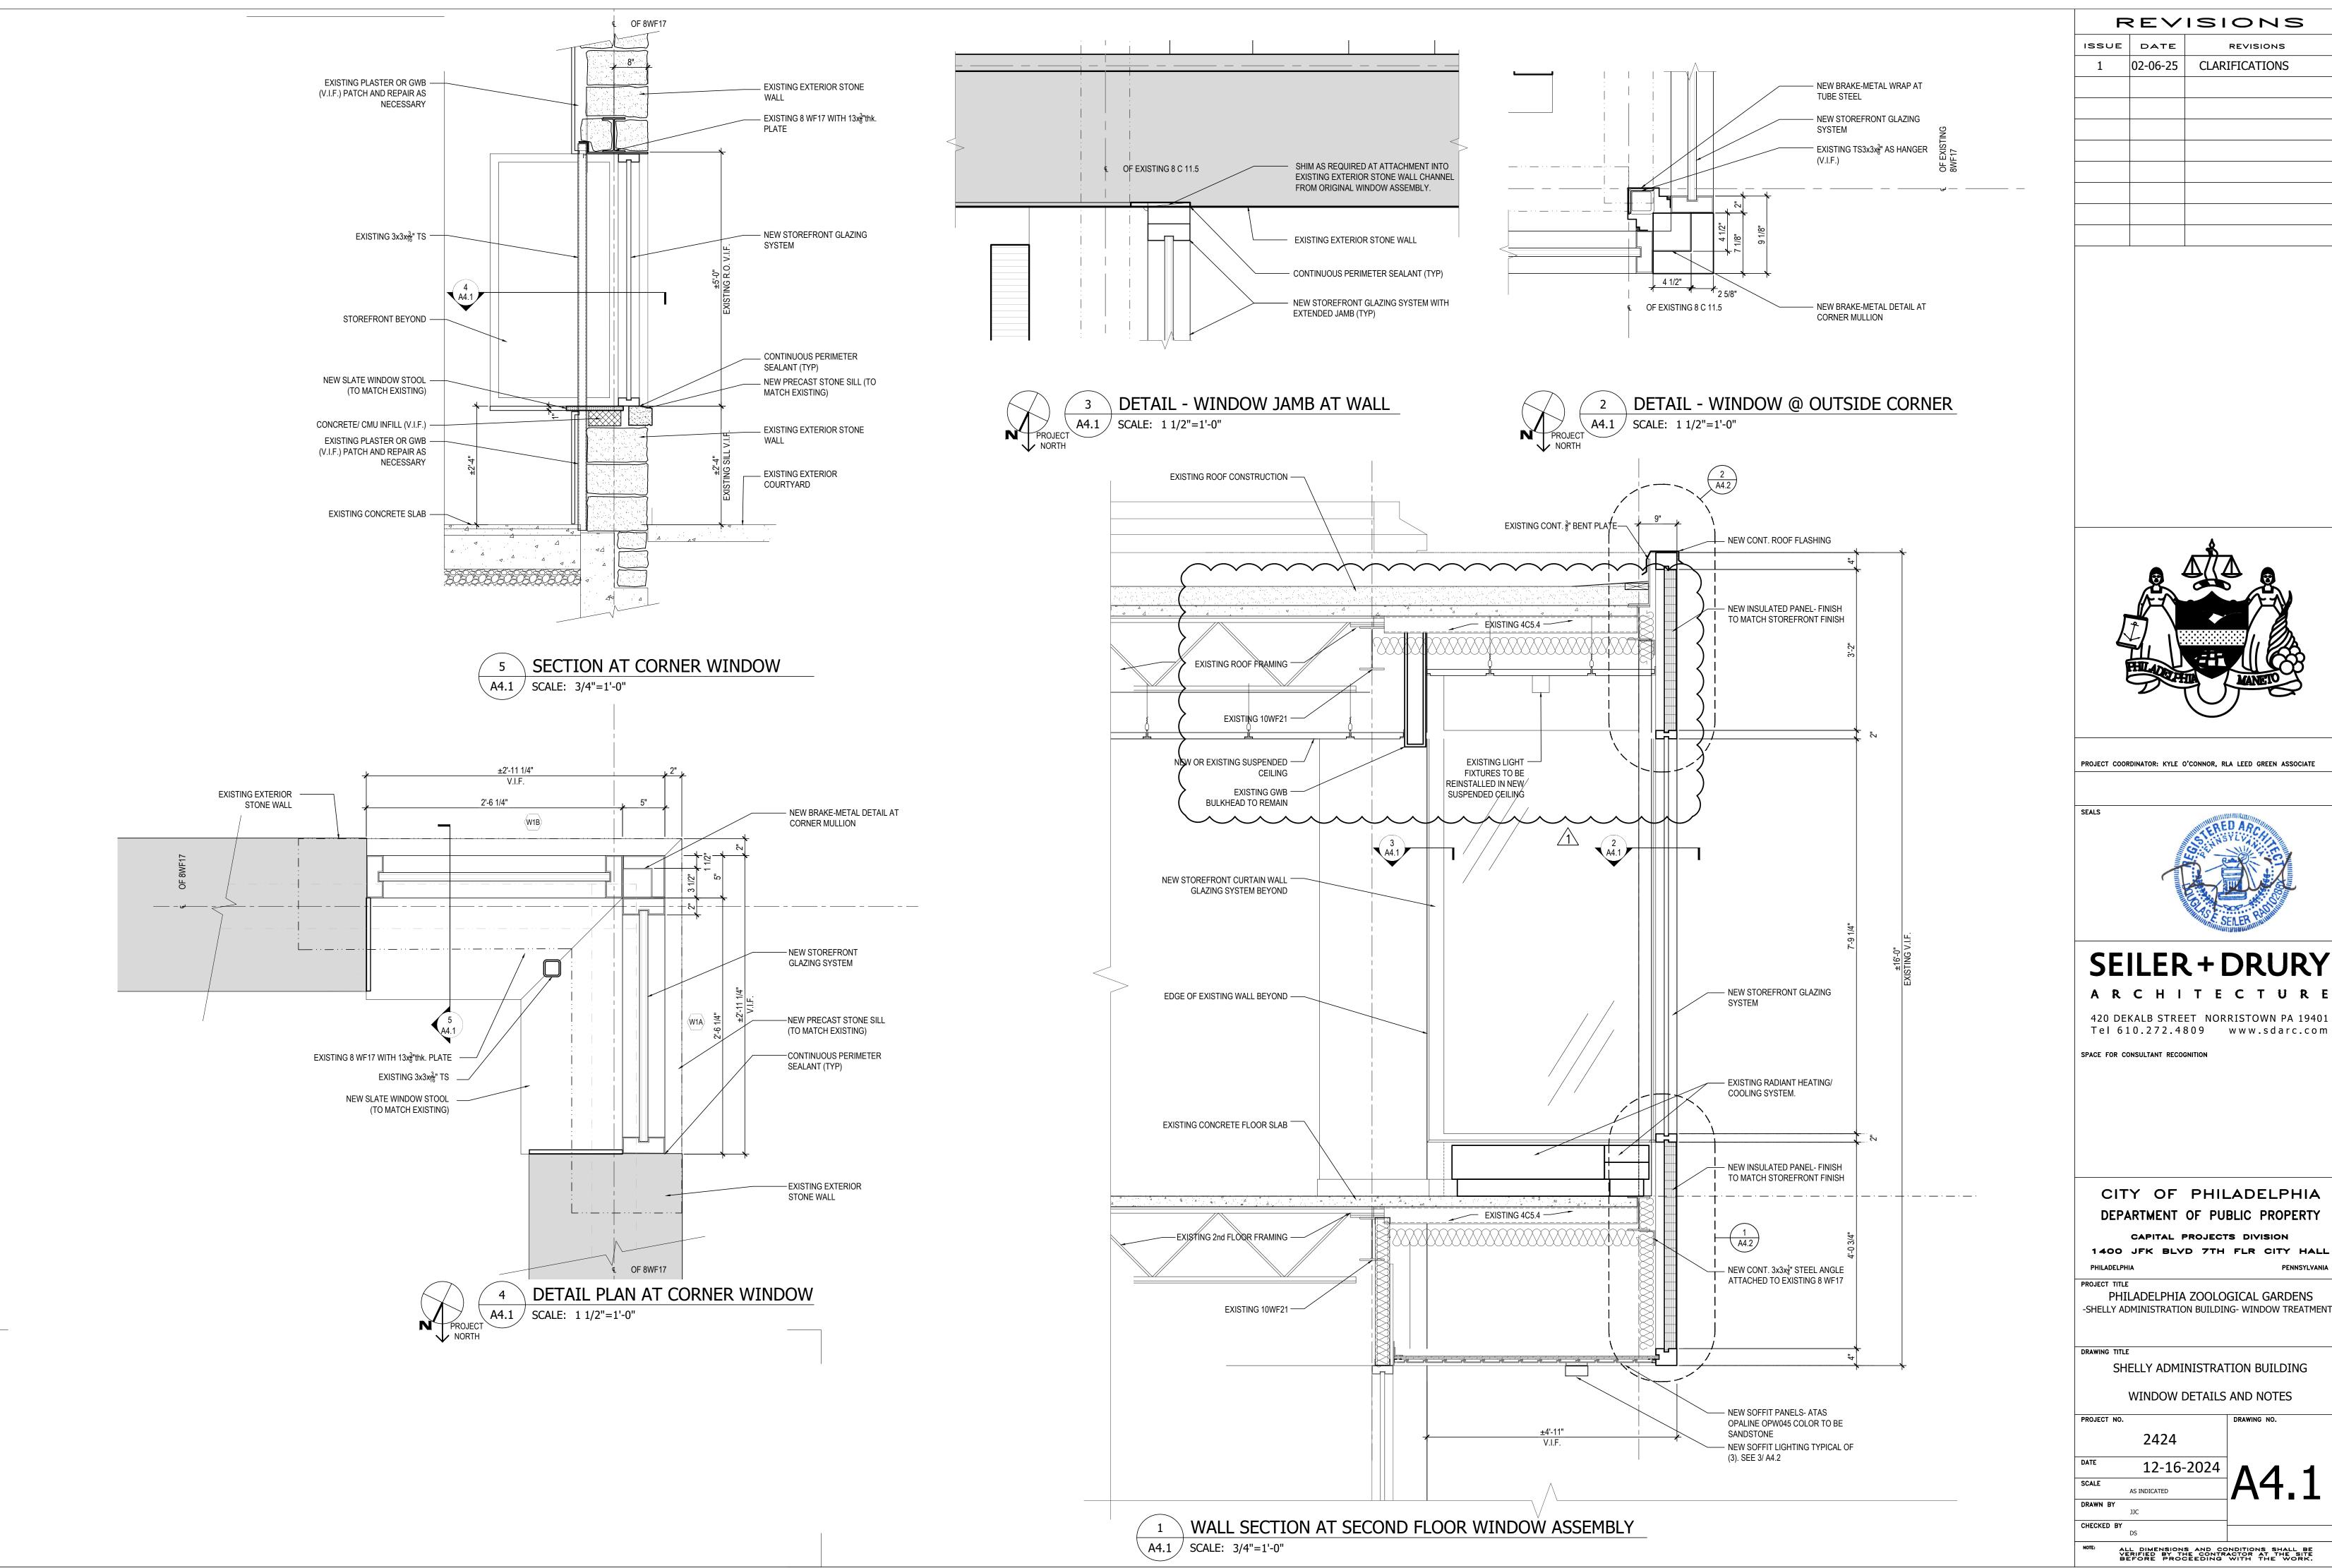
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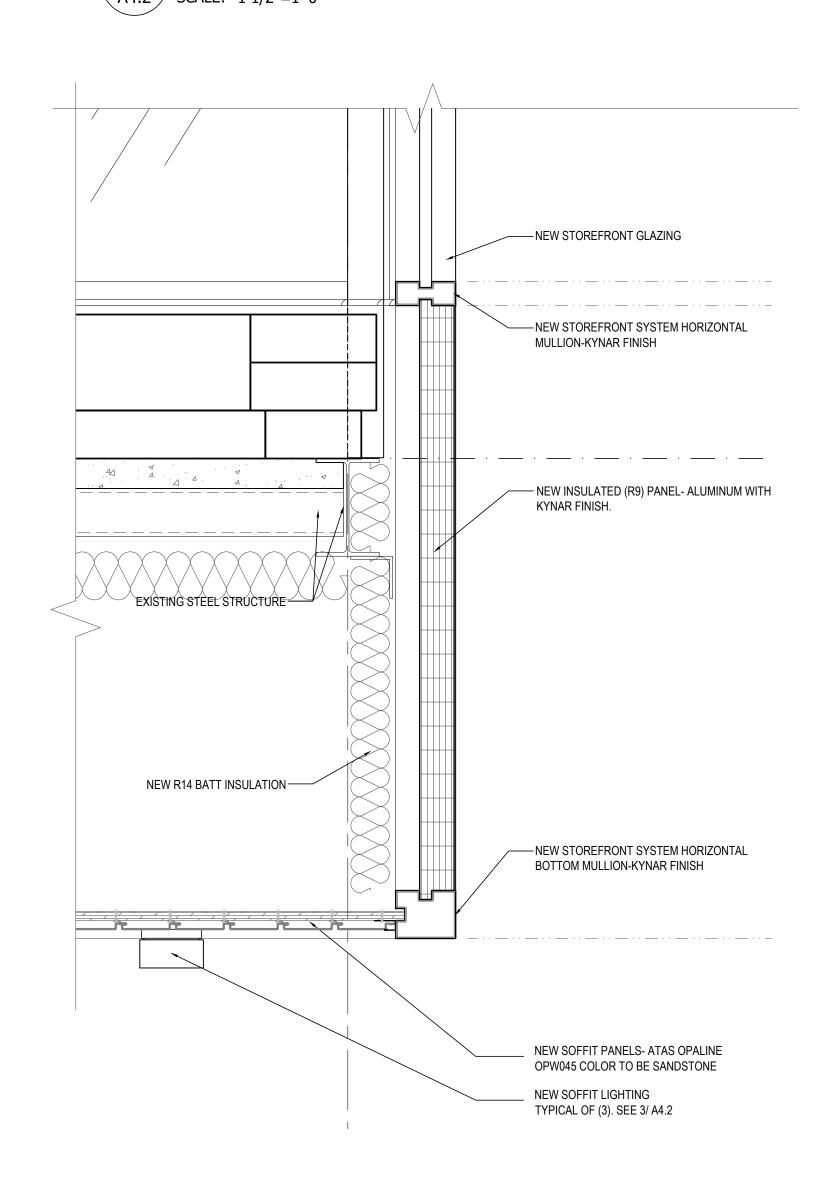


WINDOW ABOVE ENTRY- SOFFIT OPTIONS

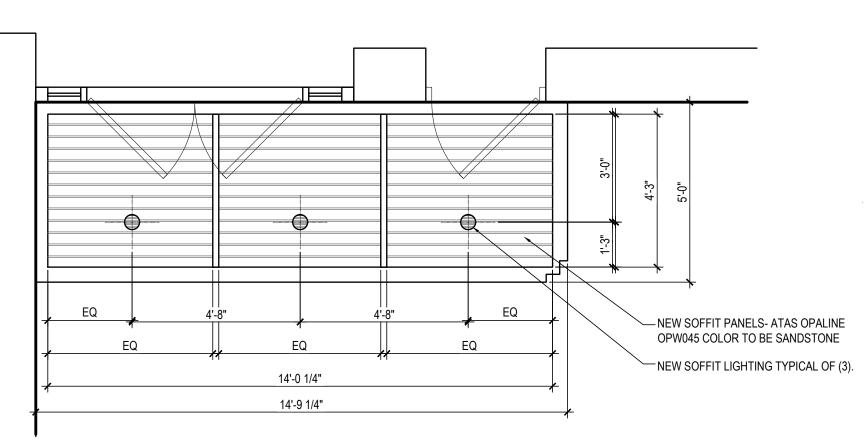
A4.2 SCALE: 3/8"=1'-0"



2 WINDOW ABOVE ENTRY- STOREFRONT HEAD @ ROOF
A4.2 SCALE: 1 1/2"=1'-0"

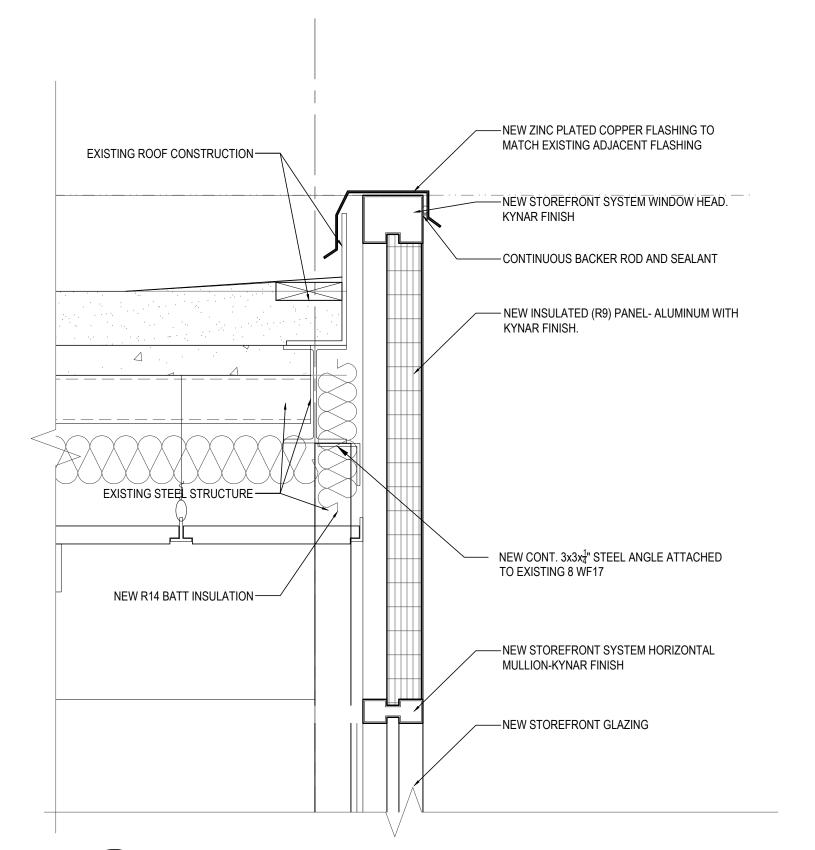

1 WINDOW ABOVE ENTRY- BOTTOM RAIL @ SOFFIT A4.2 SCALE: 1 1/2"=1'-0"

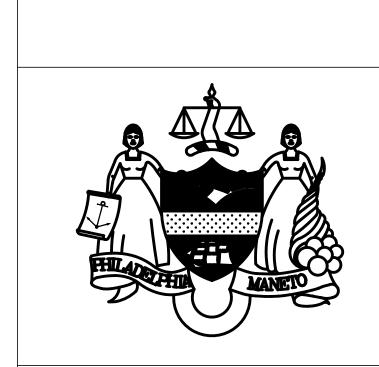

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PROJECT TITLE
PHILADELPHIA ZOOLOGICAL GARDENS
-SHELLY ADMINISTRATION BUILDING- WINDOW TREATMENTS

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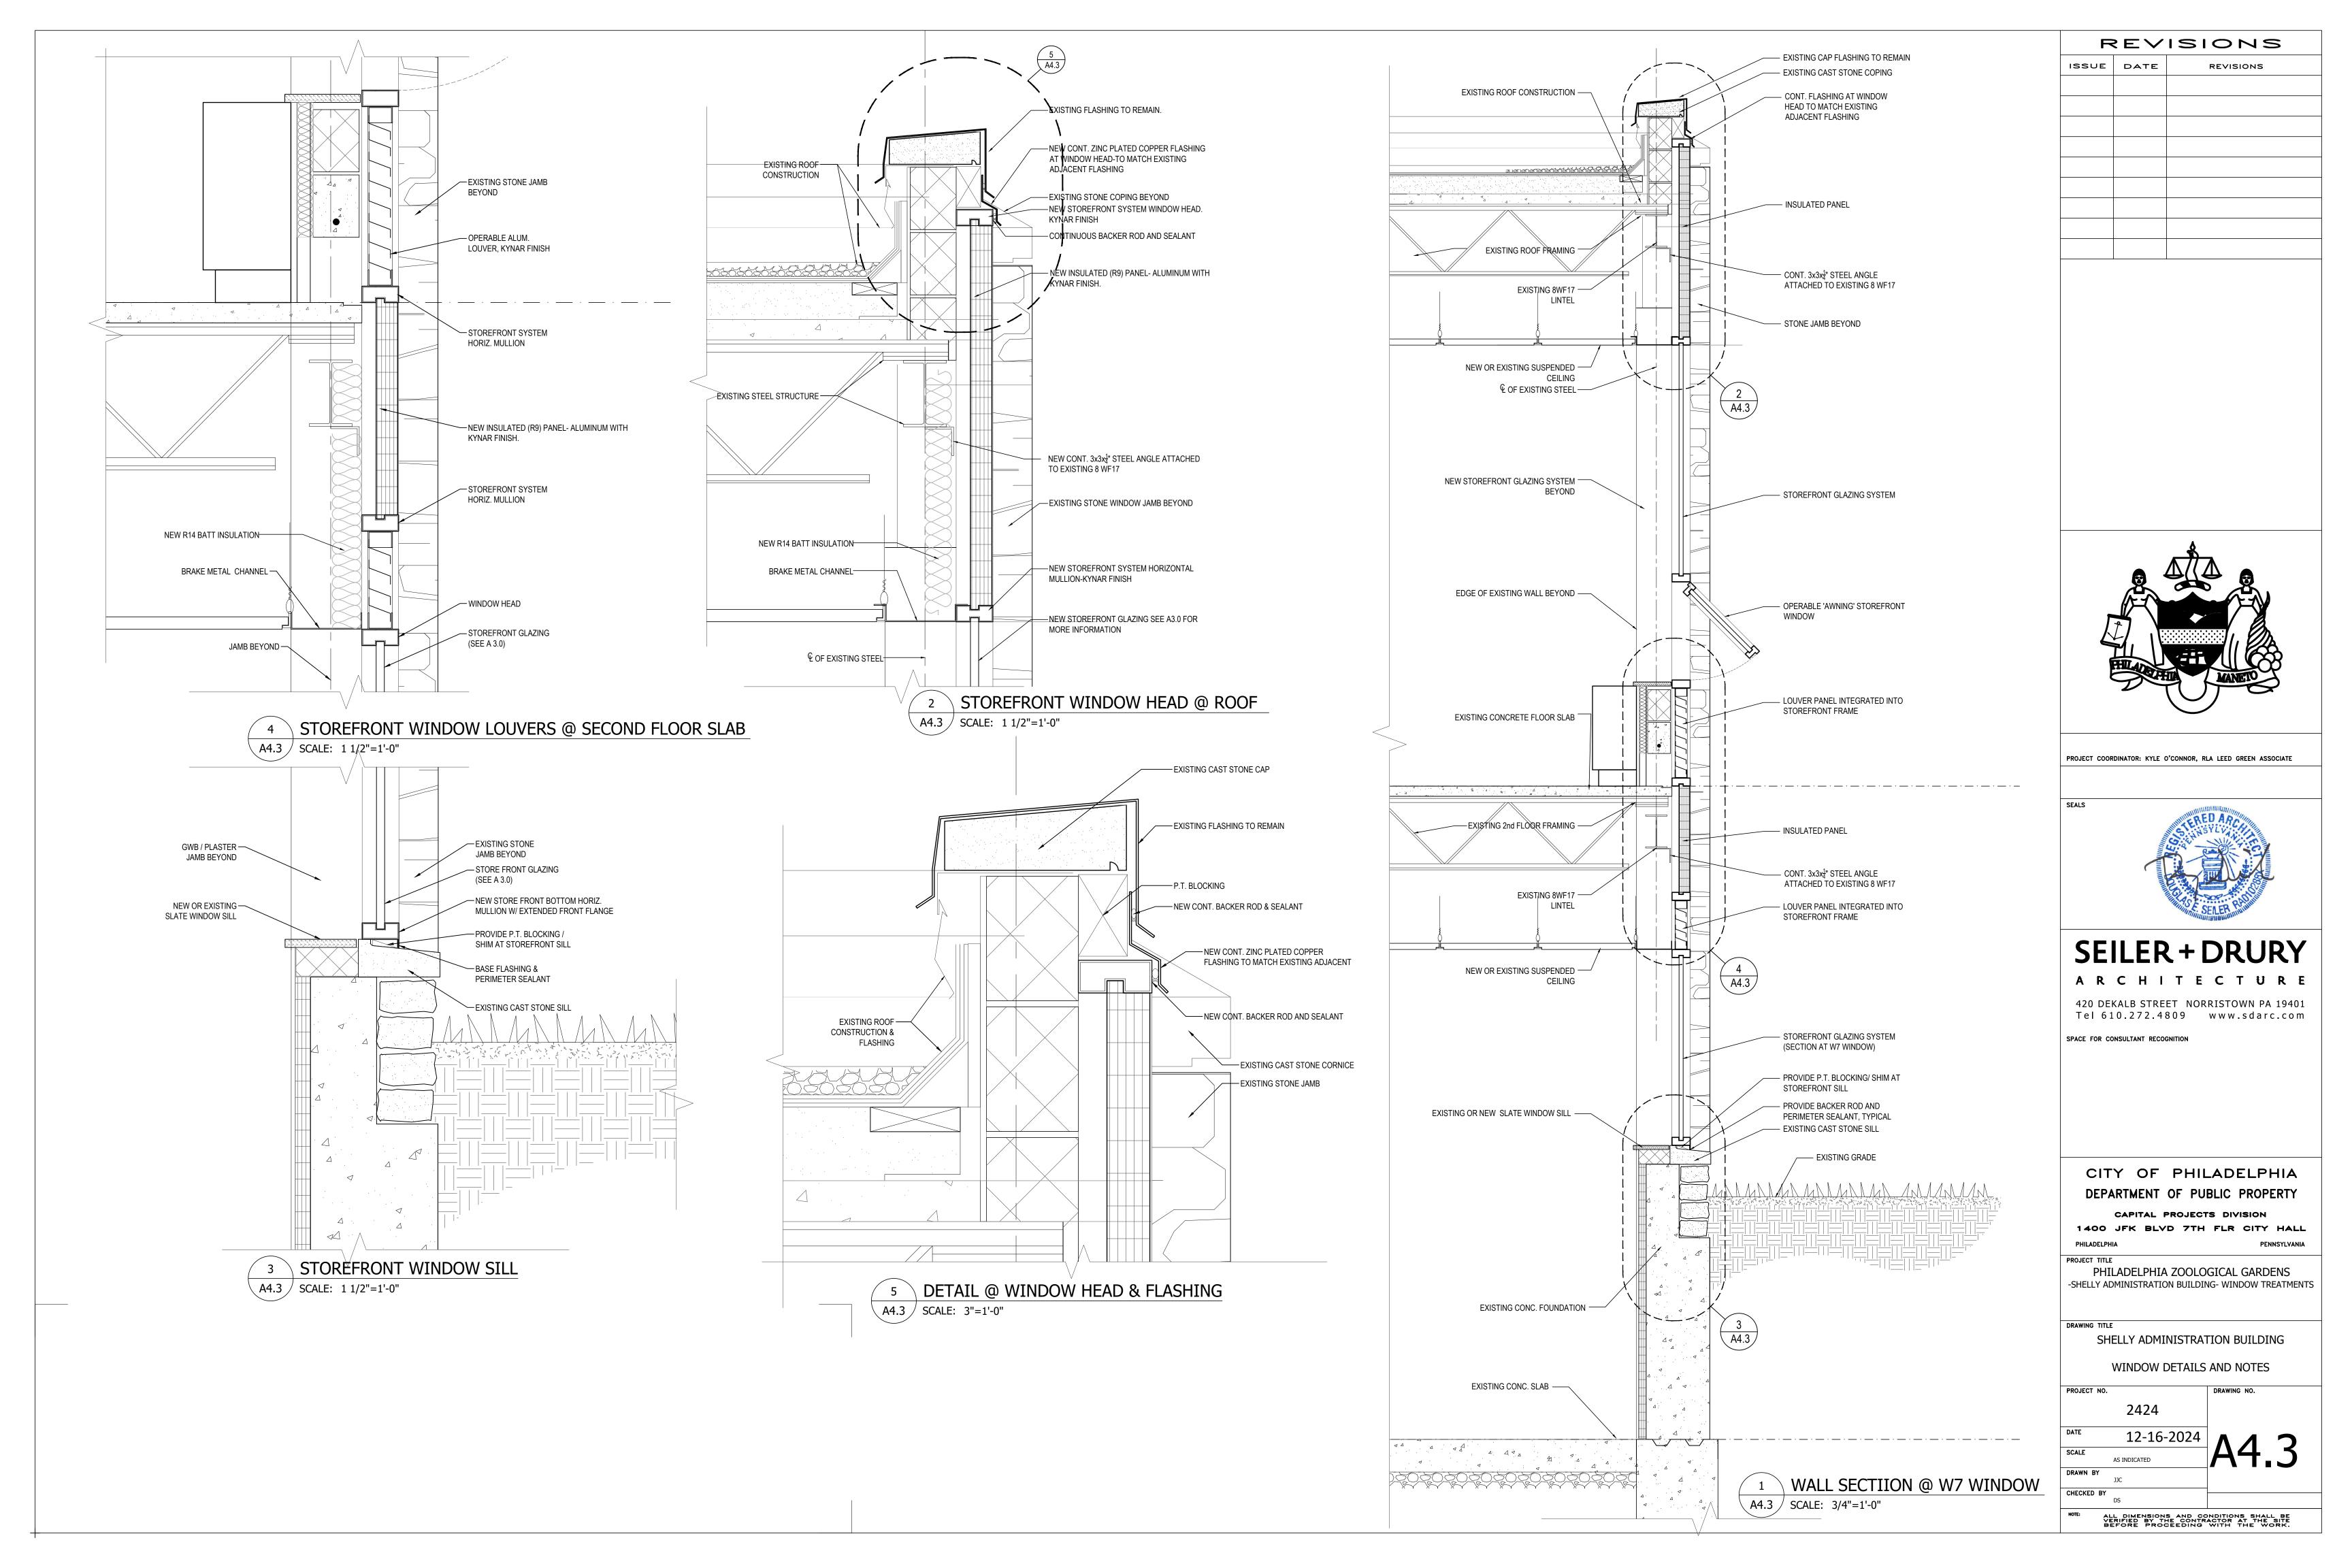
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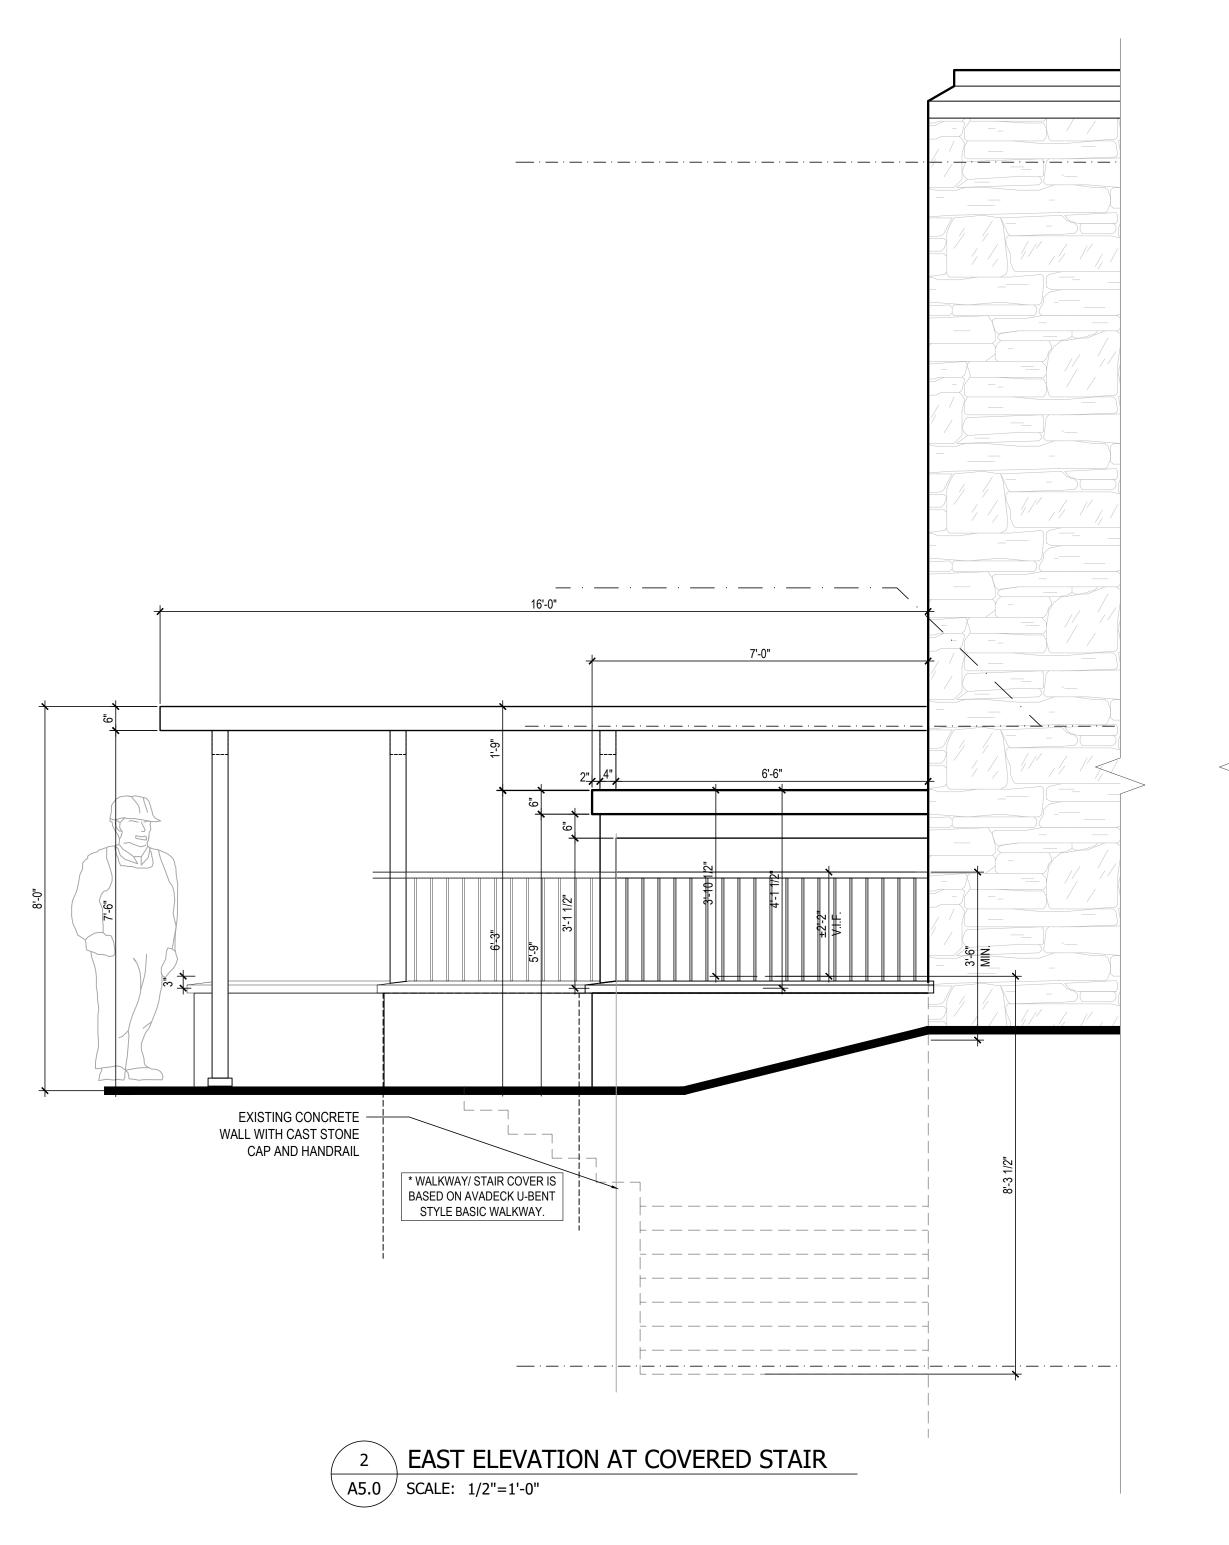
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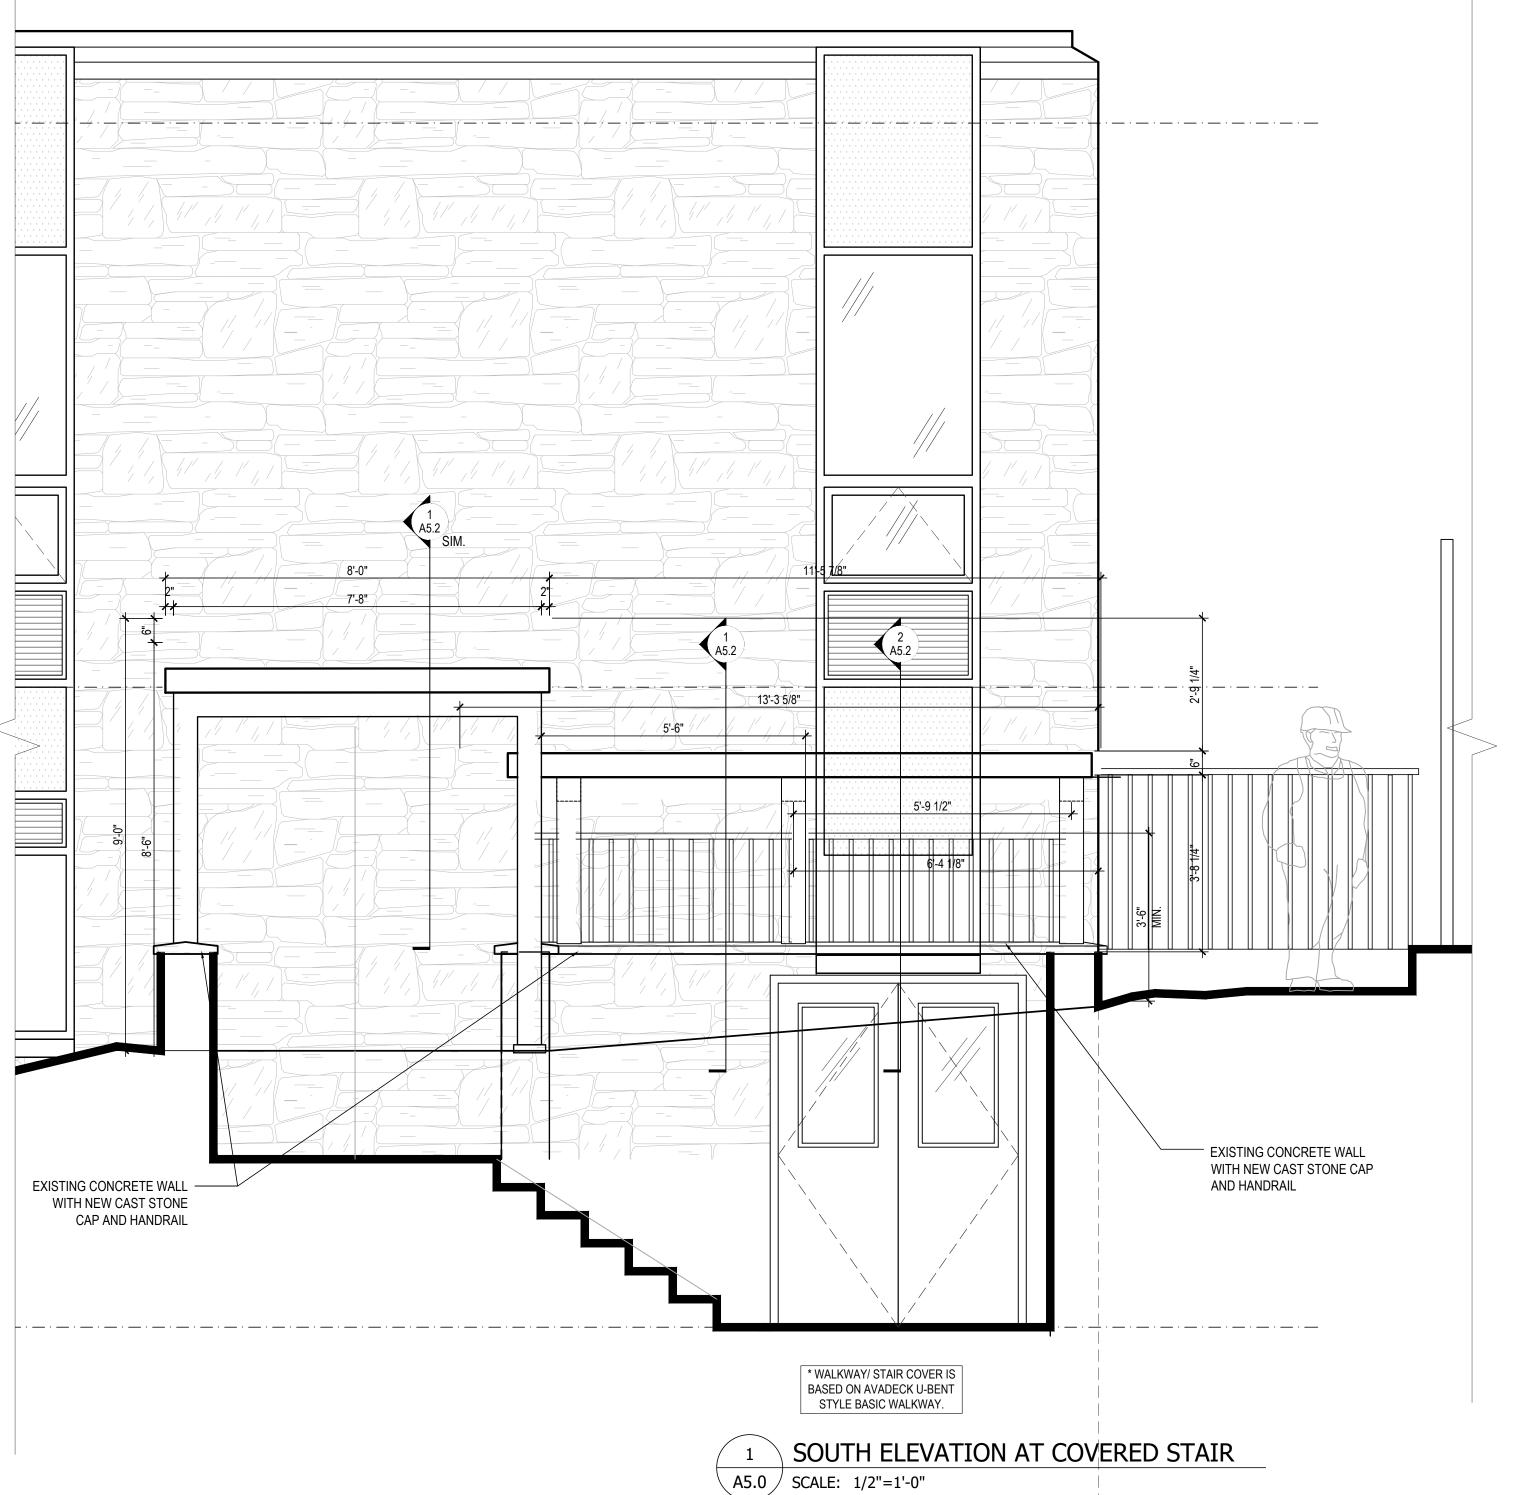
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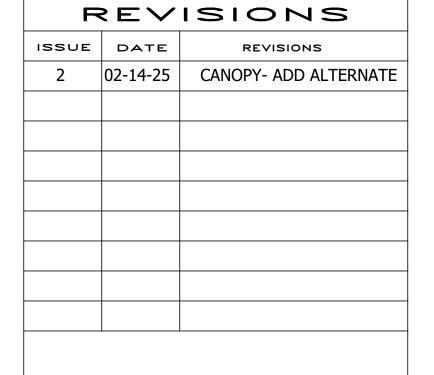
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SPACE FOR CONSULTANT RECOGNITION SHELLY ADMINISTRATION BUILDING

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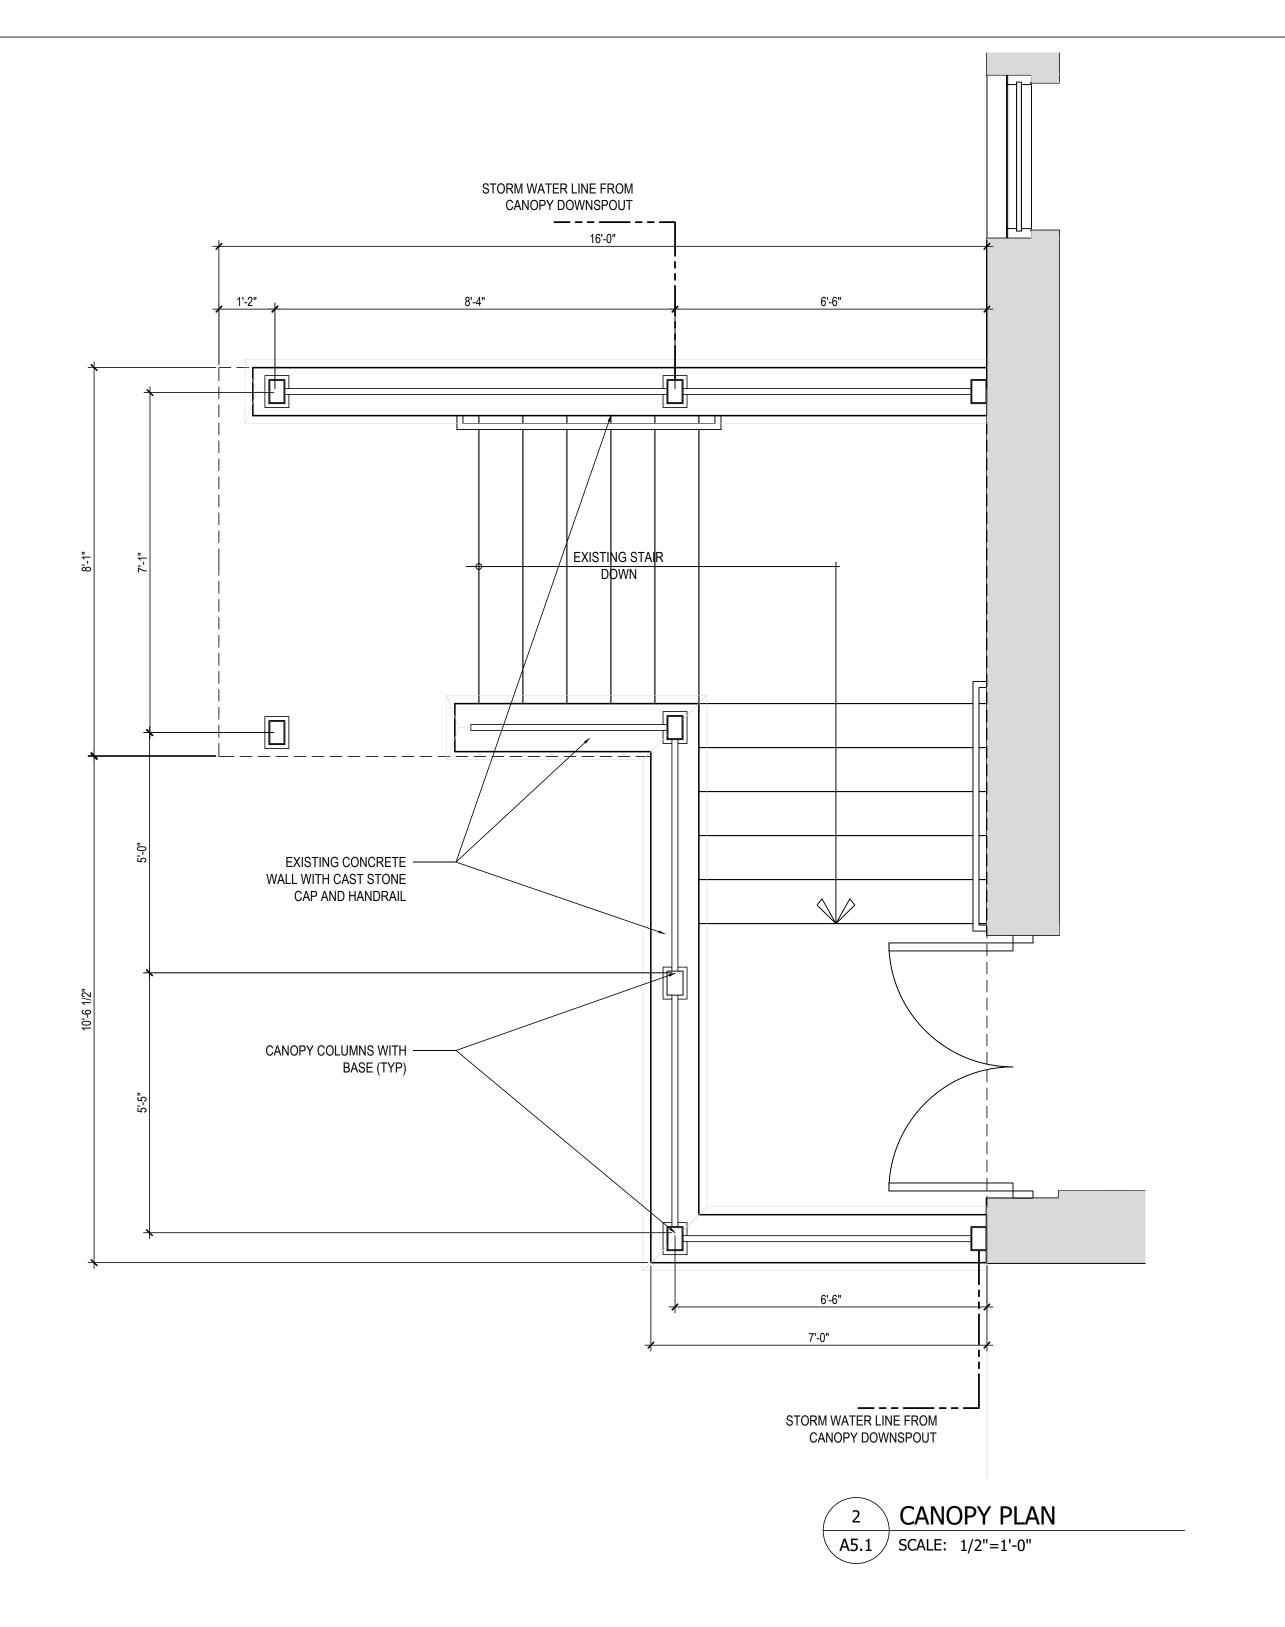
PROJECT TITLE PHILADELPHIA ZOOLOGICAL GARDENS -SHELLY ADMINISTRATION BUILDING- WINDOW TREATMENTS


CANOPY OVER STAIRWELL


PROJECT NO. 2424


12-16-2024 A5.0

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PROJECT COORDINATOR: KYLE O'CONNOR, RLA LEED GREEN ASSOCIATE

RED AROUND

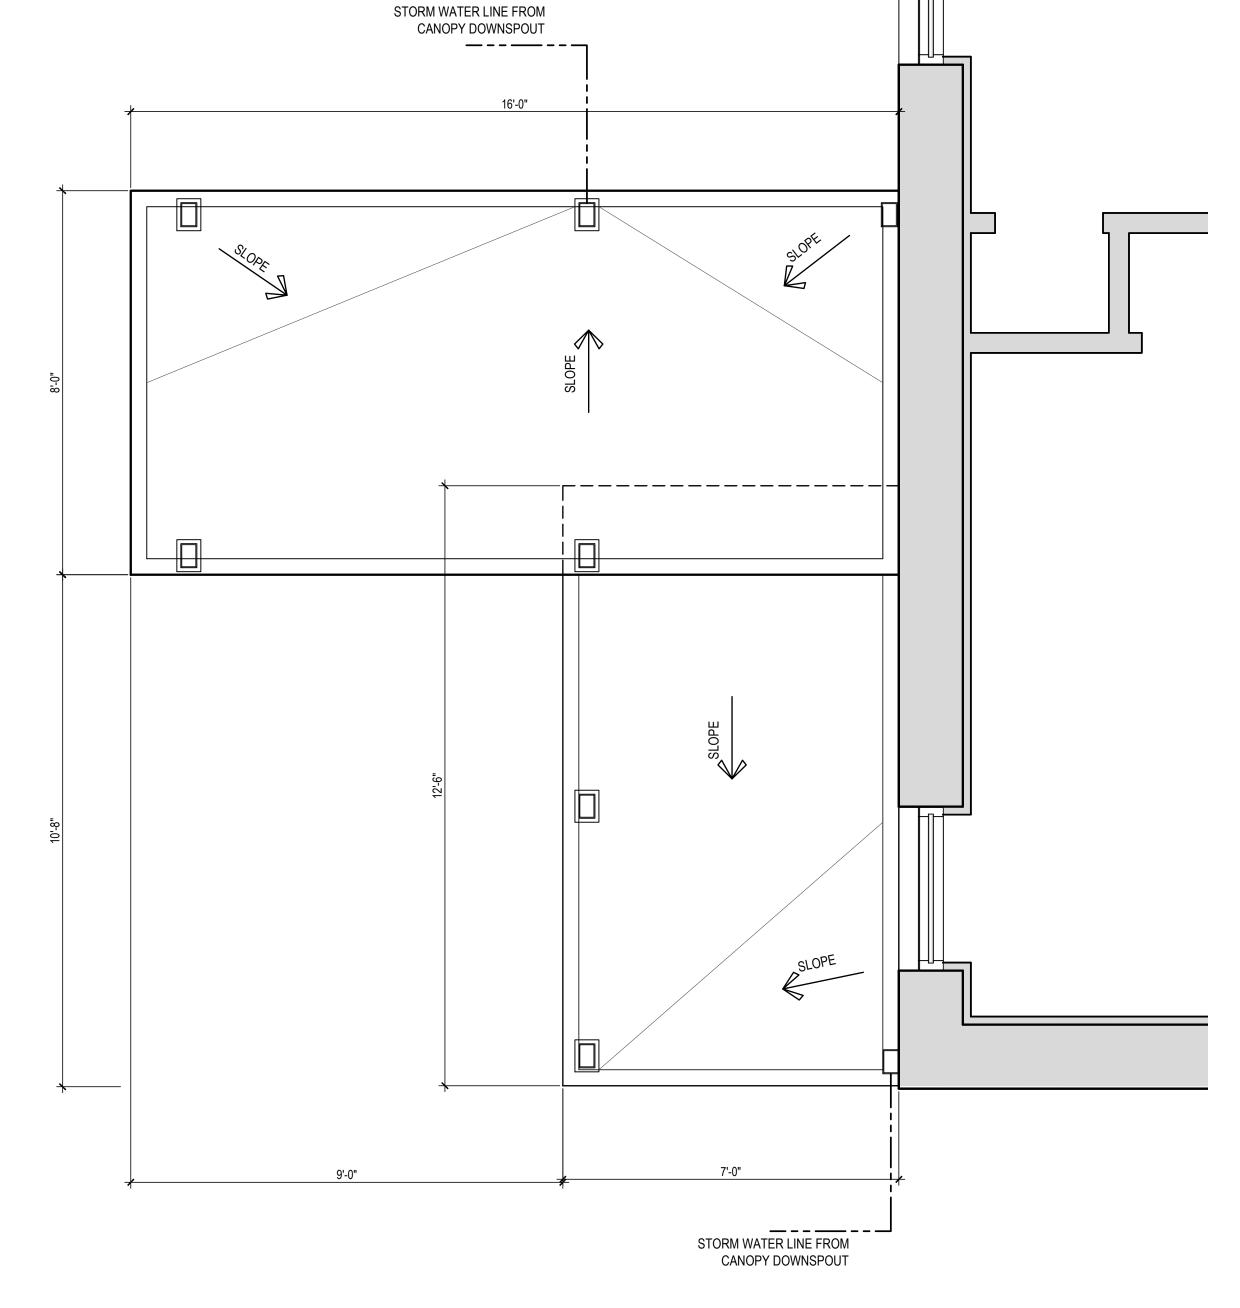
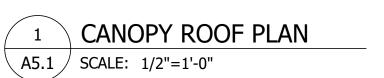
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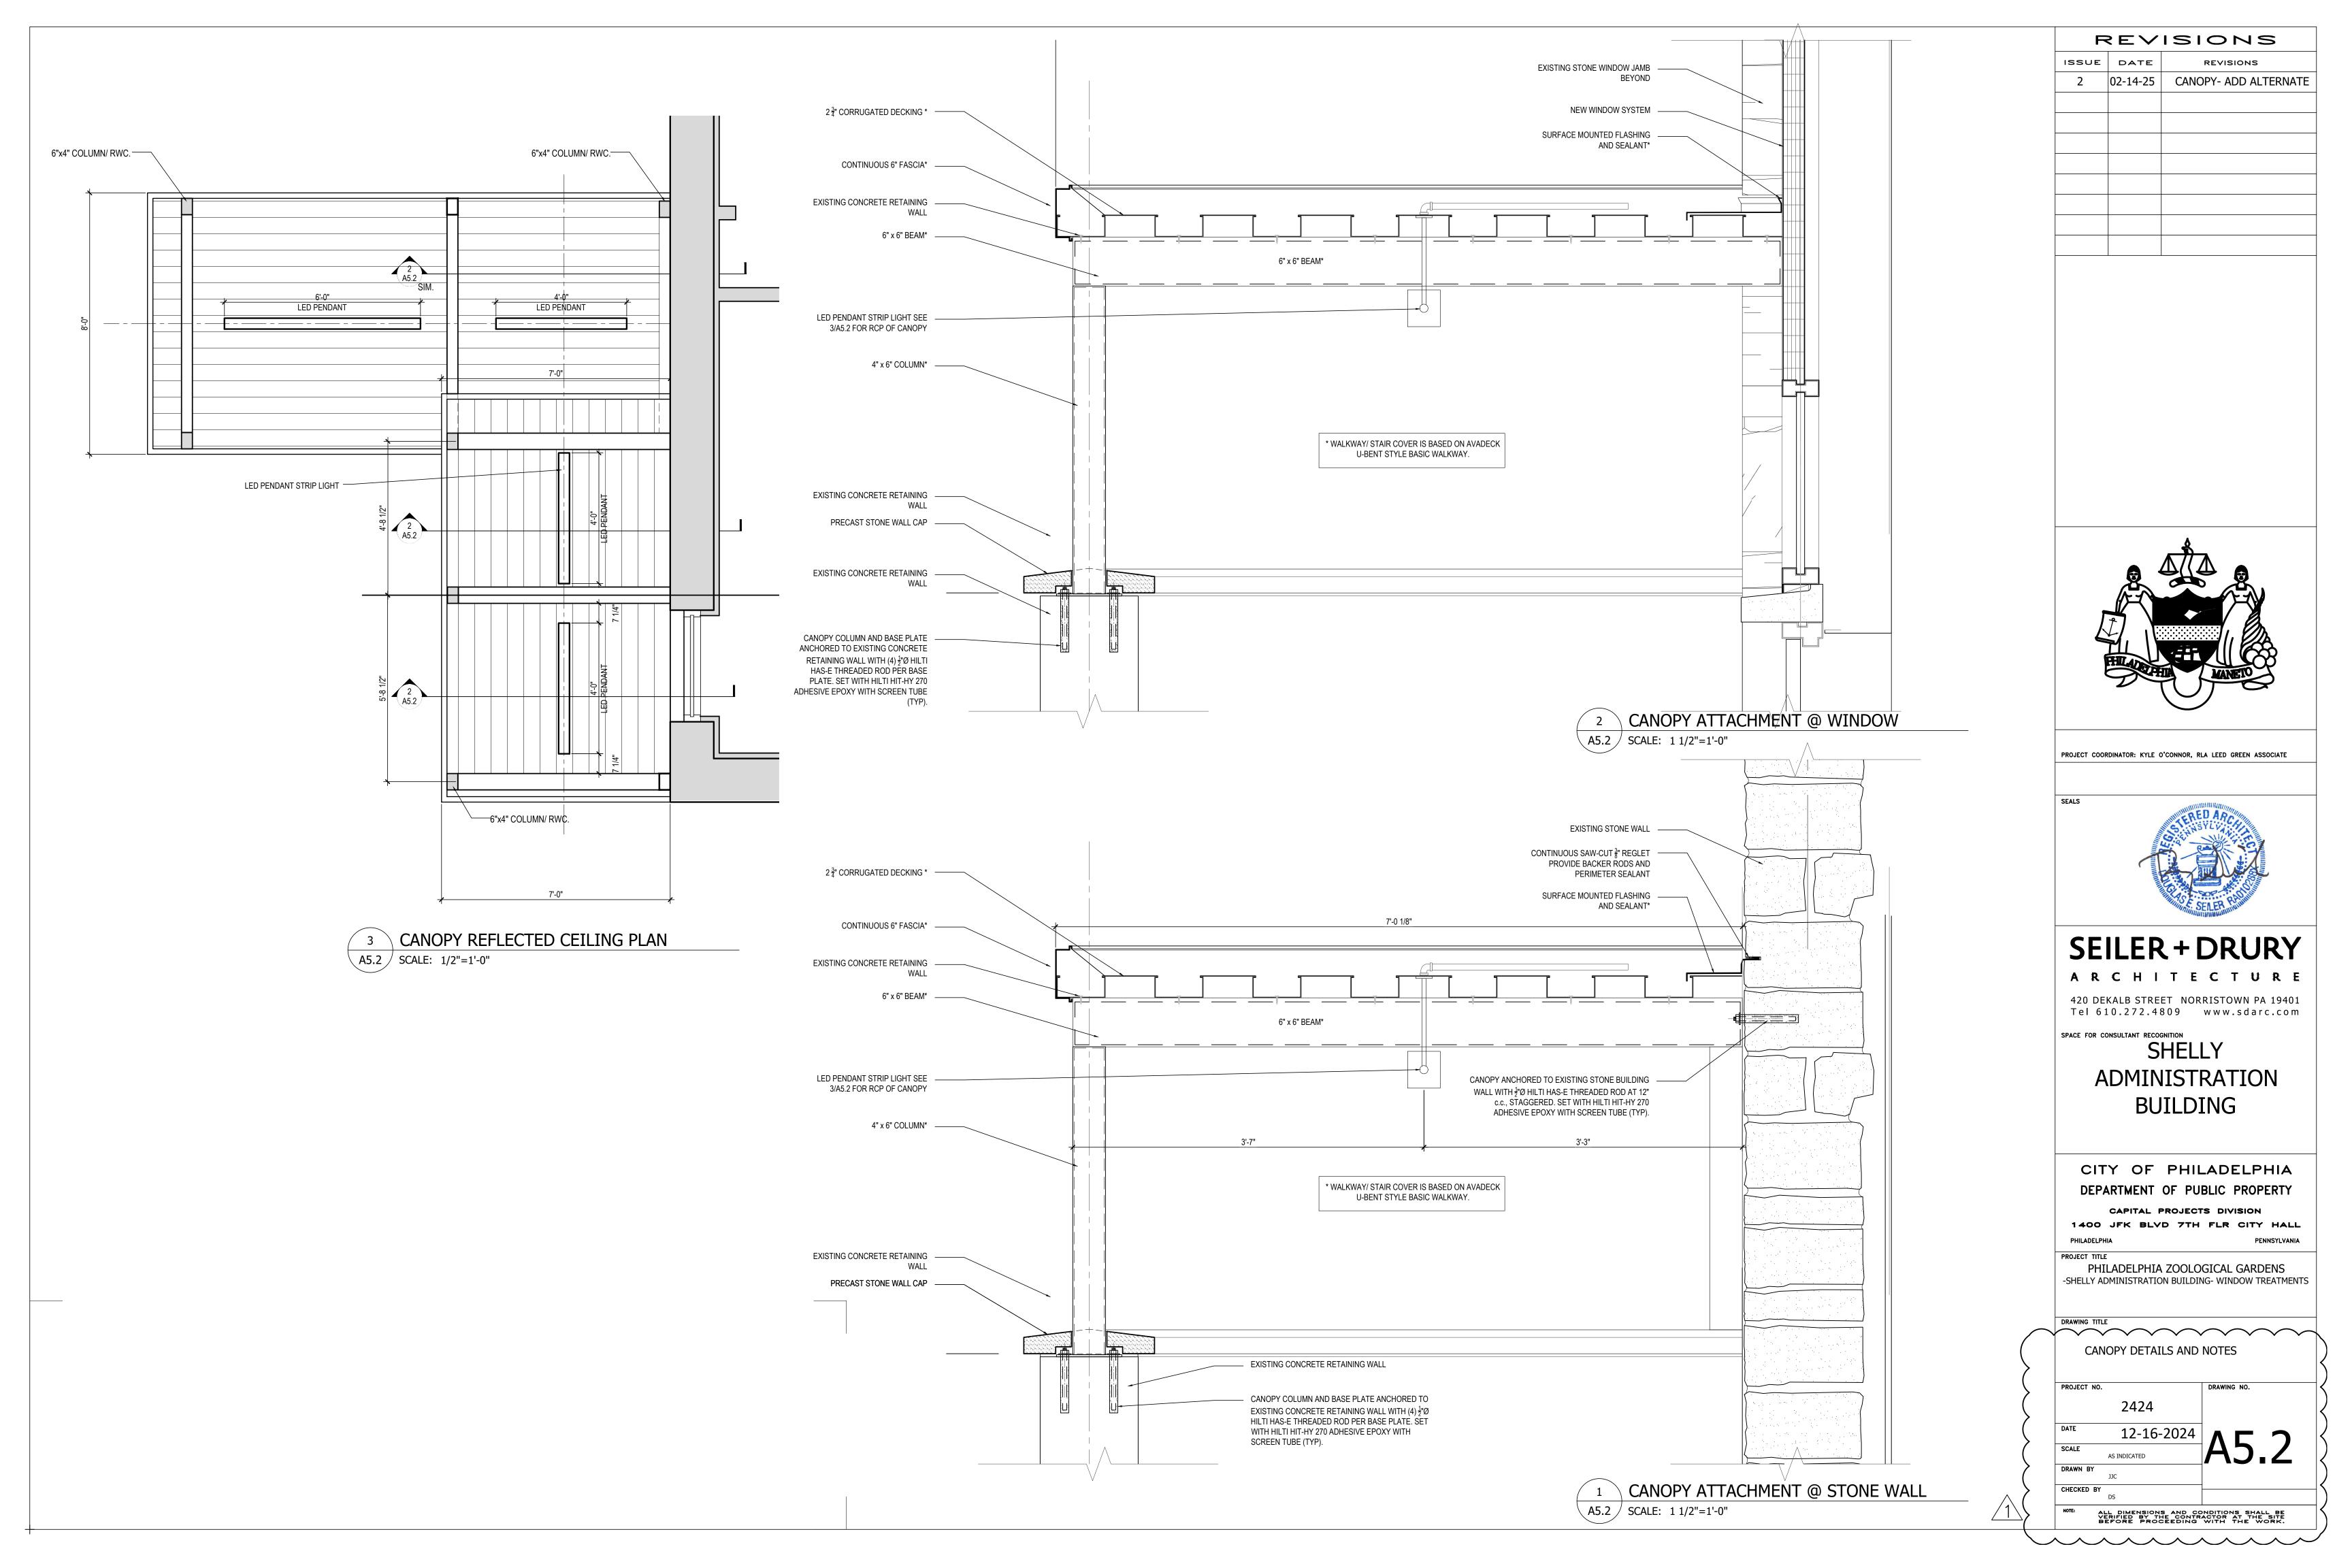
PROJECT TITLE PHILADELPHIA ZOOLOGICAL GARDENS -SHELLY ADMINISTRATION BUILDING- WINDOW TREATMENTS

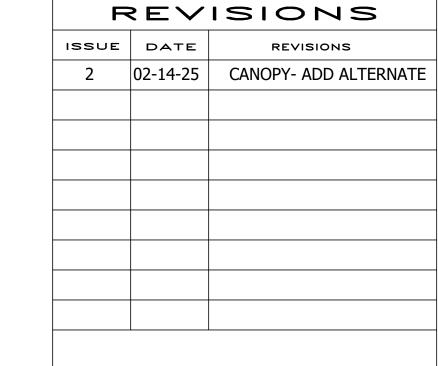CANOPY PLAN AND ROOF PLAN

2424

12-16-2024

PROJECT NO. CHECKED BY



SHELLY ADMINISTRATION BUILDING AT THE PHILADELPHIA ZOO

