W.D. KELLY ELEMENTARY SCHOOL 1601-49 N. 28<sup>TH</sup> STREET PHILADELPHIA, PA 19121-2798

RE: Electronic Message Board Sign

Dear Art Commission Sign Committee,

The W.D. Kelly Elementary School is proposing to Install an Electronic Message Board Sign on the Mural Wall of the school.

The Proposed Sign would be Accessory to the school, and we would like the sign to be available for non-Accessory use for the community. Such as Public and Municipal personnel i.e.: Police, Fire Departments and local communities.

The school will post Events, announcements that will be related to the school. Our intent would be for the community to use this proposed electronic message board for public announcements, job fairs, block parties, special events, etc. The Principal, Dr. Edwards strongly would encourage the Community to utilize the new EMC for such occasions.

No animation will be included with the sign, fixed images-slides only. No motion or flashing. The timeline of messages for each frame will not be changed for at least 8 seconds (as per the Federal Highway Commission). The school will operate the EMC from 7am - 7pm.

Each Optec Display sign comes with an optical eye that automatically measures the ambient light. Therefore, the sign is brightest (8 nits) during the day and lowest at night. As for a rendering.


that would be difficult to present because each location, weather and time of day will change the brightness of the sign. Here are some guidelines from Optec Displays.

- Full sun? 100% brightness capable.
- Partly sunny? 70-100% brightness capable (varies as the sun hits the sensor)
- Partly cloudy? Between 50% and 100% brightness capable (will vary as sun hits sensor)
- Cloudy/Stormy? Between 30% and 70% brightness capable.
- Dusk will vary according to the 4 kinds of weather above.
- Darkness/Overnight will depend on the ambient light in the area. If no other light sources are available, it could be as low as 5%. If the display is in a city area with lots of light sources, it could go up to 40%

Thank you and look forward to hearing from you,

Sincerely,

Reneé Gross Taus & Associates 609-707-1141

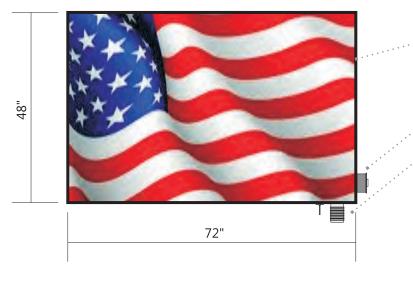

full-color electronic message center, single-sided, extruded aluminum enclosure per header sign, welded/bolted connections to supports, back and side cladding to enclose supports

weather-proof junction box, with disconnect switch

communication antenna and temperature probe (if specified)


120 volt primary in approved conduit to sign by project electrician

Maximum draw of sign is 16 amps at 120 volts

**ELEVATION VIEW** 

1/2" = 1'- 0"



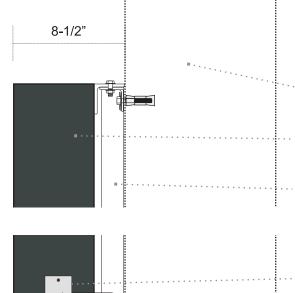

Sound structural masonry wall in excellent condition

Single-sided full color LED message display, ~8-1/2" depth

Welded A36 steel mounting bracket, black painted finish, (8) bolted connections, (4) top, (4) bottom, grade 5 (min) non-corrosive 3/8" steel bolts, evenly spaced

Weather-proof junction box with disconnect switch

3/8" diameter double-expansion anchor, 1-1/2 min embedment, (8) required, (4) top, (4) bottom, evenly spaced

Temperature probe, brightness sensor, and comm antenna located on bottom of sign

120 volt primary in approved conduit to sign by project electrician







Illuminated Electronic LED Message Sign (1) SINGLE-SIDED SIGN AS SHOWN REQUIRED

53688

W B Kelley Elementary School

1601 N 28th St, Philadelphia, PA 19121


Advanced Color Signs & Graphics			N
	Newtown, PA 215-579-9558		0
П	Date	Scale	
	10-9-23, 10-11-23, 2-19-24	as shown	Ε
	Drawn By	Drawing No.	
	HRMc	F2600	- 4

- maximum draw of sign is 16 amps @ 120 volts - (1) 120v, 20 amp, dedicated primary circuits in approved conduits to sign b project electrician according to NEC and sign manufacturers specifications are visconnect toggle switch to be located on junction box - sign control at panel (time-clock) is by project electrician - primary leads will be routed to junction box by sign installer for final

connection by project electrician

- location temp probe and antenna is approximated

REVISION #

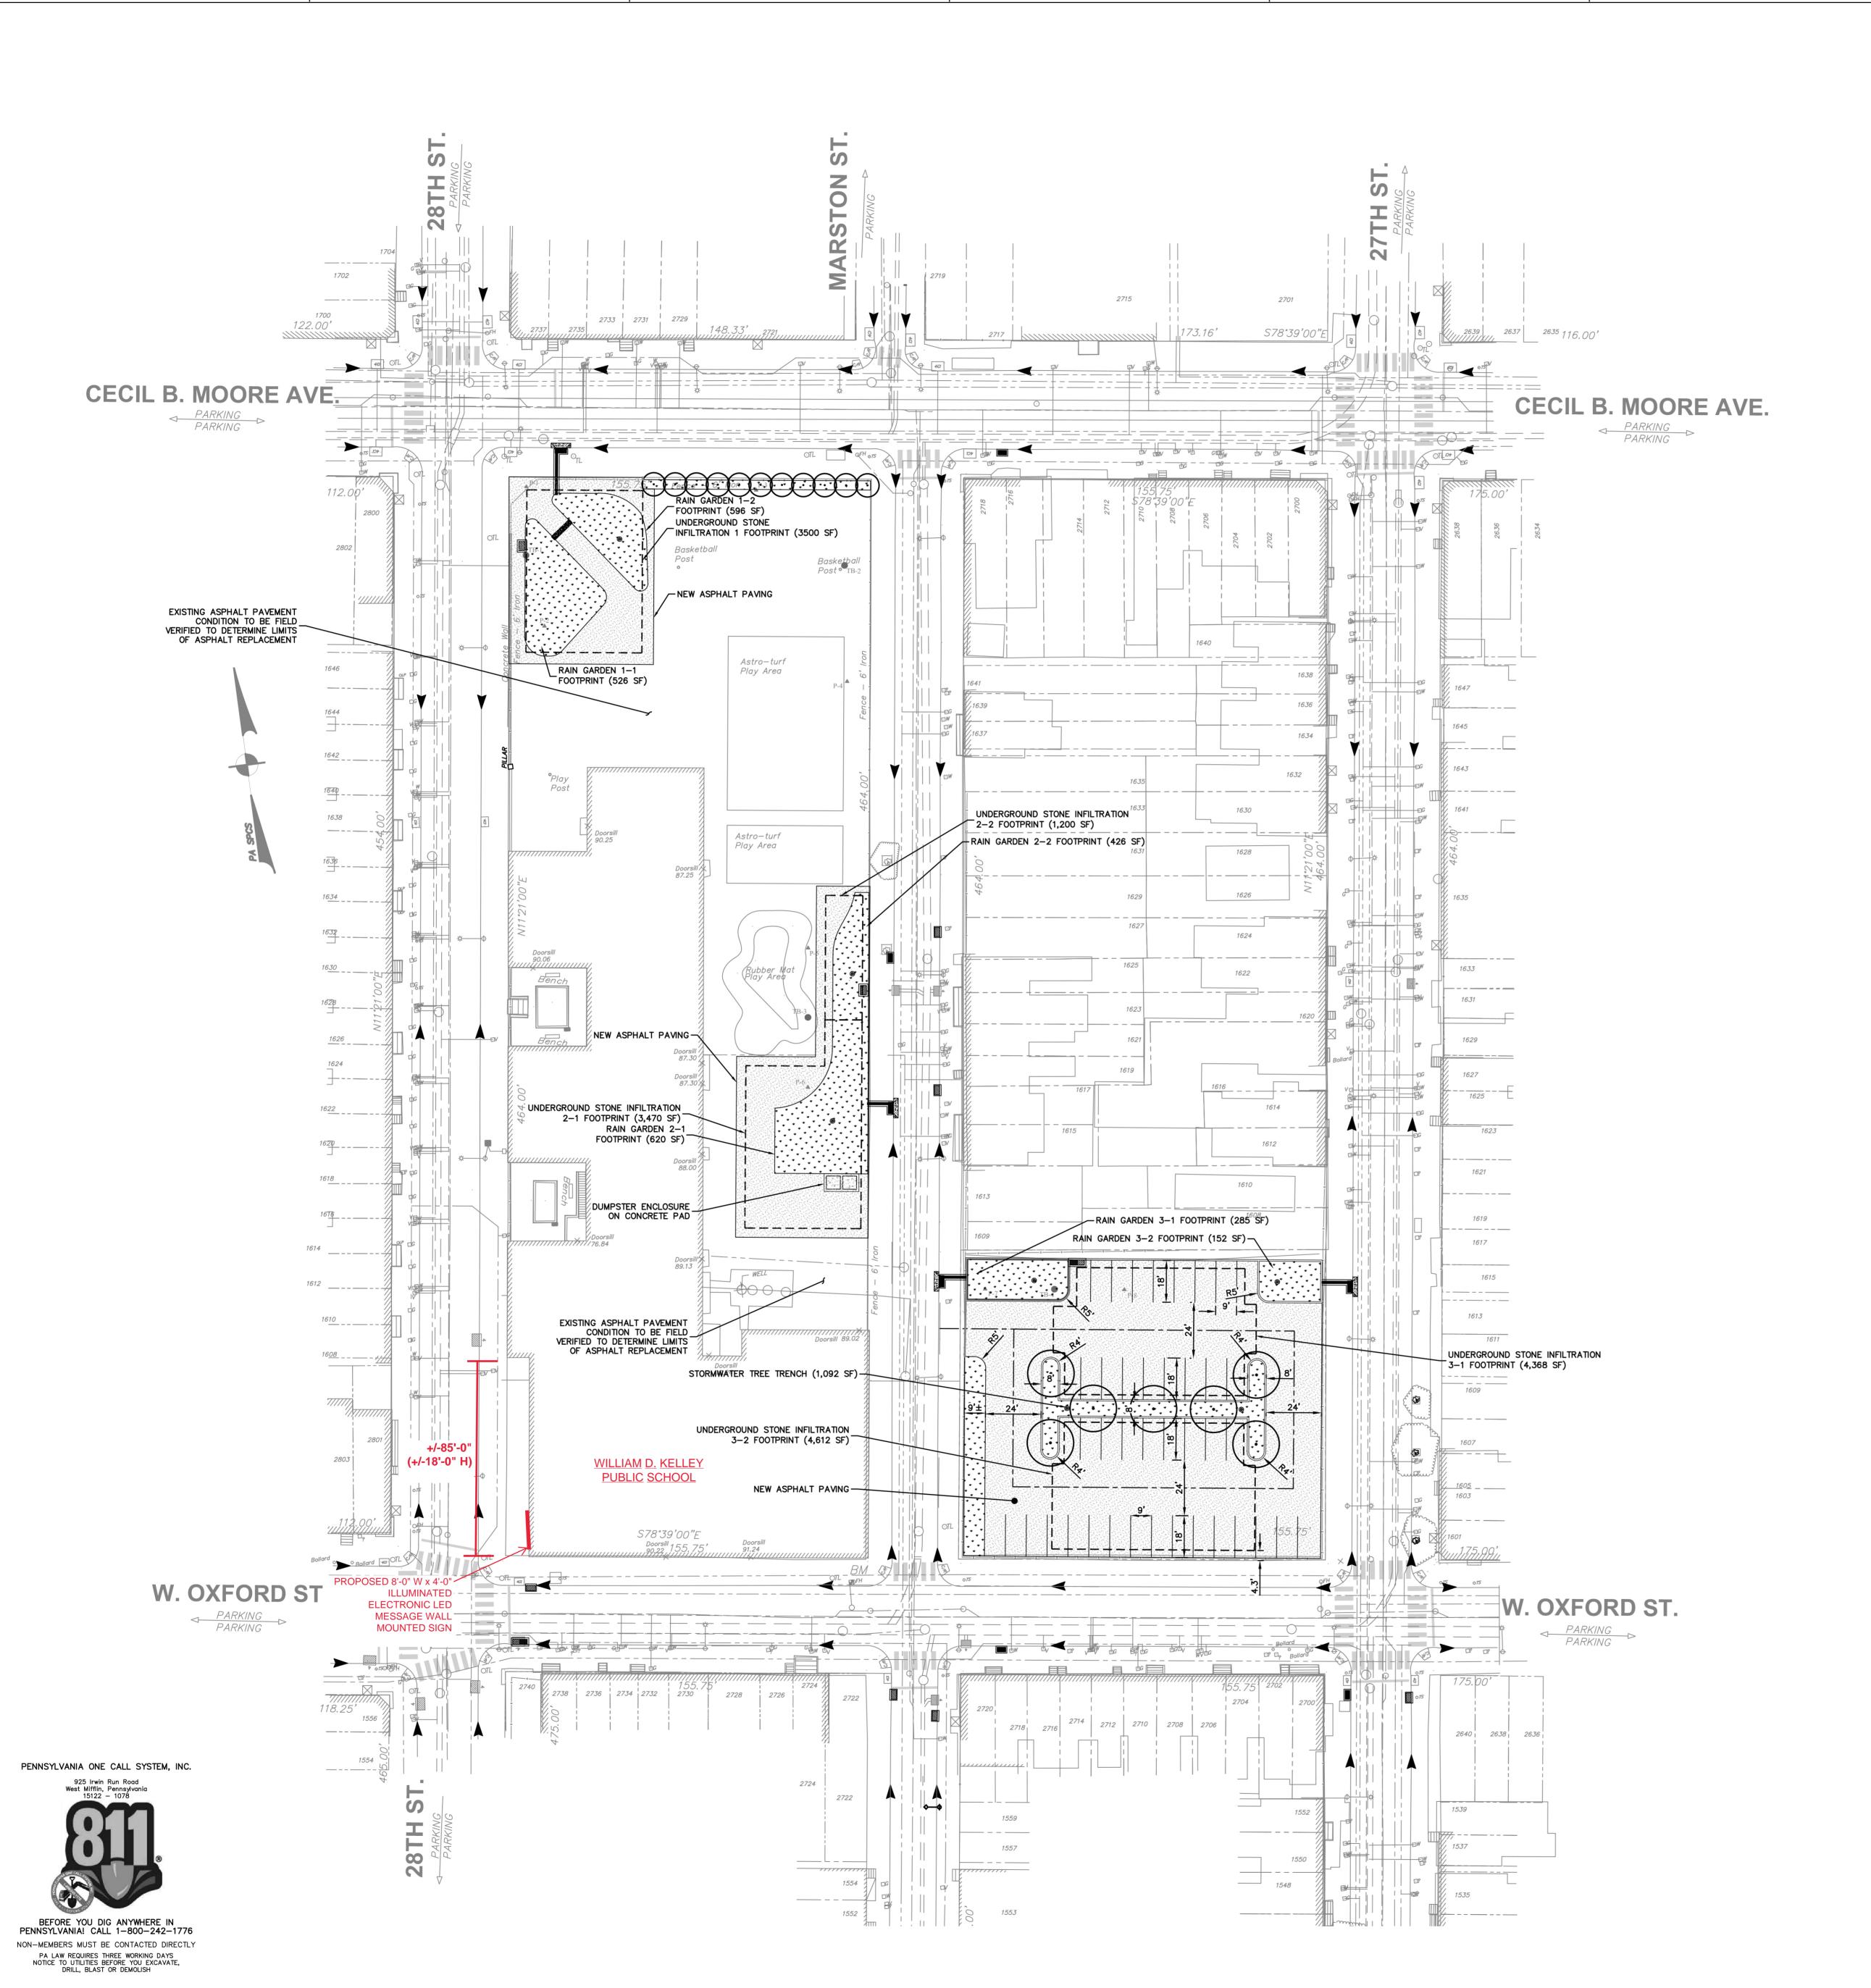

# **GENERAL NOTES:**

- 1. THE SITE FEATURES AND TOPOGRAPHY AS SHOWN ARE BASED ON A FIELD SURVEY PERFORMED BY CEADERVILLE ENGINEERING GROUP, LLC IN SEPTEMBER 2021
- 2. THE PROPERTY LINES SHOWN ARE BASED ON THE METES AND BOUNDS DESCRIPTION CONTAINED IN THE VESTING DEED OF THE SUBJECT PROPERTY ONLY. NO TITLE RESEARCH WAS PERFORMED IN PREPARATION OF THIS PLAN. EASEMENTS, RESTRICTIONS AND/OR COVENANTS MAY APPLY.
- 3. LOCATIONS OF EXISTING UNDERGROUND UTILITIES/FACILITIES SHOWN HEREON HAVE BEEN DEVELOPED FROM ABOVE GROUND OBSERVATION OF THE SITE. NO EXCAVATIONS WERE PERFORMED IN PREPARATION OF THIS DRAWING. THEREFORE ALL UTILITIES SHOWN SHOULD BE CONSIDERED APPROXIMATE IN LOCATION, DEPTH, AND SIZE. THE POTENTIAL EXISTS FOR OTHER UNDERGROUND UTILITIES/FACILITIES TO BE PRESENT WHICH ARE NOT SHOWN ON THIS DRAWING. ONLY THE VISIBLE LOCATIONS OF UNDERGROUND UTILITIES.FACILITIES AT THE TIME OF THE FIELD SURVEY SHALL BE CONSIDERED TRUCK AND ACCURATE. COMPLETENESS OR ACCURACY OF UNDERGROUND UTILITIES/FACILITIES ARE NOT GUARANTEED BY GILMORE & ASSOCIATES INC.
- 4. THE BENCHMARK IS TO BE OBTAINED FROM THE PHILADELPHIA DISTRICT SURVEYOR.
- 5. ALL CONTRACTORS WORKING ON THIS PROJECT SHALL VERIFY LOCATION AND DEPTH OF ALL UNDERGROUND UTILITIES.FACILITIES PRIOR TO THE START OF WORK AND SHALL COMPLY WITH THE REQUIREMENTS OF P.L. 852, NO. 287 DECEMBER 10, 1974 AS LAST AMENDED ON APRIL 28, 2018, PENNSYLVANIA ACT 50. GILMORE & ASSOCIATES INC. HAS OBTAINED A PA-ONE CALL SERIAL NUMBER XXXXXXXXXX FOR DESIGN PURPOSES ONLY.

# **CONCRETE NOTES:**

- 1. PROVIDE CAST-IN-PLACE CONCRETE WITH A MINIMUM 28-DAY COMPRESSIVE STRENGTH OF 4,000 PSI AND IN ACCORDANCE WITH THE CURRENT VERSION OF ACI-318 "BUILDING CODE REQUIREMENTS FOR REINFORCED CONCRETE."
- 2. CONCRETE SHALL CONTAIN EITHER A WATER-REDUCING, PLASTICIZING ADMIXTURE OR A HIGH-RANGE WATER-REDUCING ADMIXTURE. ALL CONCRETE SHALL CONTAIN AN AIR-ENTRAINING ADMIXTURE TO PROVIDE 5%-7% AIR ENTRAINMENT. MAXIMUM CHLORIDE CONTENT SHALL BE 0.15%. MAXIMUM WATER/CEMENT RATIO SHALL BE 0.45. MAXIMUM DESIGN SLUMP OF 3 INCHES WITHOUT SUPER PLASTICIZERS. AGGREGATE SIZE SHALL BE 3/4 OF AN INCH WITH A DESIGNATION OF 4S PER ASTM C33.
- 3. WELDED WIRE FABRIC SHALL BE GALVANIZED AND COMPLY WITH ASTM A185.
- 4. REINFORCING STEEL BARS SHALL BE GRADE 60 PER ASTM A615
- 5. SUBMIT MIX DESIGN TO THE OWNER'S REPRESENTATIVE FOR APPROVAL. THE OWNER'S REPRESENTATIVE MAY REJECT DESIGN MIX FOR NON-COMPLIANCE. RE-SUBMIT DESIGN MIX UNTIL DESIGN PROFESSIONAL APPROVES.
- MARRED. INSULATING BLANKETS WATERPROOFED KRAFT PAPER, OR POLYETHYLENE FILM AS PER ASTM C-171 SHALL BE USED TO KEEP THE CONCRETE CONTINUOUSLY MOIST DURING THE CURING PROCESS.

MOIST CURE ALL CONCRETE WORK AND COMMENCE MOIST CURING AS SOON AS FINISHES WILL NOT BE

- 7. CONCRETE WALKING SURFACES SHALL HAVE A NON-SLIP FINISH. JOINTS SHALL BE TOOLED FIRST AND THEN CONCRETE SURFACE SWEPT FOR NON-SLIP FINISH TO ELIMINATE "WINDOW PANE" LOOK. "WINDOW PANE" CONCRETE FINISH WILL NOT BE ACCEPTED.
- 8. CONCRETE SHALL BE PLACED ON A MINIMUM OF 4 INCHES OF COMPACTED CRUSHED AGGREGATE (NO. 57 OR  $\frac{3}{4}$  INCH CLEAN) PLACED ON COMPACTED SUBGRADE. SUBGRADE SHALL BE NON-YIELDING.

## **ASPHALT PAVING NOTES:**

- PAVING WORK IS LIMITED TO REPLACEMENT OF EXISTING ASPHALT PAVING WHERE REMOVAL OF EXISTING ASPHALT IS REQUIRED FOR THE INSTALLATION OF UNDERGROUND UTILITIES.
- 2. COMPLY WITH APPLICABLE SECTIONS AND PROVISIONS OF THE STANDARD SPECIFICATION OF PAVEMENT CONSTRUCTION PER PENNDOT PUBLICATION 408. BITUMINOUS MATERIALS SHALL BE APPLIED WHEN THE SURFACE IS DRY, FIRM AND CURED, AND OTHERWISE ACCEPTABLE.
- 3. CONTINUITY: NEW PAVING SHALL BE OF LIKE COMPOSITION OF INGREDIENTS FOR UNIFORMITY AND THICKNESS AND SHALL MATCH THE FINISH OF EXISTING ASPHALT PAVING.
- 4. PERFORM THE WORK WITHOUT STAINING OR INJURY TO OTHER PERMANENT WORK, INCLUDING CURBS AND SIDEWALKS.
- WHERE NEW PAVING MEETS EXISTING, CUT EXISTING PAVING AS REQUIRED WITH A POWER SAW TO CLEAN STRAIGHT LINES WITH VERTICAL EDGES. CUT THE EXISTING PAVEMENT TO ALLOW AN OVERLAP OF ONE
- FOOT OF NEW WEARING COURSE OVER THE EXISTING BINDER COURSE ALONG THE CONTINUOUS EDGES
- 6. APPLY PRIMER OF TACK COAT TO ALL EXPOSED SURFACES OF EXISTING WEARING AND BINDER COURSES
- 7. SEAL PAVEMENT JOINTS AND ALONG PAVEMENT/CURB INTERFACE WITH PG64-22 HOT BITUMINOUS JOINT
- 8. INSTALL SUPPORT GEOTEXTILE FABRIC OVER JOINTS IN ACCORDANCE WITH THE MANUFACTURER'S RECOMMENDATIONS.
- 9. THE NEW PAVING SHALL PROVIDE A SMOOTH TRANSITION TO EXISTING PAVING WITHOUT ABRUPT CHANGE IN GRADE. MAINTAIN POSITIVE DRAINAGE AND ELIMINATE LOW SPOTS.


# **LEGEND**

PROPOSED ASPHALT PAVING

PROPOSED DEPAVED AREA

\_\_\_\_

PROPOSED SUBSURFACE STONE STORMWATER STORAGE FOOTPRINT

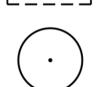

PROPOSED TREE

PROPOSED DUAL TRAP INLET PROPOSED GREEN HIGHWAY INLET PROPOSED HIGHWAY INLET PROPOSED GREEN CITY INLET

PROPOSED STORMWATER CLEANOUT PROPOSED DOMED RISER STRUCTURE

PROPOSED TRENCH DRAIN

Water Curb Box Gas Curb Box Water Box Unknown Curb Box PECo Pole PECo Pole w/ Light SEPTA Pole OSP Traffic Light OTL Traffic Sign • TS o IP Iron Pole Bollard Parking Meter Clean Out O DS Down Spout  $\square$  MB Hand Hole Cable Handhole Survey Stone Traffic Control Box (Above Ground) Verizon Juction Box Bench Mark Fire Hydrant Electrolysis Test Station Highway Grate Inlet (4 Denotes 4 FT, 6 Denotes 6 FT)

Old Grate Inlet (#1,#2,#3 or #4 Denotes Size)

Gas Valve

Door Sill

LEGEND Unknown Utility Manhole Utility Manhole Cellar Door Steps Porch Planter Bus Shelter Curb Ramp Compliant Curb Ramp Tree/Trunk Size in " ⊕ 10" Stump Tree Stump w/ Trunk in " Existing Pavement Markings Trash Receptacle

<del>x x x</del> Fence ------ Right-of-Way Line o—o Bike Rack Existing Top/Bottom of Step Grate Inlet 6 Denotes 6 FT) City Inlet 6 Denotes 6 FT) Old City Inlet (#1,#2,#3 or #4 Denotes Size)

Existing Top/Bottom of Curb Frank Existing Spot Elevation C. Curb Concrete Curb G. Curb Granite Curb SI. Curb Slate Curb C. Ftw. Concrete Footway Br. Ftw. Brick Footway A. Ftw. Asphalt Footway SI. ftw. Slate Footway Dep. Curb Depressed Curb Br. Gutter Brick Gutter D/W Driveway St. Wall Stone Wall Br. Wall Brick Wall C. Wall S.R.L.

Concrete Wall Sewer Return Elevation Sewer Return Location



THE SCHOOL DISTRICT OF PHILADELPHIA

**OFFICE OF CAPITAL PROGRAMS** 

**440 NORTH BROAD STREET** 

SEAL:

(215) 400 - 4730 | (215) 400 - 4731 (fax) www.philasd.org

PHILADELPHIA, PA 19130 - 4015

NOT ISSUED FOR CONSTRUCTION

LANDSCAPE ARCHITECT AND CIVIL ENGINEER

GILMORE AND ASSOCIATES Inc 1617 JFK BLVD. Suite 425

Philadelphia, PA 19103 Phone: 215-687-4246 Attn: Kevin Selger, RLA

SURVEYOR
CEADERVILLE ENGINEERING GROUP, LLC

159 East High Street, Suite 500 Pottstown, PA 19464 Phone: 610-705-4500

PRELIMINARY DESIGN SUBMISSION OCTOBER 1, 2021

NO. DATE REVISION SCHOOL & LOCATION WILLIAM D. KELLEY SCHOOL

1601 N. 28TH STREET

PROJECT TITLE **GREEN STORMWATER IMPROVEMENT PROJECT** 

DRAWING TITLE SITE PLAN

DRAWING SCALE 1" = 30' FILE NO. LOCATION NO. DRAWN BY CHECKED BY


CONSULTANT CONTRACT NO.


SHEET OF

DRAWING NO.

L-2.0



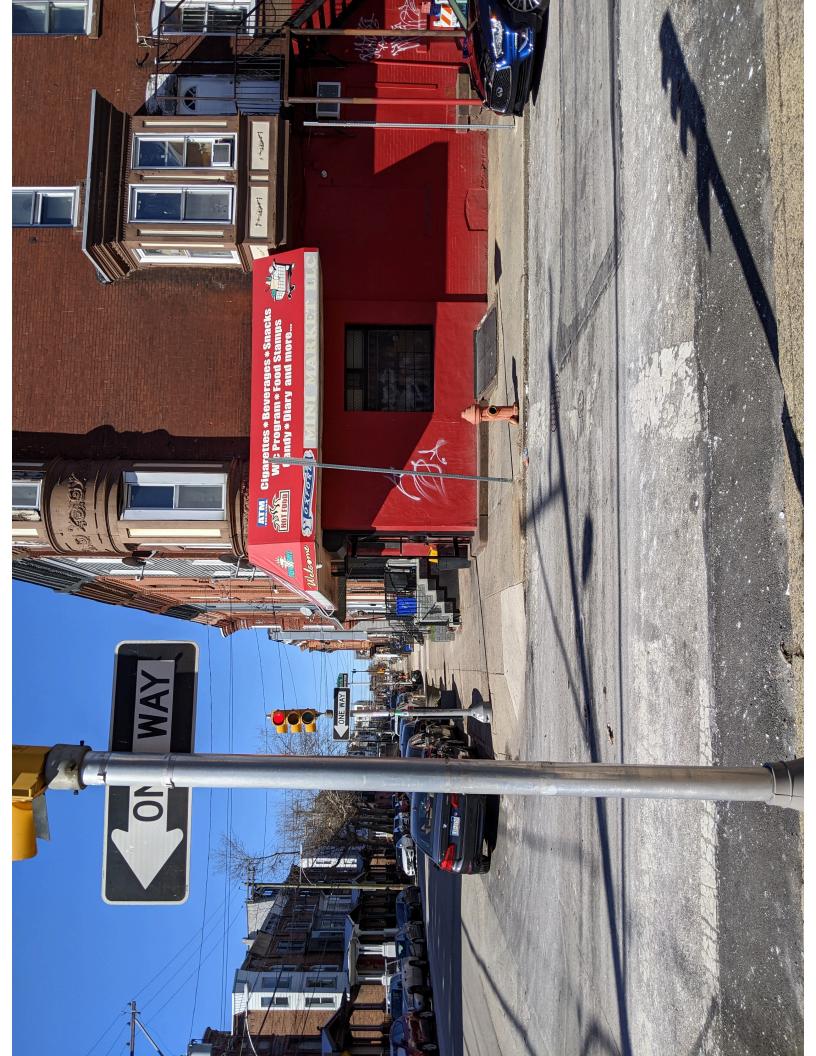

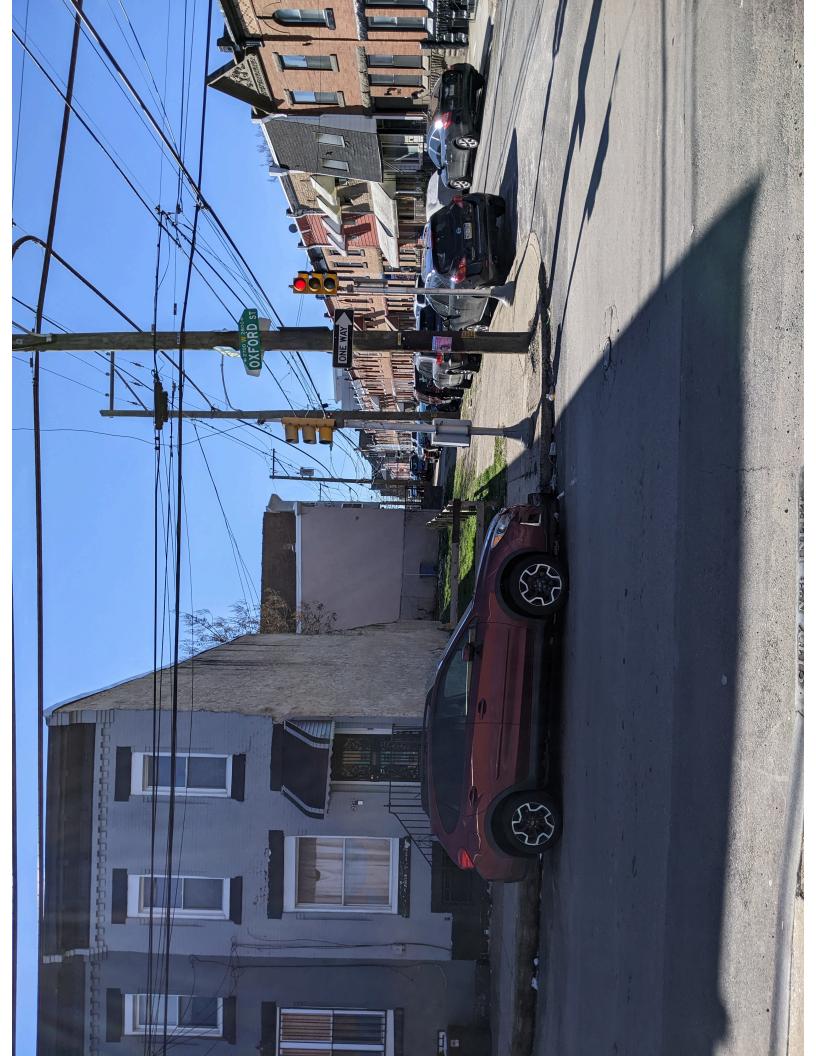

### Fw: ] W. B. Kelley Elem. EMC Sign -response from Mural Artist ZP-2023-013453

### Renee Gross <reneeg10@aol.com>

Wed 4/10/2024 9:44 AM

External Email Notice. This email comes from outside of City government. Do not click on links or open attachments unless you recognize the sender.

### Good Morning All,

The Mural Artist responded in a positive way to the sign on the Mural Wall. Please see his approval letter below and please let us know if this is official enough to satisfy that requirement.

Thank you,

Reneé Gross 609-707-1141

From: "David McShane" <david.mcshane@muralarts.org>

Sent: 4/9/24 11:23 AM To: brad@acgcolor.com

Cc: Emma Lynn Melvin <emelvin@philasd.org>

Subject: Re: [EXTERNAL SENDER] W. B. Kelley Elem. EMC Proposal

#### Hi Brad,

Thank you for reaching out to me. I was the lead artist on that mural project, and appreciate your sensitivity toward the aesthetics of the mural and sign placement. I do not want to stand in the way of the sign going up - especially if the Principal sees it as an important communication tools with parents and community. Based on the attached photo you sent - the sign doesn't obstruct of interfere with the mural imagery, which I appreciate. The one thing I would ask is that any wires that may need to lead to the sign to provide the electricity similarly be sensitively placed (so they don't cut across one of the faces of the portraits, for instance).

Best of luck in the project, Dave McShane

David McShane Director of Resident Artists



Mural Arts Philadelphia
The Lincoln Financial Mural Arts Center
1727-29 Mount Vernon Street
Philadelphia, PA 19130
610-324-9193
david.mcshane@muralarts.org