ADDRESS: 2033 CHESTNUT ST

Proposal: Construct four-story building on rear of parcel

Review Requested: Final Approval Owner: George and Tassia Tahopoulos

Applicant: John Hayes, Blackney Hayes Architects

History: 1915

Individual Designation: None

District Designation: Rittenhouse Fitler Historic District, Contributing, 2/8/1995 Staff Contact: Dan Shachar-Krasnoff, daniel.shachar-krasnoff@phila.gov

Overview: This application seeks final approval for the construction of a four-story multi-unit building at the rear of 2033 Chestnut Street in the Rittenhouse Fitler Historic District. No work is proposed to the existing building at 2033 Chestnut Street that fronts on Chestnut Street. The new building will face Ranstead Street at the rear, which is the edge of the historic district boundary. The building will not be visible from Chestnut Street, but will be visible from S. 21st Street to the west. The building's design is contemporary and technically lacks compatibility with the historic district; however, the location of the proposed building is limited in terms of immediate surrounding historic context, therefore its highly differentiated design will not impact the character of the Rittenhouse Fitler Historic District. The majority of this block of Ranstead Street is not located within the historic district boundary, and the overall context of the block is three- and four-story red brick buildings.

SCOPE OF WORK:

Construct four-story building on rear of parcel.

STANDARDS FOR REVIEW:

The Secretary of the Interior's Standards for the Treatment of Historic Properties and Guidelines include:

- Standard 9: New additions, exterior alterations, or related new construction shall not destroy historic materials that characterize the property. The new work shall be differentiated from the old and shall be compatible with the massing, size, scale, and architectural features to protect the historic integrity of the property and its environment.
 - The proposed new construction generally lacks compatibility with the historic district. However, it will not be visible from Chestnut Street. The lack of historic context on Ranstead Street, much of which is not within the district, means that the design will not have an adverse impact. The proposed application meets Standard 9.
- Standard 10: New additions and adjacent or related new construction will be undertaken in such a manner that, if removed in the future, the essential form and integrity of the historic property and its environment will be unimpaired.
 - The proposed new construction on Ranstead Street is not attached to the contributing building at 2033 Chestnut Street; therefore, the proposal meets Standard 10.

STAFF RECOMMENDATION: Approval, with the staff to review details, pursuant to Standards 9 and 10.

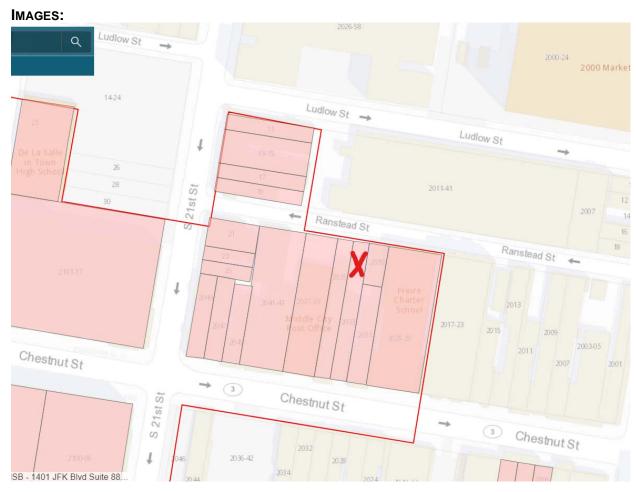


Figure 1. Location of subject property at the northern edge of Rittenhouse Fitler Historic District boundary.



Figure 2. Location of proposed building on Ranstead Street.



Figure 3. Ranstead Street immediately east of proposed building.



Figure 4. Ranstead Street west of proposed building.



Figure 5. Looking east from S. 21st Street onto Ranstead Street. The proposed building will be half-way down this block on the right.



MEMORANDUM | 02

Multifamily Building 2033 Chestnut Street, Philadelphia, PA 19103 BHA Job No. 22-127

Building Permit Application No. CP-2023-003995
Zoning Permit No. CP-2023-000765

DATE OF ISSUANCE: August 15, 2023

TO: Philadelphia Historical Commission

City of Philadelphia

On behalf of our client, Mr. Thom Tahopoulos, we request that the Commission review our application for the proposed new construction of a three-story multifamily building to the rear of the existing multifamily mixed-use building at 2033 Chestnut Street. Please note that we are proposing no work to the existing building at 2033 Chestnut Street that fronts on Chestnut Street; the proposed new construction is detached from and structurally independent of the existing building.

Our proposed new construction on this block of Ranstead Street would contrast notably with the block's utilitarian present appearance. Today the neighboring residential structure at 2030 Ranstead is outnumbered by the unadorned facades, rear parking and loading docks up and down the block. We believe our proposal is neutral to Chestnut Street while enhancing the quality of this block of Ranstead Street in step with the Commission's directive.

In support of the building permit application, we have prepared the following on 11x17 pages:

- 1. Site and building section of the proposed and existing buildings
- 2. Photographs of the existing conditions along Ranstead Street
- 3. Photographs of the existing conditions along Chestnut Street

Sincerely,

Chris Stigler

Principal

Joe Ulaky

Acting Project Architect


Copies to: [Owner, File]

600 Chestnut Street Suite 1200 Philadelphia, PA 19106 t. 215-829-0922 f. 215-829-0596 www.blackneyhayes.com

John Hayes, FAIA
Kevin Blackney, AIA, LEED AP
Jennifer Crawford, AIA
Michele Barnett, AAHID
Merixsa Garcia-Johnson
Megan Hayes Barton, NCIDQ
Troy C. Hill, AIA, ALEP
Darin Jellison, AIA
Chris Stigler, AIA, LEED AP

ASSOCIATES

Carmen Bushong, AIA Tyler Cooney, AIA, LEED AP Patrick Gallagher, RA, CSI, CDT Traci Luckenbill, AIA John Townsend, NCIDQ

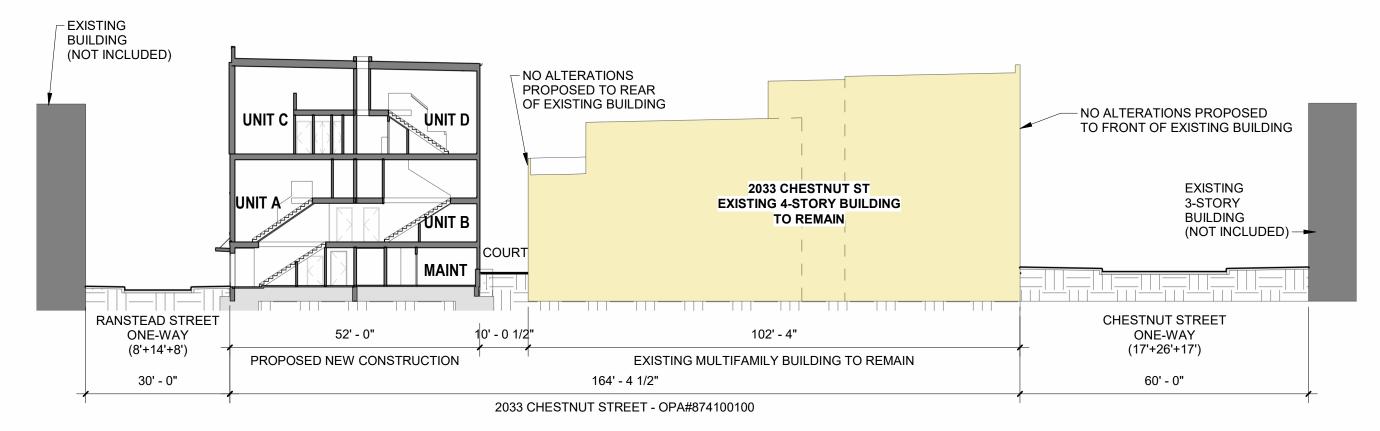

SITE SECTION - STREET TO STREET

1" = 20'-0"

Site Section

2033 Chestnut Street Multifamily Building

prepared for: Thom Tahopoulos



08.15.2023







2030 RANSTEAD STREET REAR OF 2035 CHESTNUT STREET REAR OF 2035 CHESTNUT STREET

RANSTEAD STREET PHOTOS

2033 Chestnut Street Multifamily Building

prepared for: Thom Tahopoulos 08.15.2023



This drawing is not to be copied or transmitted in any form without the express written authorization of Blackney Hayes Architects.

All ideas and concepts depicted or suggested in this drawing are the property of Blackney Hayes Architects.







VIEW LOOKING EAST DOWN RANSTEAD STREET FROM WEST OF SITE

RANSTEAD STREET PHOTOS

2033 Chestnut Street Multifamily Building


prepared for: Thom Tahopoulos 08.15.2023



This drawing is not to be copied or transmitted in any form without the express written authorization of Blackney Hayes Architects.

All ideas and concepts depicted or suggested in this drawing are the property of Blackney Hayes Architects.



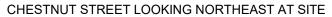



EXISTING BUILDING AT 2033 CHESTNUT STREET



CHESTNUT STREET LOOKING NORTHWEST AT SITE

CHESTNUT STREET PHOTOS

2033 Chestnut Street Multifamily Building


prepared for: Thom Tahopoulos 08.15.2023



This drawing is not to be copied or transmitted in any form without the express written authorization of Blackney Hayes Architects.

All ideas and concepts depicted or suggested in this drawing are the property of Blackney Hayes Architects.



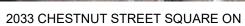



2033 CHESTNUT STREET LOOKING NORTHWEST


CHESTNUT STREET PHOTOS

2033 Chestnut Street Multifamily Building

prepared for: Thom Tahopoulos 08.15.2023



REVISED/SUPPLEMENTED

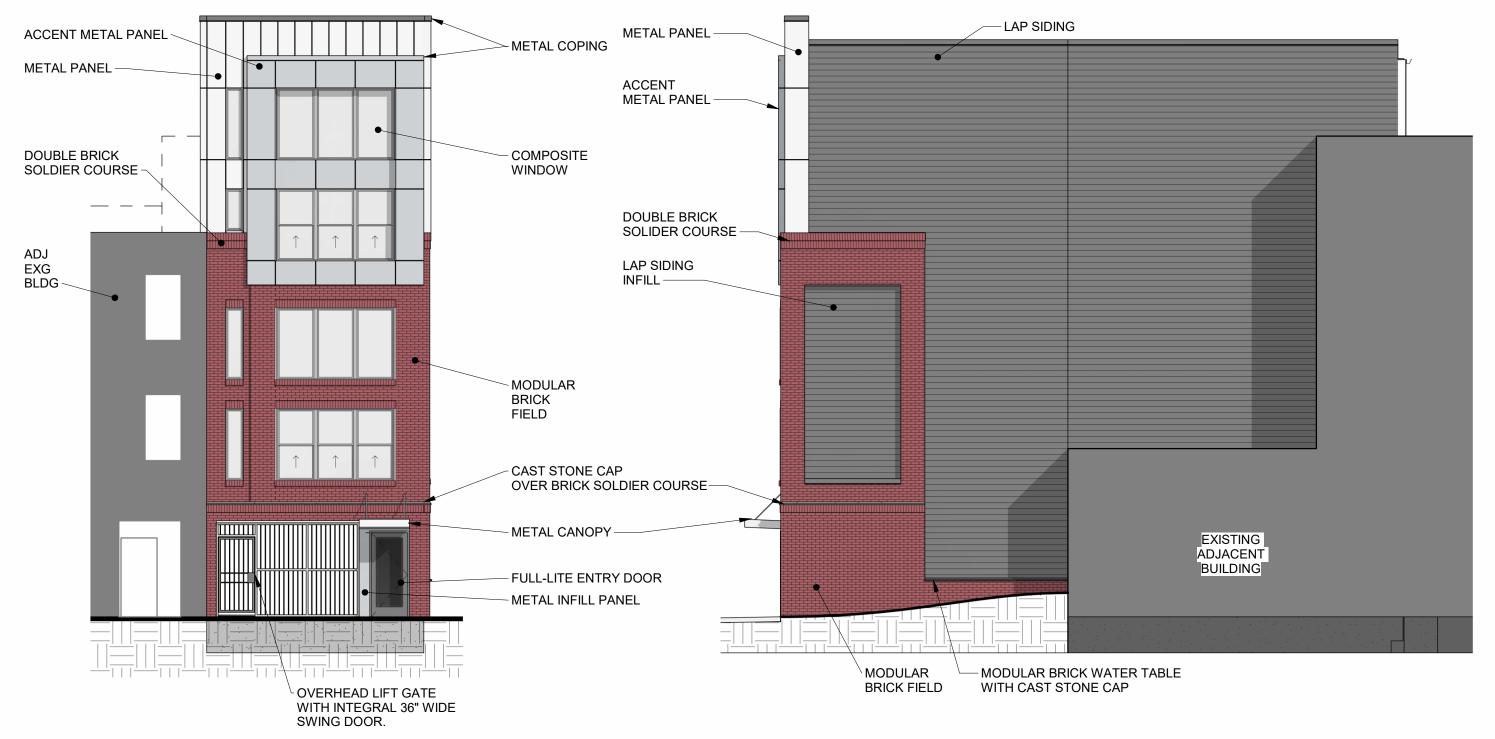

REVISED RANSTAD ST ELEVATION (NORTH)

1/8" = 1'-0"

REVISED WEST SIDE ELEVATION

1/8" = 1'-0"

Elevations


2033 Chestnut Street Multifamily Building

prepared for: Thom Tahopoulos

08.31.23



SUPPLEMENTED

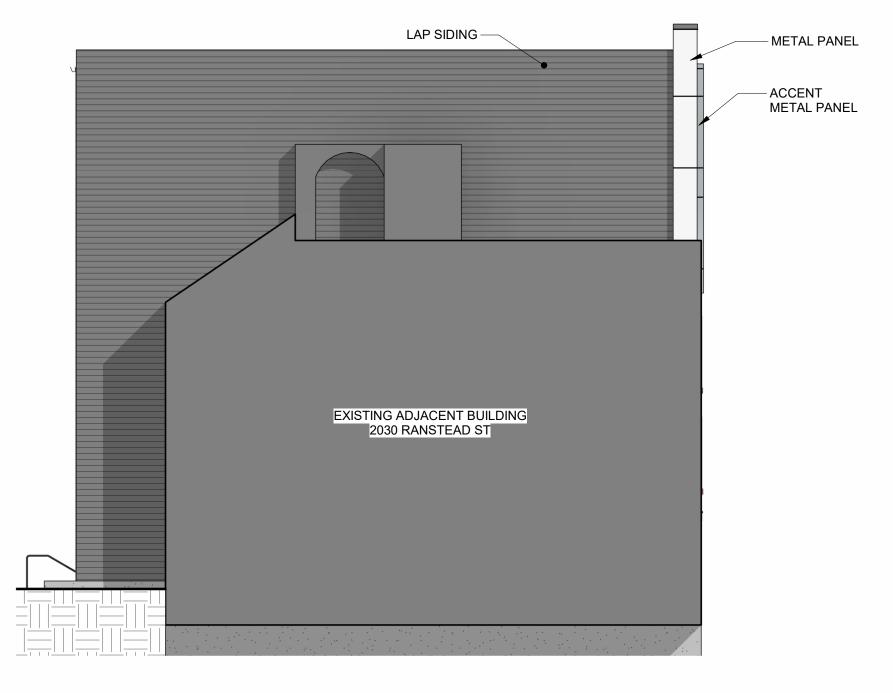

REVISED EAST SIDE ELEVATION

1/8" = 1'-0"

Elevations

2033 Chestnut Street Multifamily Building

prepared for: Thom Tahopoulos 08.31.23



Revision 2 07.21.2023

2033 Chestnut Street Multifamily Building

2033 Chestnut St Philadelphia, PA 19103



FRONT (NORTH) ELEVATION ON RANSTEAD STREET

ISSUE INFORMATION

COORDINATION SET 02.22.2023
REVISION 1 06.16.2023

CIVIL

1500 Spring Garden St, Suite 1100, Philadelphia, PA 191 phone: 215.665.7000 CONTACT PERSON: Greg Gress

STRUCTURAL

1255 Drummers Ln, Suite 201, Wayne, PA 19087 phone: 484.475.2180 CONTACT PERSON: Steve Krumenacker

Thom Tahopoulos 1210 Heather Knoll Ln Media, PA 19083 phone: 610.909.0204

OWNER

Blackney Hayes Architects 600 Chestnut Street, Suite 1200 Philadelphia, PA 19106 phone: 215.829.0922 x154 CONTACT PERSON: Chris Stigle 2033 Chestnut Street Multifamily Building 2033 Chestnut St Philadelphia, PA 19103



PLUMBING LEGEND										
P1					P2					
KITCHEN SINK	4		KITCHEN FAUCET		BATH SINK	ROOM		BATH	ROOM ET	
	JNDERMOUN SINK 24"	T STAINLESS STEEL	GOOSENECK MFR: STYLE/NO: COLOR/NO: FINISH: LOCATION:	PULL DOWN FAUCET MANUFACTURER STYLE BRUSHED NICKLE FINISH KITCHEN		12" OVAL UN PORCELIAN V MFR: STYLE/NO: COLOR/NO: FINISH: LOCATION:			WIDESPREAD FAUCET MFR: STYLE/NO: COLOR/NO: FINISH: LOCATION:	MANUFACTURER STYLE COLOR BRUSHED NICKLE BATHROOM
P3					P4					
N S C		ED SHOWER HEAD MANUFACTURER STYLE COLOR BRUSHED NICKLE BATHROOM	SHOWER CONTROL SINGLE HANI BALANCING V MFR: STYLEINO: COLORINO: FINISH: LOCATION:	DLE WITH PRESSURE VALVE MANUFACTURER STYLE COLOR BRUSHED NICKLE BATHROOM	TOILE		MANUFACTURER STYLE COLOR WHITE BATHROOM			
PLUMBIN	NG HARDWAR	E NOTES:								
PLUMBING HARDWARE NOTES: 1. ALL HARDWARE INCLUDING RUBBERS & SCREWS TO BE POLISHED CHROME FINISH 2. CONTRACTOR REQUIRED TO CONFIRM COMPATABLITY WITH EXISTING PLUMBING VALVES AND COMPONENTS PRIOR T 3. VLF. REQUIRED DIMENSIONS FOR EACH ROOM CONDITION 4. NEW DRAINS TO BE SET FLUSH TO NEW FLOOR TILE.					IENTS PRIOR TO ORD	ERING.				

	ACCESORY & APPLIANCE SCHEDULE								
TYPE	/PE DESCRIPTION MANUF. MODEL COMMENTS								
A1	TOILET PAPER HOLDER								
A2	MIRROR			SURFACE MOUNTED					
A3									
	SHOWER GLASS DOOR AND FIXED PANEL			30" X 72" DOOR AND 6' FIXED PANEL, SQ. CLIP HARDWARE					
AP1	DISHWASHER								
AP2	REFRIGERATOR/FREEZER								
AP3	RANGE/OVEN								
AP4									
AP4	MICROWAVE/HOOD			RECIRCULATING- VENTLESS					

LIQUENO COUEDUS E								
	LIGHTING SCHEDULE							
L1	L2	L3	L4					
ITEM NAME: A" RECESSED DOWNLIGHT MFR: RAYON LIGHTING STYLEND: RFL3 COLORNO: WHITE DIMENSION S" RECESSED COLOR TEMP: ZTX RFL3-8-27-018-SRLW-3TLW NOTES: TO BE USED AT 8' CEILINGS	ITEM NAME: MFR: ARYON LIGHTING STYLEND: DIMENSION: FILA COLORING: WHITE DIMENSION: FIRE FILA FILE FILE FILE FILE FILE FILE FILE FILE	ITEM NAME: UNDERCOUNTER LIGHT MFR: RAYO LIGHTING STYLEND: COLORN: COLOR FINANT STORM	TEM NAME: BATH SCONCE OMYGEN STYLEND: SASBATS/24 COLORNO: MATTE WHITE ACRYLIC/ SATIN NICKLE 24 DIMENSION: COLOR TEMP: 2700K x 4.79 H NOTES:					
L5	L6	L7						
TIEM NAME: ENTRY PENDONT MFR: OLIGITHNO STYLENO: GL3725-A-GM-A OLOGRANO: GUM METAL DIMENSION: 24'DIA OLOGRANO: 3000K NOTES-CONTRACTOR TO DETERMINE IF EMERGENCY LIGTING IS REQUIRED	TEM NAME: BOH LIGHTING HEP. STYLEND: LINEAR BOS SELECTABLE FOLOGRAPH HIP STRIP COLORING: WHITE HOUSE HIP STRIP COLOR TEMP: 35K SDS.X-1224L-8CST-UNV-DIM NOTES:	TEM MAME: CLOSET LINEAR LIGHT MANUFACTURER STYLENO: STMLE COLORNO: COLOR FINISH DIMENSION DIMENSION DIMENSION NOTES: EMB. 27K						

WINDOW	BLINDS
BL1	BL2
ITEM NAME: MOTORIZED SHADES HER REGRAND HER LEGRAND HE	ITEM NAME: MANUAL SHADES MOE. EN: GEORAD MOE. ST. ST. ST. ST. ST. ST. ST. ST. ST. ST
NOTES: VERIFY DIMENSIONS WITH WINDOWS	NOTES: VERIFY DIMENSIONS WITH WINDOWS

					FINISH LE	GEND					
PAINT						WALLE	ASE				
PT-1	MFR: STYLE/NO: COLOR/NO: FINISH: LOCATION:	SHERWIN WILLIAMS SW 7004 SNOWBOUND MATTE GENERIC WALLS	PT-2	- MFR: STYLE/NO: COLOR/NO: FINISH: LOCATION:	SHERWIN WILLIAMS SW 7004 SNOWBOUND EGGSHELL BATH	WB-1	3" PAINT GRA BASE. PAINTED PT-X LOCATION:	DE SANITARY WALL GENERIC WALLS	WB-2	3" PAINT GRA BASE. PAINTED PT-X LOCATION:	DE SANITARY WA
PT-3	MFR: STYLE/NO: COLOR/NO: FINISH: LOCATION: MFR: STYLE/NO: COLOR/NO: FINISH: LOCATION:	SHERWIN WILLIAMS STYLE COLOR MATTE CEILING SHERWIN WILLIAMS STYLE TBD SEMI GLOSS METAL ACCENT		MFR: STYLE/NO: COLOR/NO: FINISH: LOCATION: MFR: STYLE/NO: COLOR/NO: FINISH: LOCATION:	SHERWIN WILLIAMS SW 7968 IRON ORE SEMI GLOSS DOOR & TRIM COMMON AREA SHERWIN WILLIAMS STYLE COLOR EGSSHELL LOBBY	TB-1	MFR: STYLE/NO: COLOR/NO: FINISH: SIZE: LOCATION: MATCH FT-1	TRINITY TILE STYLE COLOR FINISH BATH	TB-2	MFR: STYLE/NO: COLOR/NO: FINISH: SIZE: LOCATION: MATCH FT-2	TRINITY TILE STYLE COLOR FINISH LOBBY
PT-7	MFR: STYLE/NO: COLOR/NO: FINISH: LOCATION:	SHERWIN WILLIAMS STYLE COLOR SEMI GLOSS DOOR & TRIM	PT-8	MFR: STYLE/NO: COLOR/NO: FINISH: LOCATION:	SHERWIN WILLIAMS STYLE COLOR MATTE COMMON AREA WALLS	i					
			PT-9	MFR: STYLE/NO: COLOR/NO: FINISH: LOCATION:	SHERWIN WILLIAMS SW 7004 SNOWBOUND SEMIGLOSS GENERIC WALLS						
FLOO	RING					WALL	FINISH				
LUXUR	RY VINYL TILE (LVT-X)					TILE (WT-X)				
LVT-1	MFR: STYLE/NO: COLOR/NO: FINISH: SIZE: LOCATION:	AVA FAVE PENNINSULA OAK CANYON TBD 12 MIL UNITS		MFR: STYLE/NO: COLOR/NO: FINISH: SIZE: LOCATION:	AVA 2DSGN PENINSULA OAK TIMBER FINISH 12 MIL LANDINGS/STAIRS	WT-1	STYLE/NO: COLOR/NO: SIZE: FINISH: PATTERN: LOCATION:	DALTILE STENCIL WHITE 4X12 FINISH RAILROAD BATH JSE ALLOWANCE OF	68/SF F	OR.	
LVT-3	MFR: STYLE/NO: COLOR/NO: FINISH: SIZE: LOCATION:	AVA 2DSGN COLOR FINISH 12 MIL LAUNDRY ROOM				WT-2	MFR: STYLE/NO: COLOR/NO: SIZE:	TRINITY TILE APHLIO TRITON II PORCELAIN 2X6			
FLOOF	R TILE (FT-X)						FINISH: PATTERN:	GLOSSY			
* CONT 4\$/SF F FT-2 * CONT MATER MISC.	MFR: STYLE/NO: COLOR/NO: SIZE: PATTERN: FINISH: LOCATION: FRACTOR TO L FOR MATERIAL MFR: STYLE/NO: COLOR/NO: SIZE: PATTERN: FINISH: LOCATION:	TRINITY TILE STYLE STYLE TED TED TED TED TED BATH TED BATH TED FARAMOUNT KINGSTON TIGGRAKINBLK3000P BARAMOUNT KINGSTON TIGGRAKINBLK3000P BARAMOUNT KINGSTON TIGGRAKINBLK3000P BASKETWEAVE MATTE LOBBY SE ALLOWANCE OF 48/SF	SC-1	SEALED CONC MFR: STYLE COLO FINISH LOCA'	TRINITY TILE I/NO: STYLE R/NO: COLOR I: FINISH	WALLO	LOCATION: LOCATION: LOCATION: COVERING (WC MFR: STYLE/NO: COLORINO: FINISH: LOCATION:	BACKSPLASH JSE ALLOWANCE OF			
SS-1	MFR: STYLE/NO: COLOR/NO: FINISH: LOCATION:	WILSONART Q4059 CALACATTA SERCHIO FINISH UNITS KITCHENS	SS-2	MFR: STYLE/NO: COLOR/NO: FINISH: LOCATION:	COLORQAURTZ CQ707 PALOMA WHITE POLISHED BATHROOM COUNTER						
CABINE	ETS (CB-X)										
CB-1	MFR: STYLE/NO: COLOR/NO: FINISH: LOCATION:	CROWNPOINT (BASIS OF DESIGN) RIFTCUT WHITE OAK PEARL FINISH UNITS KITCHENS CABINETS	CB-2	MFR: STYLE/NO: COLOR/NO: FINISH: LOCATION:	ARMSTRONG (BASIS OF DESIGN) CALIBRE II SLATE SEMIGLOSS BATHROOM VANITY						
TERRA	ZZO SHOWER	PAN (TZ-X)									
TZ-1	MFR: STYLE/NO: COLOR/NO: FINISH: LOCATION:	MANUFACTURER STYLE COLOR FINISH UNITS KITCHENS CABINETS									

		ROC	M SCH	EDULE			
		_		FII	NISHES		1
NO.	NAME	AREA	FLOOR	BASE	WALL	CEILING	COMMENTS
	_						
1ST FLOO		07.05	let o	ITD 0	Int o		
	ENTRY	27 SF		TB-2 WB-1	PT-6 PT-1		
10A 10B		16 SF		WB-1			1
	UTILITY	17 SF 100 SF		WB-1	PT-1		_
11	LAUNDRY				PT-X		
11A	UTIL	7 SF		WB-1	PT-1		
12	MAINT	155 SF		WB-1	PT-1		
12A	TOILET	23 SF		TB-1	PT-2		
12B	MECH	10 SF	SC-1	WB-1	PT-1		
2ND FLOC							
21	UNIT A	263 SF		WB-1	PT-1		1
21A	CL		LVT-1	WB-1	PT-1		
21B	BTHRM	48 SF		TB-1	PT-2		
21C	MECH	11 SF		WB-1	PT-1		
23	2ND LANDING	105 SF		WB-1	PT-1		
25	UNIT B	302 SF		WB-1	PT-1		
25A	MECH	12 SF		WB-1	PT-1		
25B	BTHRM	36 SF	FT-1	TB-1	PT-2		
2ND LOFT							
22	A LOFT	157 SF	LVT-1	WB-1	PT-1		
22A	CL	31 SF	LVT-1	WB-1	PT-1		
26	B LOFT	149 SF	LVT-1	WB-1	PT-1		
26A	CL	27 SF	LVT-1	WB-1	PT-1		
29	2ND LOFT LANDING	113 SF	LVT-2	WB-1	PT-8		
3RD FLOC	R	<u> </u>	•		<u>'</u>		•
31	UNIT C	325 SF	LVT-1	WB-1	PT-1		
31A	CL	4 SF	LVT-1	WB-1	PT-1		
31B	CL	6 SF	LVT-1	WB-1	PT-1		
31C	MECH	11 SF		WB-1	PT-1		
31D	BTHRM	52 SF	FT-1	TB-1	PT-2		
33	3RD LANDING		LVT-2	WB-1	PT-8		
35	UNIT D	257 SF		WB-1	PT-1		
35A	BTHRM	38 SF		TB-1	PT-2		1
3RD LOFT	1						'
32	C LOFT	147 SF	I VT-1	WR-1	PT-1		
32A	CL		LVT-1	WB-1	PT-1		1
36	DLOFT	125 SF		WB-1	PT-1		1
36A	CL		LVT-1	WB-1	PT-1		+



phone: 215.829.0922 x154 CONTACT PERSON: Chris Stigler

OWNER Thom Tahopoulos phone: 610.909.0204

STRUCTURAL DCI+Macintosh Engineers phone: 484.475.2180 CONTACT PERSON: Steve Krumenacker

CIVIL
Stantec
phone: 215.665.7000
CONTACT PERSON: Greg Gress

2033 Chestnut Street Multifamily Building

Project Address: 2033 Chestnut St Philadelphia, PA 19103

Sheet Title:
SCHEDULES



Release		
Date	Comments	
=		\perp
-		+-
-		+-
$\overline{}$		\perp
-		
-		_
$\overline{}$		
		+-
-		+-
$\overline{}$		

BHA Job Number:	22-127
Scale:	1/8" = 1'-0"
Drawn By:	JU
Checked By:	CS
Approved By:	JH

FLOOR PLAN GENERAL NOTES

- CONTRACTOR TO VERIFY ALL FIELD DIMENSIONS AND INFORM ARCHITECT OF ALL DISCREPANCIES PRIOR TO COMMENCEMENT OF ALL WORK.
- NOTIFY ARCHITECT IN WRITING OF ANY DISCREPANCIES OR CONFLICTS IN THE LOCATION(S) OF NEW CONSTRUCTION. UPON COMPLETION OF PARTITION LAYOUT, NOTIFY THE ARCHITECT FOR VERIFICATION OF THE LAYOUT PRIOR TO PARTITION INSTALLATION.
- ALL WORK WILL CONFORM TO ALL APPLICABLE BUILDING REGULATIONS (STATE AND LOCAL). IT IS THE CONTRACTOR'S RESPONSIBILITY TO HAVE A THOROUGH WORKING KNOWLEDGE OF ALL CODE ISSUES.
- THE SUBMISSION OF PRICING BY THE CONTRACTOR SHALL BE EVIDENCE THAT THE CONTRACTOR HAS FULLY EVALUATED POTENTIAL PROBLEMS. THAT THE CONTRACTOR HAS FULLY EVALUATED POTENTAL PROBLEMS.
 LATER ADDITIONAL COST CLAIMS FOR LABOR, EQUIPMENT, MATERIAL, AND
 HARDSHIP (EXCEPT FOR CONDITIONS CONCEALED) WILL NOT BE
 CONSIDERED.
- FOR INTERIOR DIMENSIONS: ALL DIMENSIONS ARE TO THE FINISHED FACE OF PARTITIONS, CENTERLINE OF COLUMNS, AND THE CENTERLINE OF MULLIONS, U.O.N.
- FOR EXTERIOR DIMENSIONS: ALL DIMENSIONS ARE TO THE EXTERIOR FACE OF STUDS, CENTERLINE OF COLUMNS, AND THE CENTERLINE OF MULLIONS, U.O.N.
- DIMENSIONS MARKED +/- MEAN A TOLERANCE OF NOT GREATER THAN 2 INCHES FROM INDICATED DIMENSION, UNLESS NOTED OTHERWISE.
- SET FINISH DOOR OPENINGS AT 6" FROM ADJACENT PERPENDICULAR PARTITION U.O.N.
- 11. NEW CONSTRUCTION SHOWN ALIGNED WITH EXISTING CONSTRUCTION SHALL BE INSTALLED FLUSH AND SMOOTH
- 12. [NOT USED / RESERVED]

- 15. ALL EXPOSED STEEL SURFACES TO BE PAINTED, U.O.N.
- UNLESS OTHERWISE NOTED, ALL FIRE EXTINGUISHERS TO BE CENTERED ON WALL LENGTH OR 16" FROM NEAREST ADJACENT CORNER OR DOOR AS SHOWN, PROVIDE FIRE EXTINGUISHERS IN QUANTITY REQUIRED BY CODE. PROVIDE APARTMENT UNITS WITH FIRE EXTINGUISHER (S) ON EACH LEVEL.

REFLECTED CEILING PLAN GENERAL NOTES

- THE CONTRACTOR SHALL DESIGN AND PROVIDE A FIRE SPRINKLER SYSTEM FROM THE EXISTING MAIN. THE WORK SHALL FULLY COMPLY WITH ALL APPLICABLE REQUIREMENTS OF NPPA13, LOCAL AUTHORITIES, LIFE SAFETY CODE 101 AND THE OWNER'S INSURANCE UNDERWRITER.
- COORDINATE SPRINKLER HEAD LOCATIONS WITH THE REFLECTED CELING PLAN AND DUCT DISTRIBUTION SYSTEM ABOVE. IN OWS CELINISS, LOCATE HEADS ON CENTRE RUBBE OF LEHR PYDYTRIES AND ECUIDISTAIN BETWEEN HEADS ON THE CONTROL OF THE STATE O
- CONTRACTOR WILL BE RESPONSIBLE FOR FOLLOWING ALL CONTRACT DOCUMENTS (ARCHITECTURAL & ENGINEERING,) NO VARIANCE WILL BE ALLOWED, UNLESS DIRECTED & APPROVED BY OWNER, ANY CHANGES TO THE DOCUMENTED SCOPE OF WORK WILL REQUIRE THE GREEFAL MANUEL OF THE DOCUMENTED SCOPE OF WORK WILL REQUIRE THE GREEFAL THE OFFICE OF THE GREEFAL WAS ALLOWED TO THE OWNER OF ALL TRADES INVOLVED IN THE CEILING WORK TO INSURE CLEARANCES FOR FIXTURES, DUCTS, PIPING, CEILING SUPERIOR OF THE CEILING WORK TO INSURE CLEARANCES FOR FIXTURES, DUCTS, PIPING, CEILING SUPERIOR OF THE OWNER OF THE OWNER OF THE OWNER OWNER OWNER OF THE OWNER OW

- CONTRACTOR TO INSPECT AND ENSURE THAT ALL EXISTING SYSTEMS ARE OPERATIONAL UPON COMPLETION OF WORK, RETURNS AND DIFFUSERS ARE SHOWN IN EXISTING LOCATION, CONTRACTOR TO RELOCATE DEVICES AS REQUIRED PER NEW LAYOUT TO ENSURE ADEQUATE DISTRIBUTION. CONTRACTOR TO RE-BALANCE SYSTEM.
- CONTRACTOR TO RELOCATE AND/OR PROVIDE NEW LIGHT SWITCHES PER NEW I AYOUT. RE-CIRCUIT EXISTING LIGHT FIXTURES AS SHOWN PER PLAN.
- CONTRACTOR TO PROVIDE FIRE PROOFING/FIRE STOPPING (AT RATED AREAS ONLY) AT ALL PENETRATIONS WITHIN EXISTING AND NEW SHAFT WALLS, FLOOR SLAB AND EXTERIOR WALLS, PENETRATIONS TO INCLUDE BUT NOT LIMITED TO DUCTWORK, PIPEWAYS, CONDUIT RUNS.
- PERIMETER CEILING ANGLE, WHERE OCCURS, SHALL BE INSTALLED TIGHT TO VERTICAL SURFACES, FREE FROM CURVES, BREAKS, OR OTHER IRREGULARITIES AND PAINTED TO MATCH CEILING FINISH, CEILING GRIDS SHALL BE LEVEL & TRUE, WITH PROPER EDIG MOLDING AND DETAILS AS RECOMMENDED BY THE MANUFACTURER CAPS BETWEEN CEILING ANGLE AND EXISTING VERTICAL SURFACES ARE TO BE HELD AT NO LANGER THAN CEILING SURFACES AND EXISTING VERTICAL SURFACES ARE TO BE HELD AT NO LANGER THAN CEILING SURFACES ON SYSTEM TO BE INSTALLED PER MANUFACTURER'S SPECIFICATIONS WITH A LEVEL TOLERANCE OF 18° IN 12.
- WHERE DEVICES WHERE REMOVED FROM WALL, CONTRACTOR TO PROVIDE DRYWALL PATCH AT AREA WHERE DEVICE WAS REMOVED. NO BLANK PLATES WILL BE PERMITTED.
- PROVIDE HANGERS & SUPPORTS IN ACCORDANCE WITH MFR. RECOMMENDATIONS, APPLICABLE CODES & ORDINANCES. PROVIDE SEISMIC BRACING AS REQUIRED.
- INSTALL ACOUSTICAL PANELS WITH UNDAMAGED EDGES AND FIT ACCUPANT ELY MYOUND SYSTEM WINNERS AND EDGE MODIFIED ACCUPANT ELY MYOUND SYSTEM WINNERS AND EDGE MODIFIED AND ELY PRECISE FIT PANT CUT LEDGES OF PANEL REMAINING EXPOSIDE AFTER INSTALLATION, MATCH COLOR OF EXPOSED PANEL SUFFACES USING COATING RECOMMENDED BY ACOUSTICAL PANEL PROVIDER.

SYMBOLS LEGEND

(A XX' - XX') CEILING TAG

101

Wall Finish Base Finish Floor Finish

101

 \bigotimes

 \otimes

F-###

- CLEAN EXPOSED SURFACES OF ACOUSTICAL PAREL CEILINGS, INCLUDING TRIM, EDGE MOLDINGS AND SUSPENSION MEMBERS, COMPLY WITH MANUFACTURER'S INSTRUCTIONS FOR CLEANING AND TOUCHUP OF MINOR FINISH DAMAGE.
- RECEPTACLE AND LIGHT SWITCH INSTALLATION SHALL CONFORM TO REQUIREMENTS SET FORTH BY ICC/ANSI 117.1, 2009.
- RECEPTACLE FACE PLATES A PLUSS TO BE TO MATCH COLOR OF EXISTING DEVICES. ALL WALL MOUNTED RECEPTACLES SHALL BE MOUNTED ITS OFFICENCES OF THE PLUS OF T
- UNLESS OTHERWISE NOTED, TENANT IS RESPONSIBLE FOR ALL TELEPHONEDATA WIRING. CONTRACTOR TO COORDINATE WITH TENANTS TELEPIDATA VENDOR OR SCHEDULING AND LOCATION. CONTRACTOR TO PROVIDE BACK BOX AND PULL RINGISTRING ONLY.
- CONTRACTOR TO CONFIRM LOCATION OF ALL WALL AND/OR CEILING MOUNTED EQUIPMENT WITH TENANT PRIOR TO FRAMING, PROVIDE BLOCKING AS REQUIRED TO SUPPORT ALL TENANT SUPPLIED EQUIPMENT, CONFIRM SPECIFICATIONS OF EQUIPMENT WITH TENANT PRIOR TO LOSING FRAMING.

ALT Alternate Alt. ALT Alternate ALALM Auminium ANDON Anodize Another Another Another Another Another Another Architecture Bond Bond Bond Bond Bond Bond Bond Bond	MIN MISC MM MISC MM MO MTL NIC NO NOM NOM NOM NOM NOM NOT	Minimum Miscoellaneous Millimeter Miscoellaneous Millimeter Moscory Opening Medal Not in contract Number Not in contract Number Openication Not in contract Number Outside Diameter Outside Limiter Plantide Plantide Plantide Plantide Plantide Pressure Treated Plantide Pressure Treated Plantide Pressure Treated Plantide Residence Redigence Re
APPROX Approximate APP A Coass Panel ARCH Architect, Architecture ARCH Architect, Architecture ARCH Architect, Architecture ARCH Architect, Architecture BILM BILM BILM BILM BILM BILM BILM BILM	MM MO MOTE MODE MADE MADE MADE MADE MADE MADE MADE MA	Millimeter Mascony Opening Metal Not in contract Number Not in contract Number Not to scale On Center Outside Diameter Outside Diameter Outside Diameter Outside Diameter Outside Diameter Owner Erunished / Owner Ins Owner Eruni
AP Acoess Panel APC Achoest Panel ARCH Architecture Acoest Panel BD Board BUMB Blummous Blucking Blocking Contractor Furnished / Contractor Instituted Coll Contractor Institu	MTL NIC NO NOM NTS OC OD OH OHD OFOI OFCI OPP OTS PLAM PLBG PNT PT PT PT PT PT PT PT PV C R R R R R R R R R R R R R R R R R R	Metal Not in contract Number Nominal Not to scale Outside Diameter Outside Diameter Outside Diameter Overhead Overhead Overhead Overhead Overhead Overhead Overhead Open To Structure Plastic Laminate Plumbing Paint Pressure Treated Painted Painted Polyvinyl chloride Radius Roof drain Regurised Re
ARCHI Architect. Architecture BD Board BTUM Burminous BLKG Blocking Bottom Of Cable Cabline CG Cabline CG Carriador Furnished / CG Comer Guard CLG Card Jont CLG Calling E Certafion CONT Concrete Masonny Unit CONT Concrete Masonny Unit CONT Concrete Masonny Unit CONT Concrete CONT Concrete CONT Concrete CONT Contrain Wall DEL Double DEL Double DEL Double DEL Double DIameter DA Diameter DA Diameter DA Diameter DA Diameter DA Down DELE ELEV Electic, Electrical ELEV Electic, Electrical ELEV Electic, Electrical ELEV Electic, Electrical ELEV Electic Electrical ELEV Electic Electrical ELEV Electric Electrical	NIC NO NOM NTS OC OD OHD OFOI OFOI OFOI OFOI OTS OTS PLAM PLUE PT PTD PLWD PVC R RD REF REQU REV RM RO RTU	Not in outract Not be control of the
BITUM BUKS BLOKE B	NO NOM NOM NOM NOM NOM NOM NOM NOM NOM N	Number Nominal Not to sciele Not to sciele Outside Diameter Outside Diameter Outside Diameter Outside Diameter Owner Eurnished / Owner Ins Owner Furnished / Owner Ins Opposite Opposite Opposite Opposite Opposite Opposite Opposite Plastic Laminate Plastic Laminate Plastic Laminate Plastic Laminate Plywood Pressure Treated Pressure Plywood Required Reduired
BLKC	OC OD OH OHD OFCI OFCI OFCI OFCI OFCI OFCI OFCI OFCI	Not to scale On Center On Center Opposite Hand Opposite Hand Opposite Hand Owner Ermished / Owner Ins Owner Ermished / Owner Ins Owner Ermished / Opposite O
Bottom Of Cable Cablinet Cable Cable Cable Cable Cable Cable CG Corner Guard Cornel CLG Calling C Cartful Ont CLG Calling C Cartful Cornel CMU Concrete Masonny Unit CONC Cornel Cornel CONC Cornel Cornel	OC OD OH OHD OFOI OFCI OPP OTS PLAM PLBG PNT PT PTD PLWD PVC R RD REF REQU REV RM RO RTU	On Center Outside Diameter Outside Diameter Overhead Owner Eurnished / Owner Ins Owner Furnished / Owner Ins Owner Furnished / Owner Ins Owner Furnished / Opposite O
CFCI Contractor Furnished / Contractor Installed Column Co	OD OH OH OFOI OFOI OFOI OFOI OFOI OFOI OFO	Outside Diameter Opposite Hand Overhead / Owner Ins Overhead / Owner Ins Owner Furnished / Owner Ins Owner Furnished / Owner Ins Owner Furnished / Owner Ins Opposite Plattic Laminate Opposite O
CFCI Contractor Furnished / Contractor Installed Column Co	OH OHD OFOI OFOI OFOI OPP OTS PLAM PLBG PNT PT PTD PLWD PVC RD REF REQD REV RM RO RO RTU	Opposite Hand Overhead Overhead Overhead Overhead Overhead Overhead Overhead Overhead Overhead Opposite Opposite Plastic Laminate Plumbing Paint Plumbing Paint Pressure Treated Painted Painted Painted Painted Painted Painted Radius R
Contractor Installad CG Comer Guard CJ Control Joint CA Calling CAIL CAIL CAIL CAIL CAIL CAIL CAIL CAIL	OHD OFOI OFOI OFOI OPP OTS PLAM PLBG PNT PT PTD PLWD PVC R RD REF REQD REV RM RO RO RTU	Overhead Owner Furnished / Owner Ins Owner Furnished / Owner Ins Owner Furnished Owner Furnished Open To Structure Plastic Laminate Plumbing Paint Pressure Treated Pressure Treated Plywood Plywood Radius Roof drain Rederence, Refrigerator Required Requise Roud from Required Roud for Required Roud for Required Roud for Repuired Roud for Rouding Roud for Dunis Roud from Unit
CG Comer Guard CLG Celling CG Celling CG Celling CG CG CELLING CG C	OPP OTS PLAM PLBG PNT PT PTD PLWD PVC R RD REF REQD REV RM RO RO RO RO RO RO RO RO REV RM RO RO RO RO RO RO RO RO RO RO RO RO RO	Owner Eurnished / Contractor Installed Opposite Opposite Plastic Laminate Plastic Laminate Plumbing Paint Pressure Treated Painted Phywood Polyveny Chloride Radius Roof drain Red Reference, Refrigerator Required Required Required Rough Opposite R
CLG Celling Central Country Co	OPP OTS PLAM PLBG PNT PT PTD PLWD PVC R RD REF REQD REV RM RO RO RO RO RO RO RO RO REV RM RO RO RO RO RO RO RO RO RO RO RO RO RO	Contractor Installed Opposite
© Centerline CAUL Concrete Masonny Unit COL Column	PLAM PLBG PNT PT PTD PLWD PVC R RD REF REQD REV RM RO RTU	Open To Structure Plastic Laminate Plumbing Paint Pressure Treated Panted Polyvinyl chloride Radius Roof drain Regerence, Refrigerator Required Rough pont Rough open Rough o
ÖMU Concrete Masonny Unit COL Column CONC Concrete Control Control Correte Control Control Correte Control Con	PLAM PLBG PNT PT PTD PLWD PVC R RD REF REQD REV RM RO RTU	Plastic Laminate Plumbing Paint Pressure Treated Painted Phywood Phywood Radius Roof drain Reference, Refrigerator Reference, Refrigerator Reference Room Room Rough opening Roof Top Unit
COL. Column CONC Control Contr	PLBG PNT PTD PLWD PVC R RD REF REQD REV RM RO RTU	Plumbling Paint Pressure Treated Painted Plywood Polyviny Indireid Radius Rood drain Reference, Refrigerator Revision Room Rough opening Rood Top Unit
CONT Continuous CPT Carper Car	PLBG PNT PTD PLWD PVC R RD REF REQD REV RM RO RTU	Plumbling Paint Pressure Treated Painted Plywood Polyviny Indireid Radius Rood drain Reference, Refrigerator Revision Room Rough opening Rood Top Unit
CPT Carpet CT Carpet CT Carmin Tile CW Curtain Wall Deuble DP Drinking Fountain DB Darmeter DB Darmet	PNT PT PTD PLWD PVC R RD REF REQD REV RM RO RTU	Paint Pressure Treated Painted Plywood Polyvinyl chloride Radius Roof drain Reference, Refrigerator Required Revision Room Rough opening Roof Top Unit
CT Ceramic Tile CV Curtain Wall DBL Double DF Drinking Fountain DIA Diameter DIM Dimension Dime	PT PTD PLWD PVC R RD REF REQD REV RM RO RTU	Painted Plywood Polyvinyl chloride Radius Roof drain Reference, Refrigerator Required Revision Room Rough opening Roof Top Unit
CW Curlain Wall DBL Deuble DF Drinking Fountain DIA Damester DIA Damester DIA Damester DEUT Deutle DEUT Deutle DEUT Deutle Deverspout Drawling, Drawlings EL Expansion John EL Elevation ELEC Electric, Electrical ELEV Elevator ELEVATOR ELEVATOR ELEVATOR ELEVATOR ELEVATOR ELEVATOR ELEVATOR ELEVATO	PLWD PVC R RD REF REQD REV RM RO RTU	Plywood Polyvinyl chloride Radius Roof drain Reference, Refrigerator Required Revision Room Rough opening Roof Top Unit
DF Drinking Fountain DA Diameter DIM Dimension Down Down Down Down Down Down Down Do	R RD REF REQD REV RM RO RTU	Polyvinyl chloride Radius Roof drain Reference, Refrigerator Required Revision Room Rough opening Roof Top Unit
DF Drinking Fountain DA Diameter DIM Dimension Down Down Down Down Down Down Down Do	RD REF REQD REV RM RO RTU	Radius Roof drain Reference, Refrigerator Required Revision Room Room Roof Top Unit
DA Diemeter DM Dimension Down Down Down Down Down Down Down Do	RD REF REQD REV RM RO RTU	Roof drain Reference, Refrigerator Required Revision Room Rough opening Roof Top Unit
DIM Dimension DN Down DS Downspout DT Detail DYG Drawing, Drawings EL Expansion Joint ELE Electric, Electrical ELECY Elevator Ele	REF REQD REV RM RO RTU	Reference, Refrigerator Required Revision Room Rough opening Roof Top Unit
DS Downspout DTL Detail DWG Drawing, Drawings EJ Expansion Joint EL Elevation ELEC Electric, Electrical ELEV Elevator ESP Expanded Polystyrene ESP Expanded Polystyrene EWG Expanse EWG Expanse EWG Expanse EWF Exposed	REQD REV RM RO RTU	Required Revision Room Rough opening Roof Top Unit
DTL Detail DWG Drawing, Drawings EJ Expansion Joint EL Elevation ELEV Elevation ELEV Elevator EG EN	RM RO RTU	Room Rough opening Roof Top Unit
DWG Drawing, Drawings EJ Expansion Joint EL Elevation ELEC Electric, Electrical ELEV Elevator EPS Expanded Polystyrene EQ Equil EWC Electric Water Cooler EXP Exposed	RO RTU	Rough opening Roof Top Unit
EL Elevation ELEC Electric, Electrical ELEV Elevator EPS Expanded Polystyrene EQ Equal EWC Electric Water Cooler EXP Exposed	RTU	Roof Top Unit
EL Elevation ELEC Electric, Electrical ELEV Elevator EPS Expanded Polystyrene EQ Equal EWC Electric Water Cooler EXP Exposed	RWC	
ELEC Electric, Electrical ELEV Elevator EPS Expanded Polystyrene EQ Equal EWC Electric Water Cooler EXP Exposed		
EPS Expanded Polystyrene EQ Equal EWC Electric Water Cooler EXP Exposed		
EQ Equal EWC Electric Water Cooler EXP Exposed	SAB SCHED	Sound Attenuation Blanket Schedule
EWC Electric Water Cooler EXP Exposed	SFRM	Sprayed Fire-Resistant Mater
EXP Exposed	SIM	Similar
EXI Exterior	SPEC	Specification
	STL	Square foot Steel
FEC Fire Extinguisher Cabinet	STOR	Storage
FHC Fire Hose and Valve Cabinet		Structure, Structural
FD Floor drain FLR Floor	SST	Stainless Steel
FRP Fiberglass Reinforced Plastic	TEMP	Temporary, Temperature
FP Fire Protection	TLT	Toilet
FT Feet FIP Framed-in-Place	TO	Top of
FIP Foamed-In-Place	TOP	Top of Parapet Top of wall
GA Gauge	TYP	Typical
GALV Galvinized GC General contractor		
GERC Glass Fiber Reinforced Concrete	UL	Underwriters Laboratory Unless Otherwise Noted
GFRG Glass Fiber Reinforced Gypsum	JUN	Onless Otherwise Noted
GWB Gypsum Wallboard	VB	Vinyl Base
HC Hollow Core	VCT VERT	Vinyl Composition Tile Vertical
HM Hollow Metal HORIZ Horizontal	VERT	Vertical Verify In Field
HP High Point	vwc	Vinyl Wall covering
HT Height		
HVAC Heating, Ventilation, and Air Conditioning	W/	With
	WC WD	Water Closet Wood
INSUL Insulation	WO	Window Opening
INV Invert INT Interior	WP	Waterproofing
JAN Janitor	XPS	Extruded Polystyrene
LAV Lavatory		

GEND	I	
ROOM TAG: NAME, NUMBER, AREA	Ref 1 1 A101 1 1 1 1 1 1 1 1 1 1 1 1 1 1 1 1 1 1	EXTERIOR ELEVATION TAG: DRAWING NUMBER & SHEET REFERENCE
ROOM TAG: NAME, NUMBER, FINISHES	Ref 1 Ref 2 Per	INTERIOR ELEVATION TAG:
DOOR TAG	1 A101 1	DRAWING NUMBER & SHEET REFERENCE
PARTITION TYPE TAG	1 Ref	
WINDOW TYPE TAG	1 SIM	SECTION TAG REFERENCE
PLUMBING FIXTURE / TOILET ACCESSORY TAG	Alui	
KEYED NOTE (REFER TO ASSOCIATED SHEET NOTES)	Name	ELEVATION LEVEL REFERENCE
FE TAG	•	SPOT ELEVATION REFERENCE
FINISH DIRECTION	Ģ.	CENTERLINE
CEILING TAG		
DETAIL NUMBER & SHEET REFERENCE (SIM: SIMILAR, OPP: OPPOSITE, MIR: MIRRORED)	1/8" = 1'-0"	SHEET DRAWING REFERENCE: NUMBER, NAME, & SCALE

	International Building Code*	2018
Residential Subcode	International Residential Code*	2018
Plumbing Subcode	International Plumbing Code*	2018
Electrical Subcode	National Electrical Code	NFPA 70-2017
Energy Subcode	International Energy Conservation Code*	2018
Mechanical Subcode	International Mechanical Code	2018
Fuel Gas Code	International Fuel Gas Code*	2018
Performance Subcode	International Code Council Performance Code	2018
Wildland-Urban Interface Code	Performance Code International Wildland-Urban	2018
Barrier Free	Interface Code ICC/ANSI	A117.1-2017
Installation of Sprinkler Systems	NFPA 13	2016
Fire Alarm Code	NFPA 72	2016
*Adopted with amendments	•	
BUILDING SUMMARY		
Use Group	R-2	302
Construction Type	V-B	602
Fire Protection System	NFPA 13R	903.3.1.2
Fire Alarm System High-Rise-Building	N N	403
Atrium	N N	403
Allowable Building Height - Feet /	60' / 3 Stories	504.3 & 504.4
Stories Actual Building Height - Feet / Stories	50' / 3 Stories	
Mezzanine	Y / 2nd + 3rd Floors	505
Allowable Building Area Per Floor	7,000 SF	Table 506.2
Maximum Building Area Per Floor	SF	
Occupied Area (Gross Heated) First FI:	970 (482) SF	
Mezzanine excluded Second Floor:	970 (970) SF	
Third Floor:	970 (970) SF	
Total:	2910 (2422) SF	
FIRE REGIOTANCE BAT		
FIRE RESISTANCE RAT	ING	Table 601
REQUIREMENTS Primary Structural Frame	0 HR	
Bearing Walls	UNK	
Exterior	0 HR	
Interior	0 HR	
Non-Bearing Walls & Partitions		Table 602
Exterior X<5	1 HR	
5≤X<10 10≤x<30	0 HR 0 HR	
X≥30	0 HR	
Interior	0 HR	
Floor Construction & Secondary Members	0 HR	
Roof Construction & Secondary Members	0 HR	
Elevator Hoistways & Shafts	NONE PROPOSED	713.4
Elevator Lobbies	NONE PROPOSED	708 / 3006.2
Corridors	0 HR 1 HR (Serving 3 stories or less)	Table 1020.1
Exit Stairs & Ramps, Interior	1 HR Min.	1023 1024
Exit Passageways Fire Wall	HR HR	Table 706.4
Separation of Occupancies	N/A (Single occupancy proposed)	Table 508.4
Dwelling Unit Separations	1 HR (Accessory Occupancies) 1 HR	420.2 / 708
Drowing one copulations		120127 700
INTERIOR WALL & CEII	ING FINISH	Table 803.11
REQUIREMENTS		Table 000.11
Exit Stairways, Ramps and Passageways	В	
Passageways Corridors and Enclosures for Exit	C	
Access Stairways, Ramps Rooms and Enclosed Spaces	С	
OCCUPANCY LOAD		Table 1004.1.2
First Floor:	7	Table 1004.1.2
First Floor: Second Floor:	9	Table 1004.1.2
First Floor: Second Floor: Third Floor:	9	Table 1004.1.2
First Floor: Second Floor:	9	Table 1004.1.2
First Floor: Second Floor: Third Floor: Total: Required Egress Width	9	1004.1.2
First Floor: Second Floor: Third Floor: Total: Required Egress Width Stair: 0.2" / 0.3" / Occ	9	1004.1.2
First Floor: Second Floor: Third Floor: Total: Required Egress Width	9	1004.1.2
First Floor: Second Floor: Third Floor: Total: Required Egress Width Stair: 0.2" / 0.3" / Occ Other: 0.15 / 0.2" / Occ	9 9 25	1004.1.2 1005.3
First Floor: Second Floor: Total: Required Egress Width Stair 0.2" 10.3" / Occ Other 0.15 0.2" / Occ Provided Egress Width	9 9 25 25	1004.1.2
First Floor: Second Floor: Third Floor: Third Floor: Total: Required Egress Width Stair: 0.2" / 0.3" / 0.c Other: 0.15 / 0.2" / 0.ce Provided Egress Width Minimum Number of Exits Required Number of Exits Provided Exits Provided Exits Provided	9 9 25 25 36" MIN. 1 1 250" (with sprinkler system)	1004.1.2 1005.3 Table 1006.3.1 Table 1017.2
First Floor: Second Floor: Third Floor: Total: Required Egress Width Stair 9.2" / 0.3" / 0.cc Other. 0.15 / 0.2" / 0.cc Other. 0.15 / 0.2" / 0.cc Provided Egress Width Minimum Number of Exits Required Number of Exits Provided Exit Access Travel Distance Area of Reluga Required	9 9 25 25 36" MIN. 1 1 1 250" (with sprinkler system) N	1004.1.2 1005.3 Table 1006.3.1 Table 1017.2
First Floor: Second Floor: Third Floor: Total: Required Egress Width Stair: 0.2" / 0.3" / 0.cc Other: 0.151 0.2" / 0.cc Provided Egress Width Minimum Number of Exits Required Number of Exits Provided Exit Access Travel Distance Area of Refuge Required Common Path of Egress Travel	9 9 25 25 25 36" MIN. 1 1 250" (with sprinkler system) N 125" (with sprinkler system)	1004.1.2 1005.3 Table 1006.3.1 Table 1017.2
First Floor: Second Floor: Third Floor: Total: Required Egress Width Stair 9.2" / 0.3" / 0.cc Other. 0.15 / 0.2" / 0.cc Other. 0.15 / 0.2" / 0.cc Provided Egress Width Minimum Number of Exits Required Number of Exits Provided Exit Access Travel Distance Area of Reluga Required	9 9 25 25 25 36" MIN. 1 1 250" (with sprinkler system) N 125" (with sprinkler system)	1004.1.2 1005.3 Table 1006.3.1 Table 1017.2
First Floor: Second Floor: Third Floor: Total: Required Egress Width Stair: 0.2" / 0.3" / 0.cc Other: 0.151 0.2" / 0.cc Provided Egress Width Minimum Number of Exits Required Number of Exits Provided Exit Access Travel Distance Area of Refuge Required Common Path of Egress Travel	9 9 25 25 25 36" MIN. 1 1 250" (with sprinkler system) N 125" (with sprinkler system)	1004.1.2 1005.3 Table 1006.3.1 Table 1017.2
First Floor: Second Floor: Third Floor: Total: Required Egress Width Stair: 0.2" / 0.3" / 0.cc Other: 0.151 0.2" / 0.cc Provided Egress Width Minimum Number of Exits Required Number of Exits Provided Exit Access Travel Distance Area of Refuge Required Common Path of Egress Travel	9 9 25 25 25 36" MIN. 1 1 250" (with sprinkler system) N 125" (with sprinkler system)	1004.1.2 1005.3 Table 1006.3.1 Table 1017.2
First Floor: Second Floor: Third Floor: Total: Required Egress Width Stair: 0.2" 10.3" / Occ Other: 0.151 0.2" / Occ Provided Egress Width Minimum Number of Exits Required Number of Exits Provided Exit Access Travel Distance Area of Refuge Required Common Path of Egress Travel	9 9 25 25 25 36" MIN. 1 1 250" (with sprinkler system) N 125" (with sprinkler system)	1004.1.2 1005.3 Table 1006.3.1 Table 1017.2
First Floor: Second Floor: Third Floor: Total: Required Egress Width Stair: 0.2" 10.3" / Occ Other: 0.151 0.2" / Occ Provided Egress Width Minimum Number of Exits Required Number of Exits Provided Exit Access Travel Distance Area of Refuge Required Common Path of Egress Travel	9 9 25 25 25 36" MIN. 1 1 250" (with sprinkler system) N 125" (with sprinkler system)	1004.1.2 1005.3 Table 1006.3.1 Table 1017.2
First Floor: Second Floor: Third Floor: Total: Required Egress Width Stair: 0.2" 10.3" / Occ Other: 0.151 0.2" / Occ Provided Egress Width Minimum Number of Exits Required Number of Exits Provided Exit Access Travel Distance Area of Refuge Required Common Path of Egress Travel	9 9 25 25 25 36" MIN. 1 1 250" (with sprinkler system) N 125" (with sprinkler system)	1004.1.2 1005.3 Table 1006.3.1 Table 1017.2
First Floor: Second Floor: Third Floor: Total: Required Egress Width Stair: 0.2" 10.3" / Occ Other: 0.151 0.2" / Occ Provided Egress Width Minimum Number of Exits Required Number of Exits Provided Exit Access Travel Distance Area of Refuge Required Common Path of Egress Travel	9 9 25 25 25 36" MIN. 1 1 250" (with sprinkler system) N 125" (with sprinkler system)	1004.1.2 1005.3 Table 1006.3.1 Table 1017.2
First Floor: Second Floor: Third Floor: Total: Required Egress Width Stair: 0.2" 10.3" / Occ Other: 0.151 0.2" / Occ Provided Egress Width Minimum Number of Exits Required Number of Exits Provided Exit Access Travel Distance Area of Refuge Required Common Path of Egress Travel	9 9 25 25 25 36" MIN. 1 1 250" (with sprinkler system) N 125" (with sprinkler system)	1004.1.2 1005.3 Table 1006.3.1 Table 1017.2
First Floor: Second Floor: Third Floor: Total: Required Egress Width Stair: 0.2" 10.3" / Occ Other: 0.151 0.2" / Occ Provided Egress Width Minimum Number of Exits Required Number of Exits Provided Exit Access Travel Distance Area of Refuge Required Common Path of Egress Travel	9 9 25 25 25 36" MIN. 1 1 250" (with sprinkler system) N 125" (with sprinkler system)	1004.1.2 1005.3 Table 1006.3.1 Table 1017.2

g Spaces Total Parking Spaces Provided

Total Number of Units

SOUND TRANSMISSION

Total Number of Units
Provided
Min. Units W/O Roll In
Showers
Min. Units W/Roll In Showers
Min. Units W/ Roll In Showers
Total Required Accessible
Units
None

Seating Capacity in Assem.
Areas

Required Wheelchair Spaces

None

1107.6.1

Tabl 1108.2.2.

elling and Sleeping Uni

APPLICABLE CODES

			Air-Borne Sound	STC 50 Min.	
_	International Building Code*	2018	Structure-Borne Sound	IIC 50 Min.	
	International Fire Code*	2018			
_	International Residential Code*	2018	SPECIAL INSPECTION		1705
	International Plumbing Code*	2018	Type	Required	
	National Electrical Code	NFPA	Steel Construction		1705.
_	International Energy	70-2017	Structural Steel	Yes	
	Conservation Code*	2018	Cold-Formed Steel Deck Open-Web Steel Joists & Joist		
	International Mechanical Code	2018	Open-Web Steel Joists & Joist Girders		
	International Fuel Gas Code*	2018	Cold-Formed Steel Trusses		
			Concrete Construction	Yes	1705.
	International Code Council	2018	Welding of Reinforcing Bars		
	Performance Code International Wildland-Urban	2018	Masonry Construction		1705.
	International Wildland-Urban Interface Code	2018	Wood Construction	Yes	1705.
	ICC/ANSI	A117.1-2017	Soils	Yes	1705.
			Driven Deep Foundations		1705.
	NFPA 13	2016	Cast-In-Place Deep Foundations		1705.
	NFPA 72	2016	Helical Pile Foundations		1705.
			Fabricated Items		1705.1
_			Wind Resistance		1705.1
			Seismic Resistance		1705.1
			Sprayed Fire-Resistant Materials		1705.1
			Mastic & Intumescent Fire-Resistant Coatings		1705.1
			Exterior Insulation & Finish Systems		1705.1
			Water-Resistive Barrier Coating		
	R-2	302	Fire-Resistant Penetrations & Joints		1705.1
-	V-B	602	Smoke Control		1705.1
	NFPA 13R	903.3.1.2		•	•
-	N N	000101112	PORTABLE FIRE EXTI	NGUISHERS	
	N N	403	Ref — International Building	TOOIGITEIRO	Section 90
-	N N	404	Code		
			Ref - International Fire Code		Table 901.6.
	60' / 3 Stories	504.3 & 504.4	Ref - NFPA 10		Table 5.2.
		304.3 & 304.4	CLASS A LIGHT (LOW) HAZARD OCC	UPANCY	
	50' / 3 Stories		Minimum Rated Single Extinguisher		2-
_	Y / 2nd + 3rd Floors	505	Maximum Floor Area Per Unit of A		3,000 S
			Maximum Floor Area for Extinguisher		11,250 S
	7,000 SF	Table 506.2	Maximum Travel Distance to Extinguisher		75 Fee
	SF				
_		$\overline{}$	PA One Call: 811		
1:	970 (482) SF				
e:	970 (970) SF				
e:	970 (970) SF				
al:	2910 (2422) SF	1 1			

	SHEET LIST		
SHEET NO.	SHEET NAME	2023.06.12 - Rev1	2023.07.21- Rev2
01-General			
G0.00	SHEET LIST, GENERAL NOTES, PROJECT SUMMARY, CODE SUMMARY	х	х
G1.01	LIFE SAFETY + ENERGY CODE + SITE	×	×
07-Architect			
A1.01	1ST FLOOR PLAN	×	х
A1.02	2ND FLOOR PLANS	×	×
A1.03	3RD FLOOR PLANS	×	×
A1.04	ROOF PLAN	×	х
A1.41	1ST FLOOR INTERIOR FINISH PLAN	×	×
A1.42	2ND FLOOR INTERIOR FINISH PLAN	×	×
A1.43	3RD FLOOR INTERIOR FINISH PLAN	×	х
A2.01	1ST FLOOR RCP	×	×
A2.02	2ND FLOOR RCPs	×	×
A2.03	3RD FLOOR RCPs	×	х
A3.10	BUILDING ELEVATIONS	×	×
A4.10	BUILDING SECTIONS	×	×
A4.11	BUILDING SECTIONS	×	х
A5.01	ASSEMBLIES AND PARTITIONS	×	×
A5.10	WALL SECTIONS FRONT	×	×
A5.11	WALL SECTIONS REAR	×	х
A6.10	INTERIOR ELEVATIONS A+B	×	х
A6.11	INTERIOR ELEVATIONS C+D	×	х
A7.10	STAIR DETAILS	×	×
A8.10	PARTITION, FIRE RATED ASSEMBLY, & PENETRATION DETAILS	×	×
A9.10	DOORS	×	х
A9.20	WINDOWS	X	×
A9.30	SCHEDULES	×	×



phone: 215.829.0922 x154 CONTACT PERSON: Chris Stigler

OWNER

STRUCTURAL phone: 484.475.2180
CONTACT PERSON: Steve Krumenacker

CIVII Stantec phone: 215.665.7000 CONTACT PERSON: Greg Gress

2033 Chestnut Street Multifamily Building

Project Address: 2033 Chestnut St Philadelphia, PA 19103

SHEET LIST, GENERAL NOTES, PROJECT SUMMARY, CODE SUMMARY




DUTY TO INSPECT CONTRACT DOCUMENTS PRIOR TO STARTING WORK:

Any party who relies in part or whole on the content of these Construction Documents shall, before beginning the complete to the party of th

17010000		
Date	Comments	Δ

Job Number:	22-127
le:	As indicated
wn By:	JU
cked By:	CS
roved By:	JH

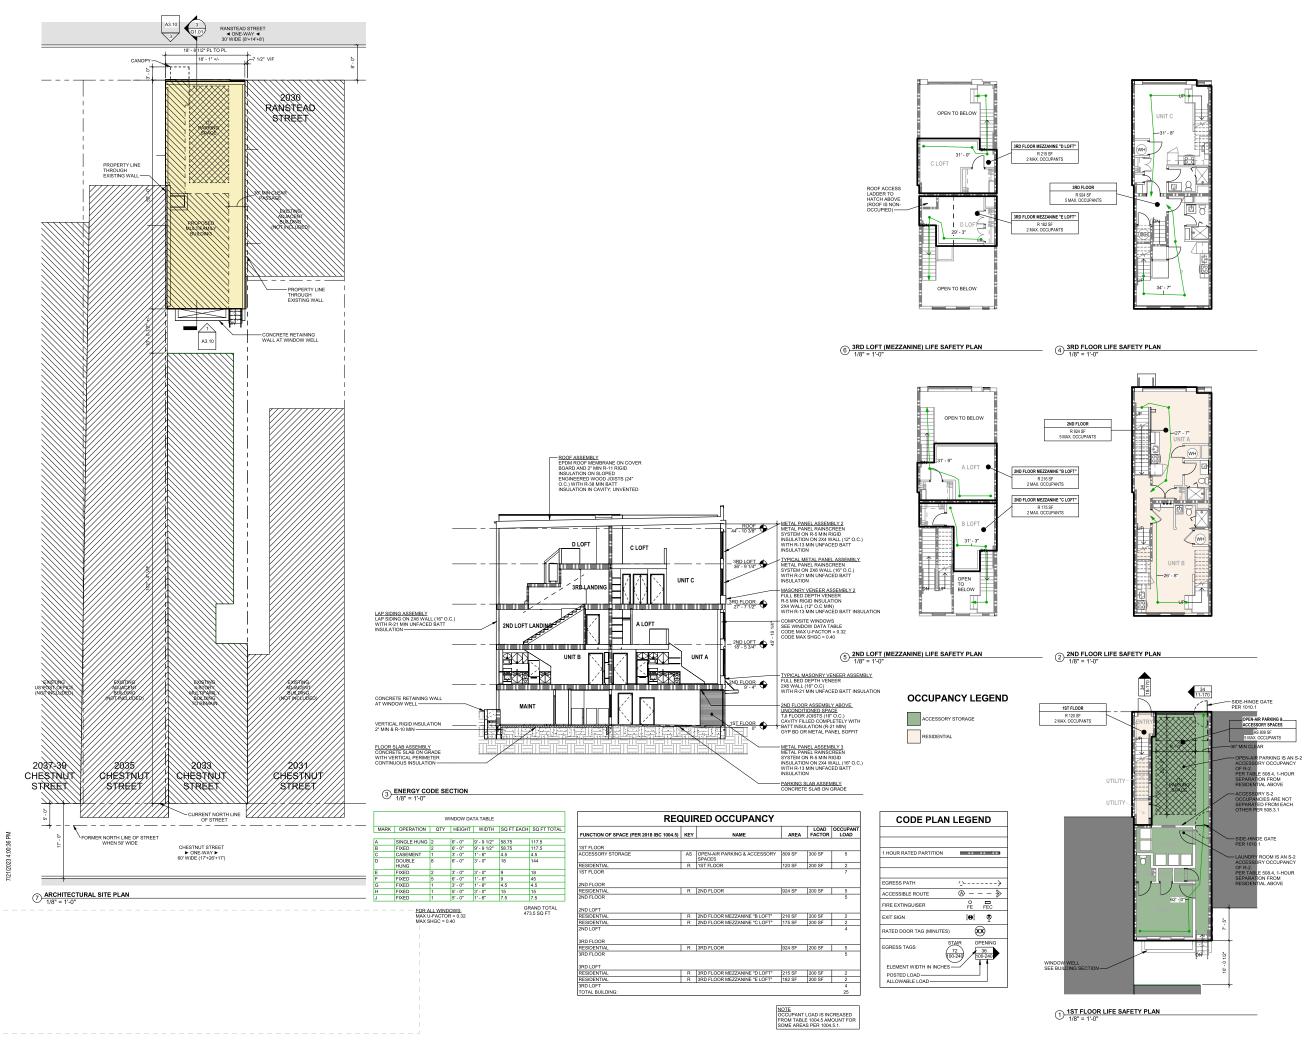



phone: 215.829.0922 x154 CONTACT PERSON: Chris Stigler

OWNER

STRUCTURAL DCI+Macintosh Engineers phone: 484.475.2180 CONTACT PERSON: Steve Krumenacker

CIVIL Stantec phone: 215.665.7000 CONTACT PERSON: Greg Gress

2033 Chestnut Street Multifamily Building

Project Address: 2033 Chestnut St Philadelphia, PA 19103

LIFE SAFETY + ENERGY CODE + SITE





Comments	
	+-
	_
	+
	-
	+
	+
	Comments

As indicated Drawn By: CS Checked By:





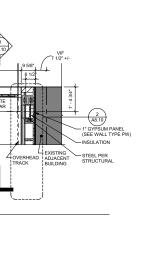

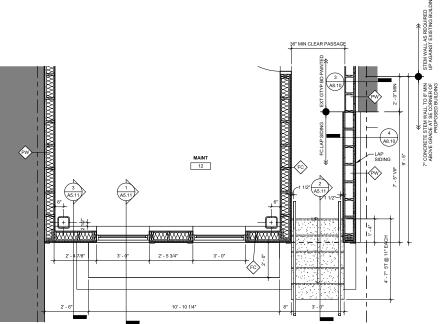

H 7 13

FLOOR PLAN GENERAL NOTES

- NEW CONSTRUCTION SHOWN ALIGNED WITH EXISTING CONSTRUCTION SHALL BE INSTALLED FLUSH AND SMOOTH

- 15. ALL EXPOSED STEEL SURFACES TO BE PAINTED, U.O.N.
- UNLESS OTHERWISE NOTED, ALL FIRE EXTINGUISHERS TO BE CENTERED ON WALL LENGTH OR 16" FROM NEAREST ADJACENT CORNER OR DOOR AS SHOWN, PROVIDE FIRE EXTRAGUISHERS IN QUANTITY REQUIRED BY CODE. PROVIDE APARTMENT UNITS WITH FIRE EXTINGUISHER (S) ON EACH LEVEL.

FLOOR PLAN KEYED NOTES

BLACKNEY HAYES ARCHITECTS

phone: 215.829.0922 x154 CONTACT PERSON: Chris Stigler

OWNER

STRUCTURAL DCI+Macintosh Engineers phone: 484.475.2180 CONTACT PERSON: Steve Krumenacker

Stantec phone: 215.665.7000 CONTACT PERSON: Greg Gress

2033 Chestnut Street Multifamily Building

Project Address: 2033 Chestnut St Philadelphia, PA 19103

1ST FLOOR PLAN



Release		
Date	Comments	Δ
		_
		_
		_


BHA Job Number:	22-127
Scale:	As indicated
Drawn By:	JU
Checked By:	CS
Approved By:	JH

BV

2 1ST FLOOR FRONT WALL PLAN 1/2" = 1'-0"

3 1ST FLOOR REAR WALL PLAN 1/2" = 1'-0"

15T FLOOR PLAN
1/4" = 1'-0"

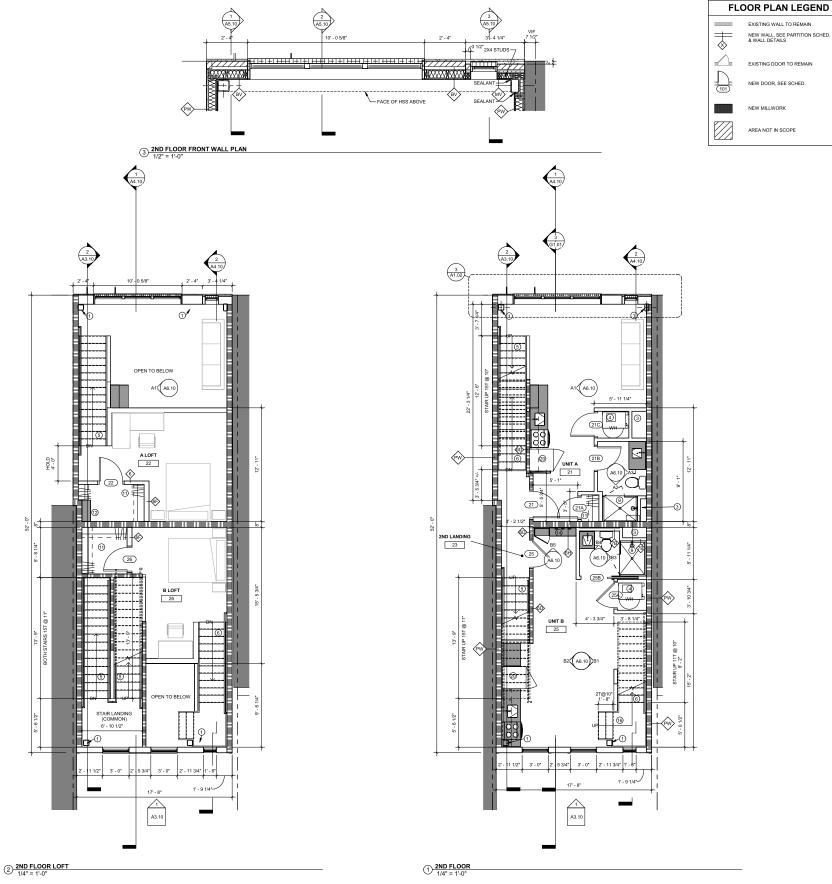

EXISTING WALL TO REMAIN NEW WALL, SEE PARTITION SCHED. & WALL DETAILS

EXISTING DOOR TO REMAIN

AREA NOT IN SCOPE

FLOOR PLAN GENERAL NOTES

- NOTIFY ARCHITECT IN WRITING OF ANY DISCREPANCIES OR CONFLICTS IN THE LOCATION(S) OF NEW CONSTRUCTION. UPON COMPLETION OF PARTITION LAYOUT, NOTIFY THE ARCHITECT FOR VERIFICATION OF THE LAYOUT PRIOR TO PARTITION INSTALLATION.
- ALL WORK WILL CONFORM TO ALL APPLICABLE BUILDING REGULATIONS (STATE AND LOCAL), IT IS THE CONTRACTOR'S RESPONSIBILITY TO HAVE. THOROUGH WORKING KNOWLEDGE OF ALL CODE ISSUES.
- THE SUBMISSION OF PRICING BY THE CONTRACTOR SHALL BE EVIDENCE THAT THE CONTRACTOR HAS FULLY EVALUATED POTENTIAL PROBLEMS

- NEW CONSTRUCTION SHOWN ALIGNED WITH EXISTING CONSTRUCTION SHALL BE INSTALLED FLUSH AND SMOOTH

FLOOR PLAN KEYED NOTES

STEEL FRAME FOR WALL BRACING. SEE STRUCTURAL CLUSTER ELECTRICAL METERS IN THIS NICHE WITH DECO APPROVAL OR PROVIDE MALIBOXES (USPS APPROVED)
PLUMBING CHASE
CLOSET FOR WATER FEATER AND HAZE UNIT
DECOMPOSED SECTIONS FOR EXPENTS OF PARTING.
BOX WOOD STAIR UNINATED BELOW. SEE SECTIONS.
DRYER STACKED ABOVE WASHER.
PROVIDE HOOKUPS FOR FUTURE WASHER & DRYER SHOWLER.
SHOWLER - 450A NOMINAL.
PROVIDE CARD READER AT THIS DOOR. COORDINATE
WITH ALL TRACES. OWNER TO SELECT SYSTEM.
SHELVING OWNER FREE-SLIDE COATED WIRE
SHELVING OWNER.

CLOSET - PROVIDE FREE-SLIDE COATED WIRE SHELVING BUILTIN SHE BUILT SHE BUILTIN SHE BUILT S

- ALL EXPOSED STEEL SURFACES TO BE PAINTED, U.O.N.
- UNLESS OTHERWISE NOTED, ALL FIRE EXTINGUISHERS TO BE CENTERED ON WALL LENGTH OR 16" FROM NEAREST ADJACENT CORNER OR DOOR AS SHOWN, PROVIDE FIRE EXTRAGUISHERS IN QUANTITY REQUIRED BY CODE. PROVIDE APARTMENT UNITS WITH FIRE EXTINGUISHER (S) ON EACH LEVEL.

BLACKNEY HAYES ARCHITECTS

phone: 215.829.0922 x154 CONTACT PERSON: Chris Stigler

OWNER

STRUCTURAL DCI+Macintosh Engineers phone: 484.475.2180 CONTACT PERSON: Steve Krumenacker

Stantec phone: 215.665.7000 CONTACT PERSON: Greg Gress

2033 Chestnut Street Multifamily Building


Project Address: 2033 Chestnut St Philadelphia, PA 19103


2ND FLOOR PLANS



Release		
Date	Comments	Δ
		_
		_
		_
		_
	•	

BHA Job Number:	22-127
Scale:	As indicated
Drawn By:	JU
Checked By:	CS
Approved By:	JH

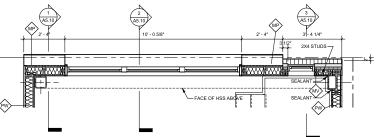

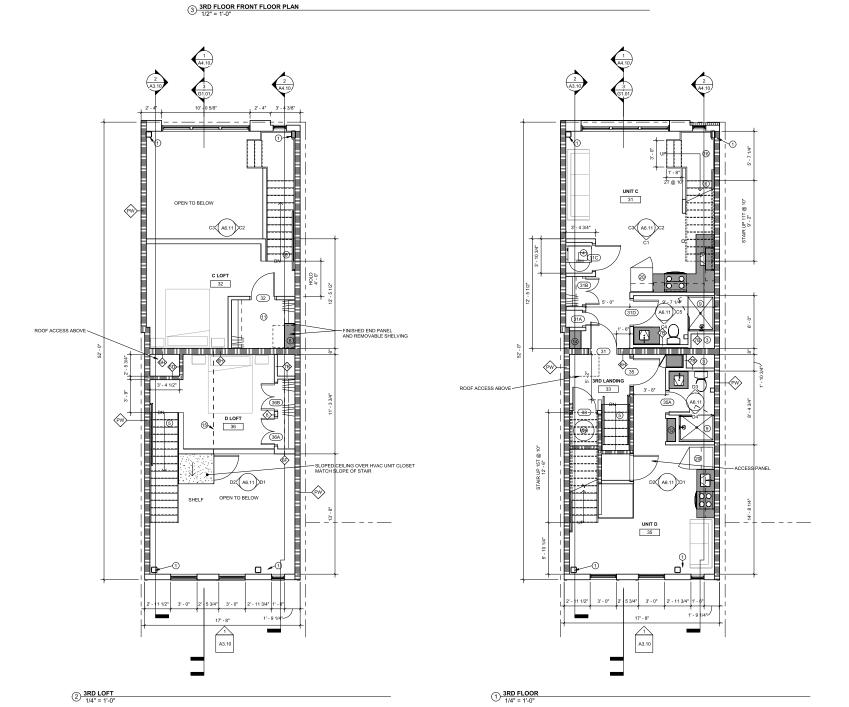

FLOOR PLAN GENERAL NOTES

FLOOR PLAN LEGEND


EXISTING WALL TO REMAIN NEW WALL, SEE PARTITION SCHED. & WALL DETAILS

EXISTING DOOR TO REMAIN

AREA NOT IN SCOPE

 \Rightarrow

101

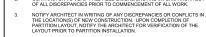

ALL WORK WILL CONFORM TO ALL APPLICABLE BUILDING REGULATIONS (STATE AND LOCAL), IT IS THE CONTRACTOR'S RESPONSIBILITY TO HAVE. THOROUGH WORKING KNOWLEDGE OF ALL CODE ISSUES.

THE SUBMISSION OF PRICING BY THE CONTRACTOR SHALL BE EVIDENCE THAT THE CONTRACTOR HAS FULLY EVALUATED POTENTIAL PROBLEMS

NEW CONSTRUCTION SHOWN ALIGNED WITH EXISTING CONSTRUCTION SHALL BE INSTALLED FLUSH AND SMOOTH

15. ALL EXPOSED STEEL SURFACES TO BE PAINTED, U.O.N.

UNLESS OTHERWISE NOTED, ALL FIRE EXTINGUISHERS TO BE CENTERED ON WALL LENGTH OR 18" FROM NEAREST ADJACENT CORNER OR DOOR A SHOWN, PROVIDE FIRE EXTINGUISHERS IN QUANTITY REQUIRED BY CODE PROVIDE APARTMENT UNITS WITH FIRE EXTINGUISHER(S) ON EACH LEVEL

FLOOR PLAN KEYED NOTES

STEEL FRAME FOR WALL BRACING. SEE STRUCTURAL CLUSTER ELECTRICAL METERS IN THIS NICHE WITH DECO APPROVAL OR PROVIDE MALIBOXES (USPS APPROVED)
PLUMBING CHASE
CLOSET FOR WATER FEATER AND HAZE UNIT
PLUMBING CHASE
CLOSET FOR WATER FEATER AND HAZE UNIT
BOX WAS DESTROYED FOR EXPENTED FOR PATING
BOX WOOD STAIR UNINATED BELOW. SEE SECTIONS.
DRYER STACKED ABOVE WASHER.
PROVIDE HOOKUPS FOR FUTURE WASHER & DRYER
SHOWER - 456A DOMINAL
PROVIDE CARD READER AT THIS DOOR. COORDINATE
WITH ALL TRACES. OWNER TO SELECT SYSTEM
WITH ALL TRACES. OWNER TO SELECT SYSTEM
SHELVING OWNER FREE-SLIDE COATED WIRE
SHELVING WASHER.

BLACKNEY HAYES ARCHITECTS

phone: 215.829.0922 x154 CONTACT PERSON: Chris Stigler

OWNER

STRUCTURAL DCI+Macintosh Engineers phone: 484.475.2180 CONTACT PERSON: Steve Krumenacker

Stantec phone: 215.665.7000 CONTACT PERSON: Greg Gress

2033 Chestnut Street Multifamily Building

Project Address: 2033 Chestnut St Philadelphia, PA 19103


3RD FLOOR PLANS





Release		
Date	Comments	Δ
		-
		_
		-

BHA Job Number:	22-127
Scale:	As indicated
Drawn By:	JU
Checked By:	CS
Approved By:	JH

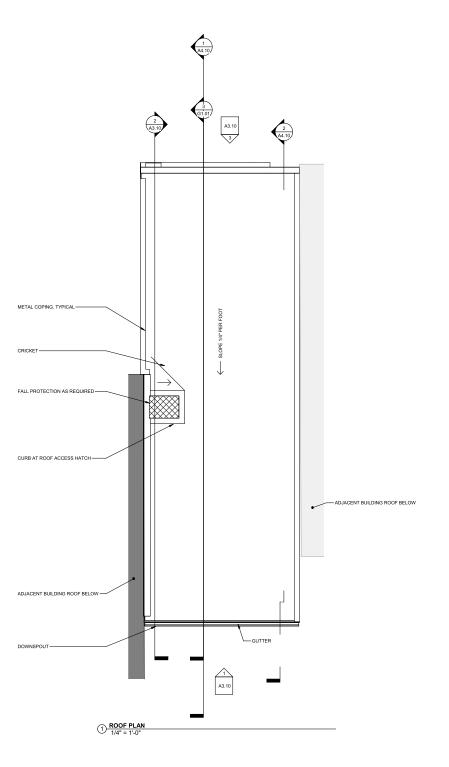

ROOF PLAN GENERAL NOTES

- 10. [NOT USED / RESERVED]
- NEW CONSTRUCTION SHOWN ALIGNED WITH EXISTING SHALL BE INSTALLED FLUSH AND SMOOTH



phone: 215.829.0922 x154 CONTACT PERSON: Chris Stigler

OWNER Thom Tahopoulos phone: 610.909.0204

STRUCTURAL DCI+Macintosh Engineers phone: 484,475.2180 CONTACT PERSON: Steve Krumenacker

CIVIL Stantec phone: 215.665.7000 CONTACT PERSON: Greg Gress

2033 Chestnut Street Multifamily Building


Project Address: 2033 Chestnut St Philadelphia, PA 19103

ROOF PLAN



Release		
Date	Comments	Δ
		_
		_
		_
		-

BHA Job Number:	22-127
Scale:	As indicated
Drawn By:	JU
Checked By:	CS
Approved By:	JH

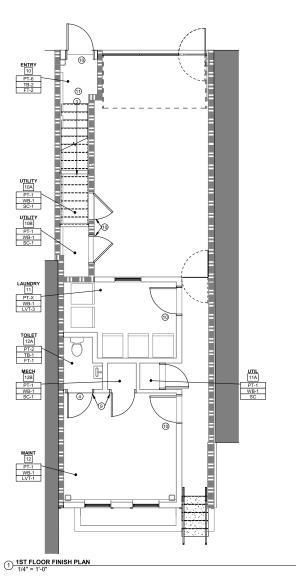

FINISH PLAN KEYED NOTES

- ② PROVIDE SHOWER PAN (TZ-1)
- PROVIDE LVT TREADS (LVT-2) AND FLOORING.
 PROVIDE AVA FLOORING-FLUSH STAIR NOSING
 298 IN COLOR AND PATTERN TO MATCH
- PROVIDE FLOOR TRANSITION BETWEEN
 PROCELAIN TILE AND LVT SEE DETAIL (2/A9.10) PROVIDE FLOOR TRANSITION BETWEEN LYT IN CORRIDOR AND UNIT
- PROVIDE NEW BACKSPLASH TILE ABOVE THE COUNTER (WT-2)
- 7 PROVIDE TRANSITION BETWEEN PORCELAIN TILE AND CONCRETE (3/A9.10)
- PROVIDE FLOOR TRANSITION BETWEEN LVT AND CONCRETE (3/A9.10)
- 9 INTERIOR DOORS AND TRIM TO BE PAINTED (PT-9) IN UNITS
- (D) EXTERIOR DOORS AND TRIM TO BE PAINTED (PT-4) IN HALLS
- 1 HAND RAILS TO BE PAINTED (PT-4

FINISH PLAN GENERAL NOTES

- ALL MATERIALS TO BE INSTALLED ACCORDING TO MANUFACTURER'S RECOMMENDED INSTRUCTIONS.
- CONTRACTOR SHALL SUBMIT SAMPLES OF ALL FINISH MATERIALS TO OWNER FOR APPROVAL BEFORE ORDERING OR INSTALLING ANY FINISH MATERIAL NICLUMB SUT NOT LIMITED TO: CARPET, PAINT, WALL COVERINGS, FLOORING MATERIALS, AND ANY OTHER FINISH PRODUCT WHICH COMES IN A VARIETY OF FINISHES, TYPES AND COLORS, THE FINISH SCHEDULE IS A GUIDE ONLY. FINISH APPROVIALS MUST BE OBTAINED FROM TENANT A ARCHITECT IN WITHING BEFORE PROCEDORS WITH HOWER
- CONTRACTOR TO PROTECT EXISTING AREAS DURING CONSTRUCTION AND CLEAN AS REQUIRED AT COMPLETION OF CONSTRUCTION.
- ALL WALL, COLUMNS, SURFACES AND PERIPHERAL WINDOW DETAILS TO BE PROPERLY SPACKLED AND SANDED SMOOTH WITH NO VISSILE JOINTS TO PROVIDE A FERFECTLY SMOOTH SURFACE TO RECEIVE ONE PRIME ROAT AND TWO FINISH COATS OF PAINT. EMSTING WALLS PREPARED AS REQUIRED TO LIKE-AWEY COMDITION TO ACCEPT New FINISH PRODUCT.
- REFER TO FINISH LEGEND FOR PAINT FINISH SPECIFICATION FOR WALLS. TRIM AND FRAMES TO BE SEMI-GLOSS LATEX.
- ALL FLOOR FINISHES TO EXTEND UNDER CASEWORK AND KNEE SPACE AND ADA SINK CABINET.
- ALL PARTITIONS TO BE PAINTED PT-1 UNLESS OTHERWISE NOTED.
- FLOORING TO EXTEND IN TO ALL COAT CLOSETS AND SUPPLY CLOSETS UNLESS OTHERWISE NOTED.
- FLOOR MATERIAL CHANGES SHALL OCCUR AT THE CENTER LINE OF THE DOORS EXCEPT WHERE NOTED OTHERWISE. COORDINATE FLOORING SEAM LOCATIONS WITH SWING AND LOCATION OF DOORS.
- CONTRACTOR SHALL, UPON COMPLETION, REMOVE ALL PAINT FROM WHERE IT SPILLED, SPLASHED, OR SPATTERED ON ALL SURFACES.
- THE CONTRACTOR SHALL EXAMINE ALL AREAS OF CONSTRUCTION AFTER COMPLETION OF WORK BY ALL TRADES (INCLUDING CABLING, TELEPHONE AND FLOORING INSTALLATION, ETC). AND APPROVE ALL NECESSARY TOUCH UP PAINTING AND OR PATCHING.
- UPON COMPLETION, ALL WORK SHALL BE CLEANED BY THE CONTRACTOR REMOVING ALL SPOTS OF ADHESIVE AND SURFACE STAINS AND ALL SCRAPS, CARTONS AND CONTAINERS SHALL BE REMOVED FROM BUILDING.
- THE CONTRACTOR SHALL PROVIDE AND MAINTAIN ADEQUATE PROTECTION FOR ALL FLOORING WORK FOR THE DURATION OF THE CONTRACT, AND REMOVE ALL PROTECTION UPON PROJECT COMPLETION.
- REMOVE ALL PROJECTION OF THE TOTAL CAPTURE AND TWO COATS OF SPECIFIED PAINT IN THE TOTAL CAPTURE AND TWO COATS OF SPECIFIED PAINT INTO PRIMER TO APPROXIMANTE SHADE OF FINAL COAT TOUGH PAIL SUCTION SPOTS OF HOT SPOTS AFTER APPULCATION OF FIRST COAT AND BEFORE APPLYING SECOND COAT, TO PROVIDE AN EVEN RESULT IN THE FINHS HOLD THEY APPLYING SUCCESSIVE COATS, FOLLOW MANUFACTURERS RECOMMENDATIONS FOR RECEIPT TIME, PRIMER TO BE LOW VOC PRIMER, NOTE: PAINT TO BE INTERIOR ACRYLIC LATEX THROUGHOUT.
- PROVIDE REDUCER STRIPS AT CHANGE OF FLOOR MATERIALS AS REQUIRED. COLOR TO MATCH VINYL BASE. REDUCER STRIPS TO BE ADA COMPLIANT.
- WHERE ATYPICAL CONDITIONS OCCUR, CONTRACTOR IS TO VERIFY FINISH TREATMENT WITH ARCHITECT BEFORE PROCEEDING.
- PAINT ALL DIFFUSERS, GRILLES, ACCESS PANELS ETC. TO MATCH ADJACENT SURFACES.
- ALL SOFFITS TO BE SAME FINISH AND COLOR AS ADJACENT WALL U.O.N.
- FLOOR COVERING SHALL BE INSTALLED IN ACCORDANCE WITH MANUFACTURING INSTRUCTIONS TO LAY SMOOTH AND EVENLY. WHERE CARPET TILE IS USED. ALL TILE TO BE INSTALLED WITH NO LESS THAN A 12° CUT AT ANY ENDING POINT.
- CONTRACTOR TO CONFIRM QUANTITY OF ATTIC STOCK REQUIRED WITH OWNER.
- INTERIOR FINISHES SHALL HAVE A FLAME SPREAD INDEX NOT GREATER THAN THAT SPECIFIED IN 1BC 2018 ALL WALL & CEILING TO HAVE CLASS C RATING PER TABLE 803.11. FLOORING MATERIAL TO BE NOT LESS THAN CLASS II PER IBC 2018 AND TO COMPLY WITH THE DOC FF-1 "PILL TEST".
- ALL EXISTING A DRYWALL CEILINGS ARE TO BE PAINTED ((PT-3) CONTRACTOR TO CONFIRM ACCENT PAINT WALL LOCATIONS WITH TENANT PRIOR TO INSTALLATION. ALL EXISTING AND NEW TRIM TO BE PAINTED.
- PAINT ALL TRIN AND DOORS IN UMITS (PT-4) U.O.N.
- PAINT ALL TRIM AND DOORS IN COMMON SPACES (PT-7) UON



phone: 215.829.0922 x154 CONTACT PERSON: Chris Stigler

OWNER

STRUCTURAL DCI+Macintosh Engineers phone: 484.475.2180 CONTACT PERSON: Steve Krumenacker

CIVIL

Stantec phone: 215.665.7000 CONTACT PERSON: Greg Gress

2033 Chestnut Street Multifamily Building

Project Address: 2033 Chestnut St Philadelphia, PA 19103

1ST FLOOR INTERIOR

FINISH PLAN



DUTY TO INSPECT CONTRACT DOCUMENTS PRIOR TO STARTING WORK:

Any party who relies in part or whole on the content of these Construction Documents shall, before beginning the complete.


Date	Comments	
Date	Comments	4
		_
		_
		-
		_

As indicated Drawn By: EM Checked By: CS

B LOFT 26 PT-1 WB-1 LVT-1

FINISH PLAN KEYED NOTES

- PROVIDE FLOOR TO CEILING WALL TILE
 (WT-1) PROVIDE SCHLUTER STRIP FINISHE
 EDGE AT OUTSIDE CORNERS.
- PROVIDE SHOWER PAN (TZ-1)
- PROVIDE LYT TREADS (LVT-2) AND FLOORING.
 PROVIDE AVA FLOORING-FLUSH STAIR NOSING
 298 IN COLOR AND PATTERN TO MATCH
- PROVIDE FLOOR TRANSITION BETWEEN
 PROCELAIN TILE AND LVT SEE DETAIL (2/A9.10)
- PROVIDE FLOOR TRANSITION BETWEEN LVT IN CORRIDOR AND UNIT
- PROVIDE NEW BACKSPLASH TILE ABOVE THE COUNTER (WT-2)
- PROVIDE TRANSITION BETWEEN PORCELAIN TILE AND CONCRETE (3/A9.10)
- PROVIDE FLOOR TRANSITION BETWEEN LVT AND CONCRETE (3/A9.10)
- INTERIOR DOORS AND TRIM TO BE PAINTED (PT-9) IN UNITS
- EXTERIOR DOORS AND TRIM TO BE PAINTED
 (PT-4) IN HALLS
- 1 HAND RAILS TO BE PAINTED (PT-4)

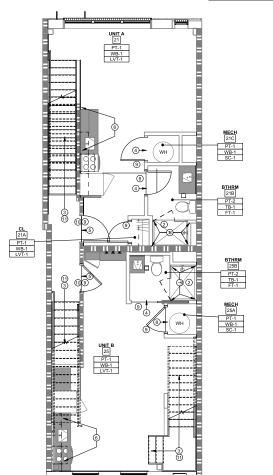

FINISH PLAN GENERAL NOTES

- ALL MATERIALS TO BE INSTALLED ACCORDING TO MANUFACTURER'S RECOMMENDED INSTRUCTIONS.
- CONTRACTOR SHALL SUBMIT SAMPLES OF ALL FINISH MATERIALS TO OWNER FOR APPROVAL BEFORE ORDERING OR INSTALLING ANY FINISH MATERIAL NICLUDING BUT NOT LIMITED TO CARPET PAINT, WALL COVERINGS, FLOORING MATERIALS, AND ANY OTHER FINISH PRODUCT WHICH COMES IN A VARIETY OF FINISHES, TYPES AND COLORS. THE FINISH SCHEDULE IS A GUIDE ONLY, FINISH APPROVIALS MUST BE OBTANED FROM TENANT & ARCHITECT IN WITHIN DEFORM TENANT & ARCHITECT IN WITHIN DEFORM TENANT & ARCHITECT IN WITHIN DEFORM TENANT ARCHITECT IN WITHIN OR.
- ALL WALL, COLUMNS, SURFACES AND PERIPHERAL WINDOW DETAILS TO BE PROPERLY SPACKLED AND SANDED SMOOTH WITH NO VISIBLE JOINTS PROVIDE A PERFECTLY SMOOTH SURFACE TO RECEIVE ONE PRIMER COAT AND TWO FINISH COATS OF PAINT: EMSTING WALLS PREPARED AS REQUIRED TO LIKE-PLEY CONDITION TO ACCEPT NeW FINISH PRODUCT.

- CARPET SUBCONTRACTOR TO CHECK ALL DIMENSIONS IN THE FIELD TO VERIFY ACCURACY OF QUANTITIES IN QUOTATIONS. ALL FLOOR PATTERNS TO BE CENTERED IN CORRIDORS AND ROOMS, UNLESS OTHERWISE NOTED ALL FLOOR FINISHES TO EXTEND UNDER CASEWORK AND KNEE SPACE AND ADA SINK CABINET.
- FLOORING TO EXTEND IN TO ALL COAT CLOSETS AND SUPPLY CLOSETS UNLESS OTHERWISE NOTED.
- CONTRACTOR SHALL, UPON COMPLETION, REMOVE ALL PAINT FROM WHERE IT SPILLED, SPLASHED, OR SPATTERED ON ALL SURFACES.

- PROVIDE REDUCER STRIPS AT CHANGE OF FLOOR MATERIALS AS REQUIRED. COLOR TO MATCH VINYL BASE. REDUCER STRIPS TO BE ADA COMPLIANT.
- PAINT ALL DIFFUSERS, GRILLES, ACCESS PANELS ETC. TO MATCH ADJACENT SURFACES.
- SUB-FLOOR IS TO BE PATCHED, REPAIRED AND MADE SMOOTH AND LEVEL TO RECEIVE NEW FLOORING.
- FLOOR COVERING SHALL BE INSTALLED IN ACCORDANCE WITH MANUFACTURING INSTRUCTIONS TO LAY SMOOTH AND EVENLY, WHERE CARPET TILE IS USED, ALL TILE TO BE INSTALLED WITH NO LESS THAN A 12" CUT AT ANY ENDING POINT.
- CONTRACTOR TO CONFIRM QUANTITY OF ATTIC STOCK REQUIRED WITH OWNER.

- ALL EXISTING A DRYWALL CEILINGS ARE TO BE PAINTED ((PT-3) CONTRACTOR TO CONFIRM ACCENT PAINT WALL LOCATIONS WITH TENANT PRIOR TO INSTALLATION. ALL EXISTING AND NEW TRIM TO BE PAINTED.
- PAINT ALL TRIN AND DOORS IN UMITS (PT-4) U.O.N.
- PAINT ALL TRIM AND DOORS IN COMMON SPACES (PT-7) UON



phone: 215.829.0922 x154 CONTACT PERSON: Chris Stigler

OWNER

STRUCTURAL DCI+Macintosh Engineers phone: 484.475.2180 CONTACT PERSON: Steve Krumenacker

Stantec phone: 215.665.7000 CONTACT PERSON: Greg Gress

2033 Chestnut Street Multifamily Building

Project Address: 2033 Chestnut St Philadelphia, PA 19103

2ND FLOOR INTERIOR FINISH PLAN




Release		
Date	Comments	Δ
		_
		_
		_
		-
		_
		\vdash
		$\overline{}$

BHA Job Number:	22-127
Scale:	As indicated
Drawn By:	Author
Checked By:	Checker
Approved By:	Approver

1 2ND FLOOR FINISH PLAN 1/4" = 1'-0"

FINISH PLAN KEYED NOTES

- PROVIDE FLOOR TO CEILING WALL TILE
 (WT-1) PROVIDE SCHLUTER STRIP FINISHED
 EDGE AT OUTSIDE CORNERS.
- ② PROVIDE SHOWER PAN (TZ-1)
- PROVIDE LYT TREADS (LVT-2) AND FLOORING.
 PROVIDE AVA FLOORING-FLUSH STAIR NOSING
 298 IN COLOR AND PATTERN TO MATCH
- PROVIDE FLOOR TRANSITION BETWEEN
 PROCELAIN TILE AND LVT SEE DETAIL (2/A9.10)
- PROVIDE FLOOR TRANSITION BETWEEN LYT IN CORRIDOR AND UNIT
- PROVIDE NEW BACKSPLASH TILE ABOVE THE COUNTER (WT-2)
- PROVIDE TRANSITION BETWEEN PORCELAIN TILE AND CONCRETE (3/A9.10)
- INTERIOR DOORS AND TRIM TO BE PAINTED (PT-9) IN UNITS
- (PT-4) IN HALLS
- 1 HAND RAILS TO BE PAINTED (PT-4)

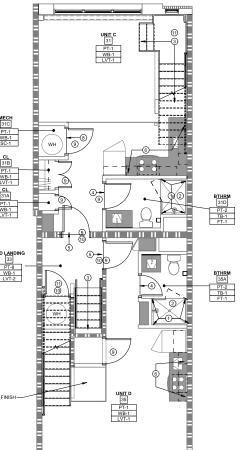

- ALL MATERIALS TO BE INSTALLED ACCORDING TO MANUFACTURER'S RECOMMENDED INSTRUCTIONS.
 - CONTRACTOR SHALL SUBMIT SAMPLES OF ALL FINISH MATERIALS TO OWNER FOR APPROVAL BEFORE ORDERING OR INSTALLING ANY FINISH MATERIAL INCLUMING BUT NOT LIMITE TO COARPET, PAINT, WALL COVERINGS, FLOORING MATERIALS AND ANY O'THER FINISH PRODUCT WHICH COMES IN A VARIETY OF FINISHS ST, TYPES AND CO LORS. THE FINISH SOME OWNER OF THE STATE OF THE STATE
 - CONTRACTOR TO PROTECT EXISTING AREAS DURING CONSTRUCTION AND CLEAN AS REQUIRED AT COMPLETION OF CONSTRUCTION.
 - ALL WALL, COLUMNS, SURFACES AND PERIPHERAL WINDOW DETAILS TO BE PROPERLY SPACKLED AND SANDED SMOOTH WITH NO VISIBLE JOINTS TO PROVIDE A PERFECTLY SMOOTH SURFACE TO RECEIVE ONE PRIMER COAT AND TWO FINISH COATS OF PAINT. EMSTING WALLS PREPARED AS REQUIRED TO LIKE-NEW CONDITION TO ACCEPT NEW FINISH PRODUCT.
 - REFER TO FINISH LEGEND FOR PAINT FINISH SPECIFICATION FOR WALLS. TRIM AND FRAMES TO BE SEMI-GLOSS LATEX.
 - CARPET SUBCONTRACTOR TO CHECK ALL DIMENSIONS IN THE FIELD TO VERIFY ACCURACY OF QUANTITIES IN QUOTATIONS. ALL FLOOR PATTERNS TO BE CENTERED IN CORRIDORS AND ROOMS, UNLESS OTHERWISE NOTED
 - ALL FLOOR FINISHES TO EXTEND UNDER CASEWORK AND KNEE SPACE AND ADA SINK CABINET.
 - ALL PARTITIONS TO BE PAINTED PT-1 UNLESS OTHERWISE NOTED.
 - FLOORING TO EXTEND IN TO ALL COAT CLOSETS AND SUPPLY CLOSETS UNLESS OTHERWISE NOTED.

 - CONTRACTOR SHALL, UPON COMPLETION, REMOVE ALL PAINT FROM WHERE IT SPILLED, SPLASHED, OR SPATTERED ON ALL SURFACES.
 - THE CONTRACTOR SHALL EXAMINE ALL AREAS OF CONSTRUCTION AFTER COMPLETION OF WORK BY ALL TRADES (INCLUDING CABLING, TELEPHONE AND FLOORING INSTALLATION, ETC). AND APPROVE ALL NECESSARY TOUCH UP PAINTING AND OR PATCHING.

 - PROVIDE REDUCER STRIPS AT CHANGE OF FLOOR MATERIALS AS REQUIRED. COLOR TO MATCH VINYL BASE, REDUCER STRIPS TO BE ADA COMPLIANT.
 - WHERE ATYPICAL CONDITIONS OCCUR, CONTRACTOR IS TO VERIFY FINISH TREATMENT WITH ARCHITECT BEFORE PROCEEDING.
 - PAINT ALL DIFFUSERS, GRILLES, ACCESS PANELS ETC. TO MATCH ADJACENT SURFACES.
 - SUB-FLOOR IS TO BE PATCHED, REPAIRED AND MADE SMOOTH AND LEVEL TO RECEIVE NEW FLOORING.
 - ALL SOFFITS TO BE SAME FINISH AND COLOR AS ADJACENT WALL U.O.N.

 - FLOOR COVERING SHALL BE INSTALLED IN ACCORDANCE WITH MANUFACTURING INSTRUCTIONS TO LAY SMOOTH AND EVENLY. WHERE CARPET TILE IS USED, ALL TILE TO BE INSTALLED WITH NO LESS THAN A 12" CUT AT ANY ENDING POINT.

 - PROVIDE LOW VOC PAINT FINISH THROUGHOUT. B.O.D. SHERWIN WILLIAMS: PRO MAR 200 HP ZERO VOC INTERIOR LATEX OR EQUAL.
 - ALL EXISTING A DRYWALL CEILINGS ARE TO BE PAINTED ((PT-3) CONTRACTOR TO CONFIRM ACCENT PAINT WALL LOCATIONS WITH TENANT PRIOR TO INSTALLATION, ALL EXISTING AND NEW TRIM TO BE PAINTED.
 - PAINT ALL TRIN AND DOORS IN UMITS (PT-4) U.O.N. PAINT ALL TRIM AND DOORS IN COMMON SPACES (PT-7) UON

FINISH PLAN GENERAL NOTES



phone: 215.829.0922 x154 CONTACT PERSON: Chris Stigler

OWNER

STRUCTURAL DCI+Macintosh Engineers phone: 484.475.2180 CONTACT PERSON: Steve Krumenacker

Stantec phone: 215.665.7000 CONTACT PERSON: Greg Gress

2033 Chestnut Street Multifamily Building


Project Address: 2033 Chestnut St Philadelphia, PA 19103


3RD FLOOR INTERIOR FINISH PLAN



Release		
Date	Comments	Δ
		-
		_
		_
		_
		_


BHA Job Number:	22-127
Scale:	As indicated
Drawn By:	Author
Checked By:	Checker
Approved By:	Approver

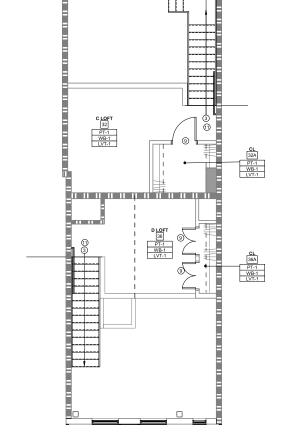

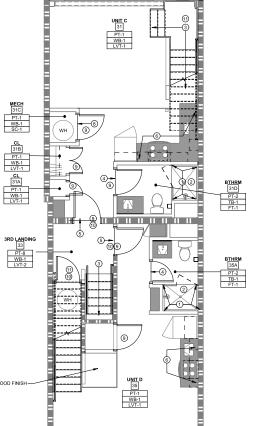


1/4" = 1'-0"

2 3RD FLOOR FINISH PLAN 1/4" = 1'-0"

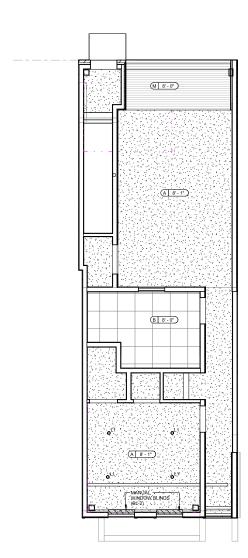

RCP LEGEND RECESSED DOWNLIGHT PENDANT LIGHT BATH WALL SCONCE 2X2 TROFFER LINEAR SLOT \boxtimes SUPPLY DIFFUSER RETURN GRILLE SPRINKLER SWITCH SWITCH - DIMMER A XX' - XX) CEILING TAG
CEILING HEIGHT
CEILING TYPE B 2X2 CEILING TILE & GRID
MFR: ARMSTRONG
STYLE: CIRRUS
SIZE: 2X2
GRID: BEVELED TEGULAR 9/16*
COLOR: WHITE

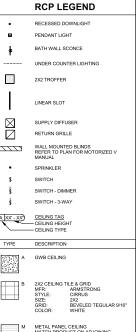

RCP KEYED NOTES

SAMPLE NOTE TEXT
 SAMPLE NOTE TEXT

CIVIL Stantec phone: 215.665.7000 CONTACT PERSON: Greg Gress

BLACKNEY H A Y E S ARCHITECTS

phone: 215.829.0922 x154 CONTACT PERSON: Chris Stigler

STRUCTURAL DCI+Macintosh Engineers phone: 484,475.2180 CONTACT PERSON: Steve Krumenacker

OWNER Thom Tahopoulos phone: 610.909.0204

2033 Chestnut Street Multifamily Building

Project Address: 2033 Chestnut St Philadelphia, PA 19103

1ST FLOOR RCP





Release		
Date	Comments	Δ
		-

BHA Job Number:	22-127
Scale:	As indicated
Drawn By:	JU
Checked By:	CS
Approved By:	JH




1ST FLOOR RCP 1/4" = 1'-0"

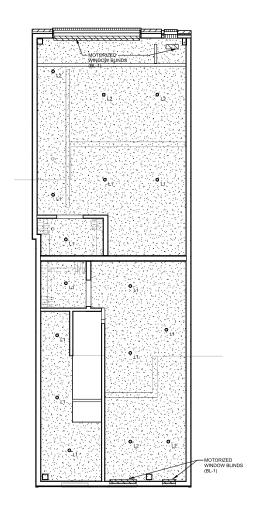

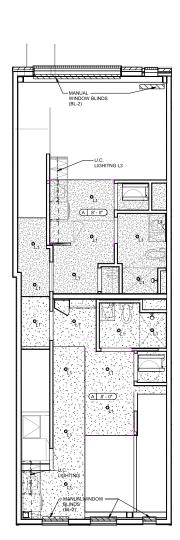

② 2ND LOFT RCP
1/4" = 1'-0"

2ND FLOOR RCP
1/4" = 1'-0"

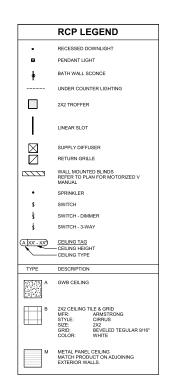

RCP KEYED NOTES

SAMPLE NOTE TEXT
 SAMPLE NOTE TEXT

2033 Chestnut Street Multifamily Building

BLACKNEY H A Y E S ARCHITECTS

phone: 215.829.0922 x154 CONTACT PERSON: Chris Stigler

STRUCTURAL DCI+Macintosh Engineers phone: 484.475.2180 CONTACT PERSON: Steve Krumenacker

CIVIL Stantec phone: 215.665.7000 CONTACT PERSON: Greg Gress

OWNER Thom Tahopoulos phone: 610.909.0204

Project Address: 2033 Chestnut St Philadelphia, PA 19103

2ND FLOOR RCPs

Sool



DUTY TO INSPECT CONTRACT DOCUMENTS REV TO STARTING WORK TO of which on the content to STARTING WORK TO of which on the content these Contraction Documents shall before loginised of Contract Documents, including all Diversity in the owner of Contract Documents, including all Diversity in each of Contract Documents, including all Diversity in each of Contract Documents, including all Diversity in the Contract Documents, including all Diversity in buildings, all parties relying on these documents approson of the contract of the contract of the contract that by lever septimes in the air and their response that by lever septimes in the air and their response that the contract of the contract of the contract of the product in qualitative and cool requirements and or the contract of the contract of the contract of the documents must, prior to beginning work, such as all conquests for cartifications and additional information for

written exception beforehand.

Warning: Actual conditions may vary from conditions shown on this drawing. Confirm all information in the before proceeding with any work and notify the Archill in writing if a vertation is referenced.


This drawing is not to be copied or transmitted in any form without the express written authorization of Blackney Hayes Architects. All ideas and concepts depicted or suggested in this drawing are the property Blackney Hayes Architects.


Release		
Date	Comments	Δ
		_
		_
		_
		_
		_

BHA Job Number:	22-127
Scale:	As indicated
Drawn By:	Author
Checked By:	Checker
Approved By:	Approver

^ ^

 \mathcal{L}

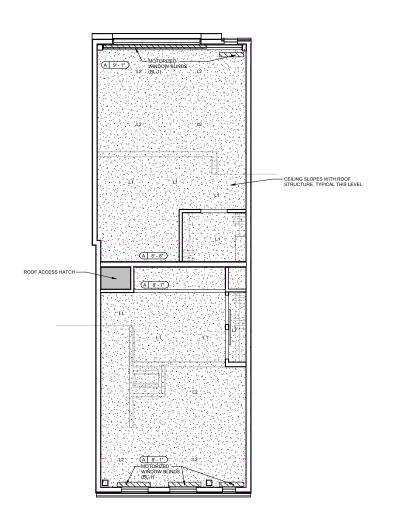

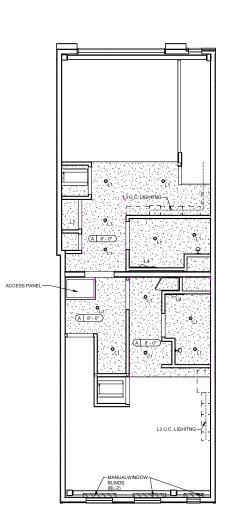

1/4" = 1'-0"

2 3RD FLOOR RCP 1/4" = 1'-0"

RCP LEGEND RECESSED DOWNLIGHT

PENDANT LIGHT

BATH WALL SCONCE

2X2 TROFFER

SUPPLY DIFFUSER RETURN GRILLE

SPRINKLER

SWITCH SWITCH - DIMMER

A XX'-XX CEILING TAG
CEILING HEIGHT
CEILING TYPE

B 2X2 CELLING TILE & GRID
MFR: ARMSTRONG
STYLE: CIRRUS
SIZE: 2X2
GRID: BEVELED TEGULAR 9/16*
COLOR: WHITE

RCP KEYED NOTES

SAMPLE NOTE TEXT
 SAMPLE NOTE TEXT



phone: 215.829.0922 x154 CONTACT PERSON: Chris Stigler

OWNER Thom Tahopoulos phone: 610.909.0204

STRUCTURAL DCI+Macintosh Engineers phone: 484.475.2180 CONTACT PERSON: Steve Krumenacker

CIVIL Stantec phone: 215.665.7000 CONTACT PERSON: Greg Gress

2033 Chestnut Street Multifamily Building


Project Address: 2033 Chestnut St Philadelphia, PA 19103

3RD FLOOR RCPs



Release		
Date	Comments	Δ
		_
		_
		_
		_
		_
		_
		_

BHA Job Number:	22-127
Scale:	As indicated
Drawn By:	Author
Checked By:	Checker
Approved By:	Approver

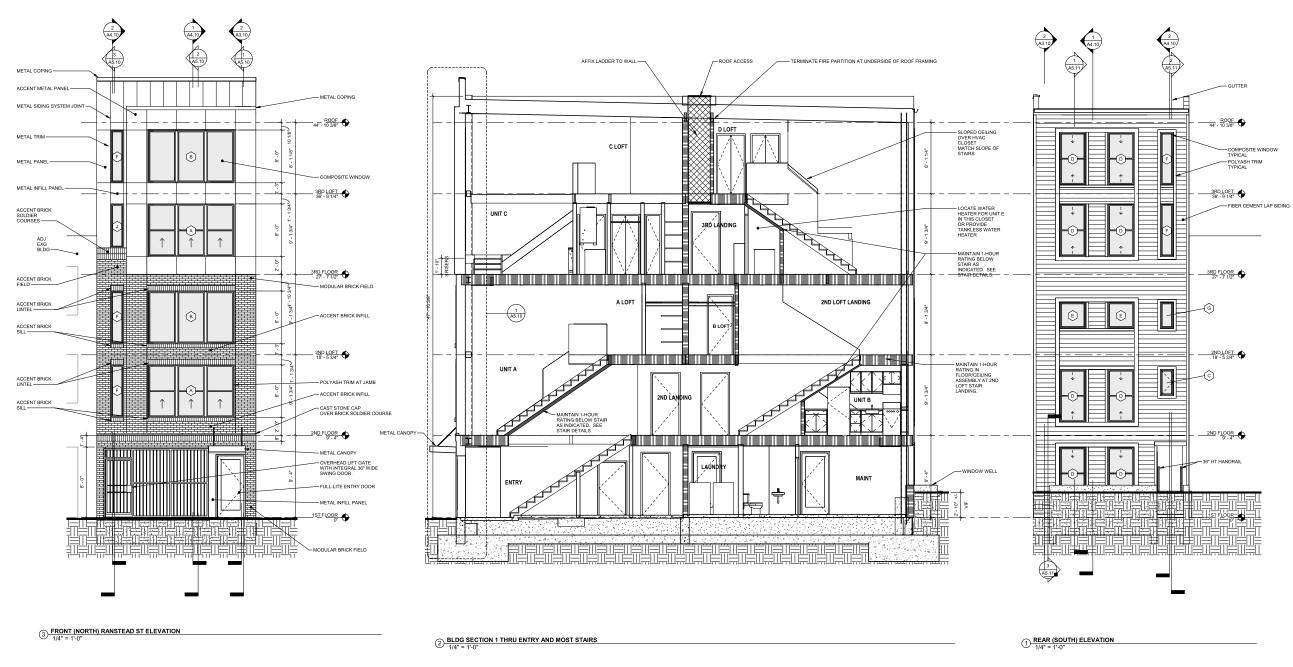



phone: 215.829.0922 x154 CONTACT PERSON: Chris Stigler

OWNER Thom Tahopoulos phone: 610.909.0204

STRUCTURAL DCI+Macintosh Engineers phone: 484.475.2180 CONTACT PERSON: Steve Krumenacker

CIVIL Stantec phone: 215.665.7000 CONTACT PERSON: Greg Gress

2033 Chestnut Street Multifamily Building


Project Address: 2033 Chestnut St Philadelphia, PA 19103

BUILDING **ELEVATIONS**



Date	Comments	2
		+
		_
		_
_		_

BHA Job Number:	22-127
Scale:	1/4" = 1'-0"
Drawn By:	JU
Checked By:	CS
Approved By:	JH

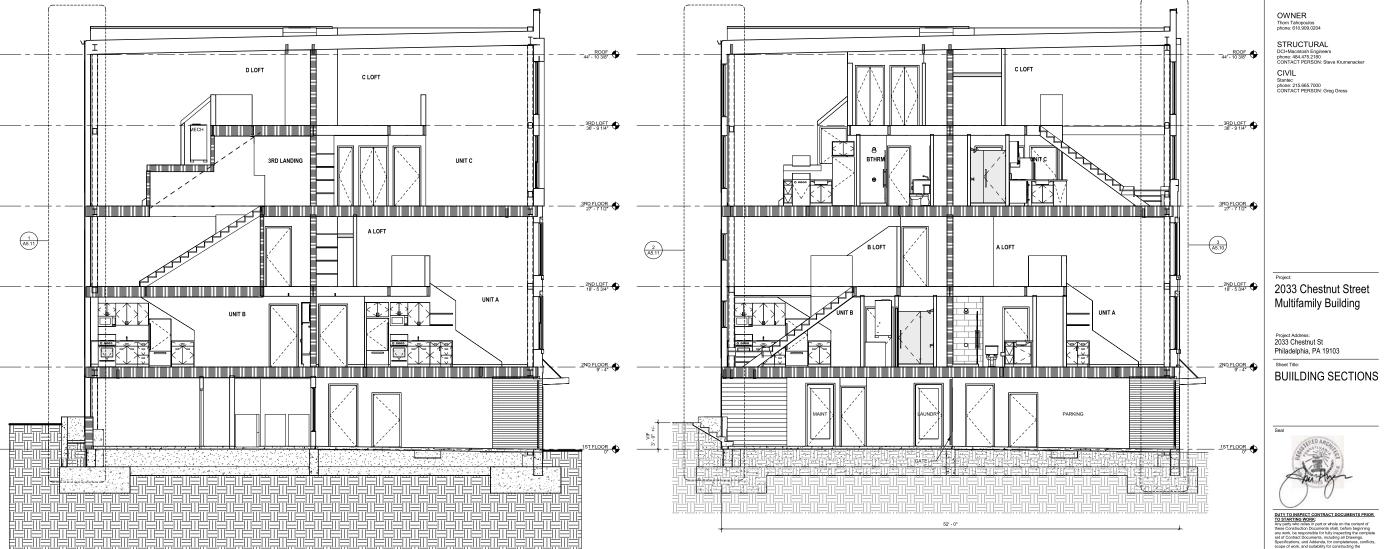

2 BLDG SECTION 3 THRU ALLEY
1/4" = 1'-0"

Project Address: 2033 Chestnut St Philadelphia, PA 19103

BLACKNEY HAYES ARCHITECTS

phone: 215.829.0922 x154 CONTACT PERSON: Chris Stigler

STRUCTURAL DCI+Macintosh Engineers phone: 484.475.2180 CONTACT PERSON: Steve Krumenacke

CIVIL Stantec phone: 215.665.7000 CONTACT PERSON: Greg Gress


OWNER Thom Tahopoulos phone: 610.909.0204

Date	Comments	
		_
_		_
		_
		_
-		
_		_

22-127
1/4" = 1'-0"
JU
CS
JH

1/4" = 1'-0"

BLDG SECTION 2 THRU WINDOW WELL & SWITCHBACK STAIRS

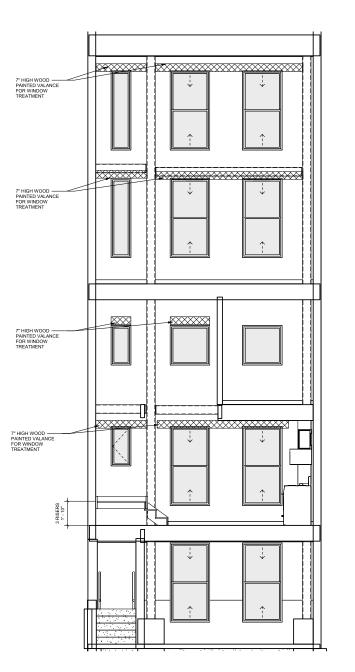

2 INTERIOR ELEVATION FACING REAR
3/8" = 1'-0"



phone: 215.829.0922 x154 CONTACT PERSON: Chris Stigler

OWNER Thom Tahopoulos phone: 610.909.0204

STRUCTURAL DCI+Macintosh Engineers phone: 484.475.2180 CONTACT PERSON: Steve Krumenacker

CIVIL
Stantec
phone: 215.665.7000
CONTACT PERSON: Greg Gress

2033 Chestnut Street Multifamily Building


Project Address: 2033 Chestnut St Philadelphia, PA 19103


Sheet Title:
BUILDING SECTIONS



Release		
Date	Comments	Δ
		\vdash
		\vdash
	1	

22-127
3/8" = 1'-0"
Author
Checker
Approver

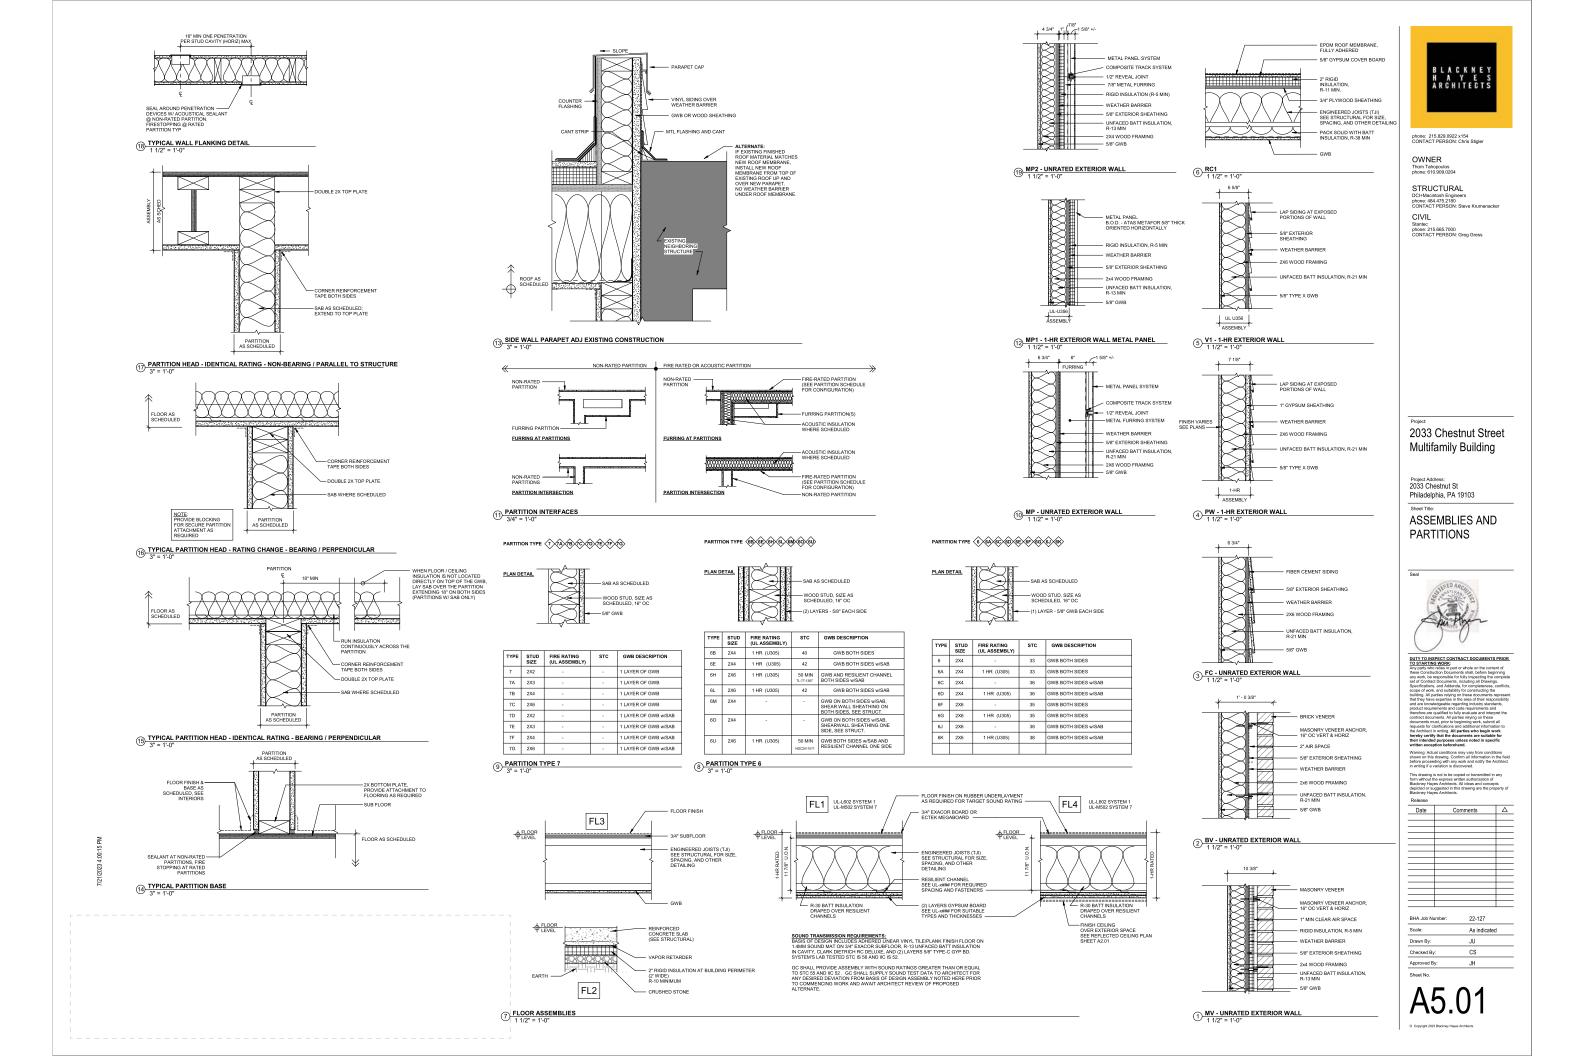

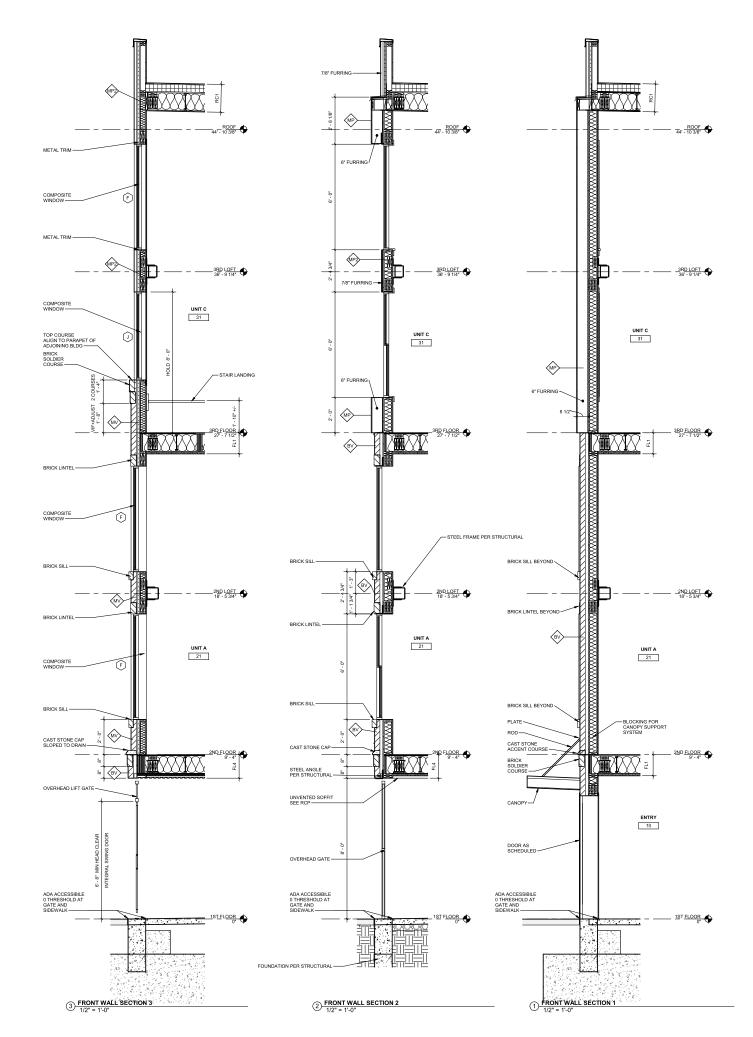



phone: 215.829.0922 x154 CONTACT PERSON: Chris Stigler

OWNER Thom Tahopoulos phone: 610.909.0204

STRUCTURAL DCI+Macintosh Engineers phone: 484.475.2180 CONTACT PERSON: Steve Krumenacker

CIVIL Stantec phone: 215.665.7000 CONTACT PERSON: Greg Gress


2033 Chestnut Street Multifamily Building

Project Address: 2033 Chestnut St Philadelphia, PA 19103

Sheet Title:
WALL SECTIONS
FRONT



Release		
Date	Comments	Δ
		=
-		+
-		+-
$\overline{}$		+-
-		+-
$\overline{}$		+-
$\overline{}$		+-
		+
		\perp
BHA Job Nu	mher: 22-127	

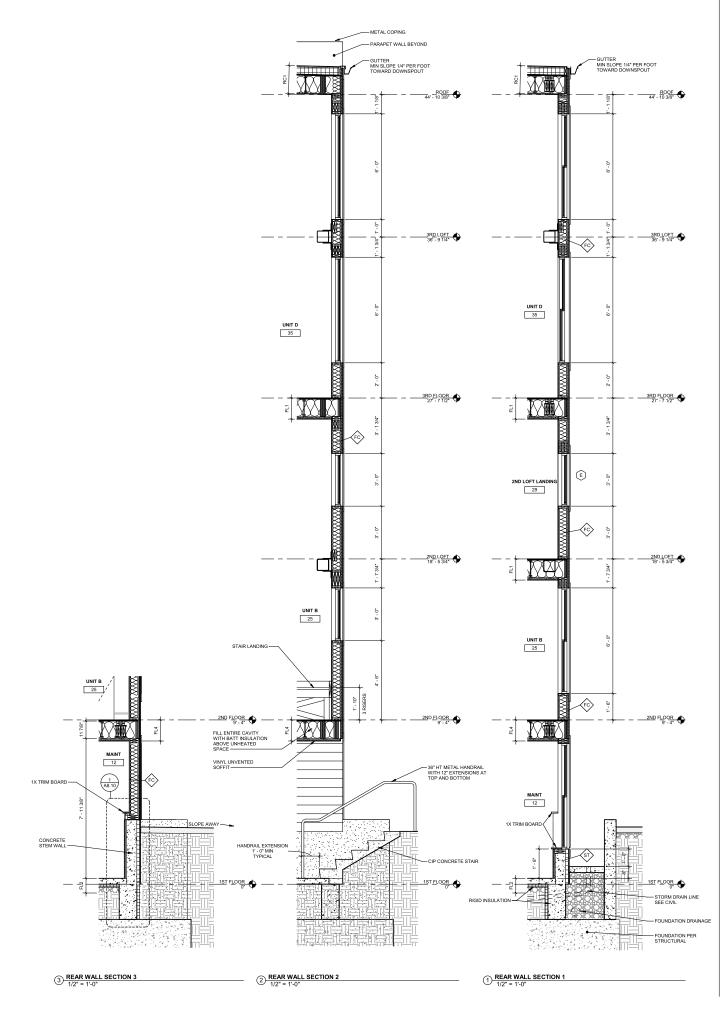



phone: 215.829.0922 x154 CONTACT PERSON: Chris Stigler

OWNER Thom Tahopoulos phone: 610.909.0204

STRUCTURAL DCI+Macintosh Engineers phone: 484.475.2180 CONTACT PERSON: Steve Krumenacker

CIVIL Stantec phone: 215.665.7000 CONTACT PERSON: Greg Gress

2033 Chestnut Street Multifamily Building

Project Address: 2033 Chestnut St Philadelphia, PA 19103


Sheet Title:
WALL SECTIONS REAR




Release		
Date	Comments	Δ
		_
		_
		_
		\vdash
BHA Job Ni	ımher: 22-127	


1/2" = 1'-0" Drawn By: Author Checker


A5.11

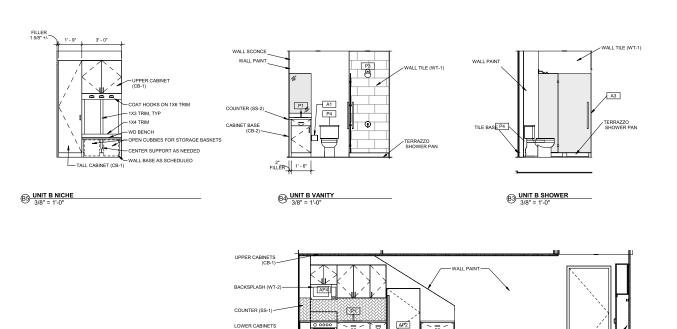

B2 UNIT B KITCHEN
3/8" = 1'-0"

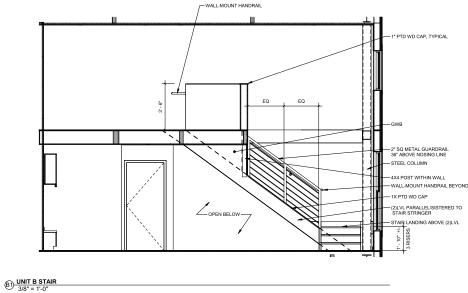

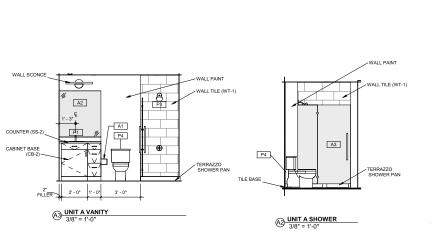

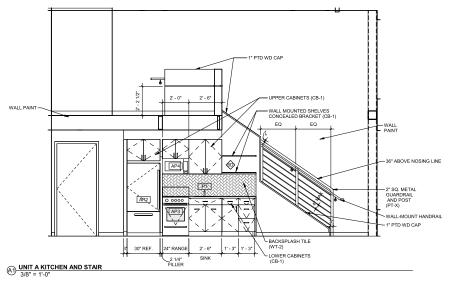



phone: 215.829.0922 x154 CONTACT PERSON: Chris Stigler

OWNER Thom Tahopoulos phone: 610.909.0204

STRUCTURAL DCI+Macintosh Engineers phone: 484.475.2180 CONTACT PERSON: Steve Krumenacker

CIVIL Stantec phone: 215.665.7000 CONTACT PERSON: Greg Gress

2033 Chestnut Street Multifamily Building


Project Address: 2033 Chestnut St Philadelphia, PA 19103


Sheet Title: INTERIOR ELEVATIONS A+B


Date	Comments	
-		
-		+
		_


22-127
3/8" = 1'-0"
JU
CS
JH


A6.10

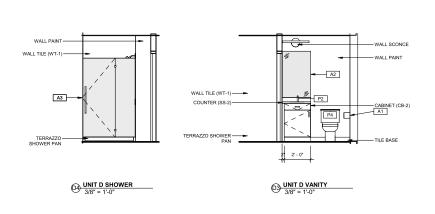

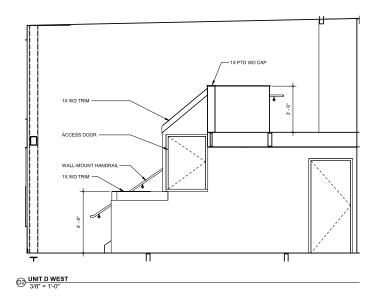

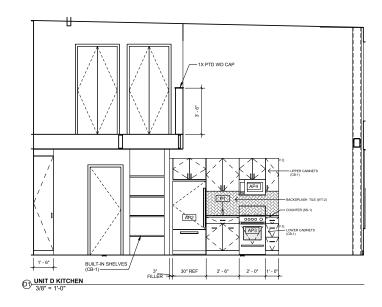

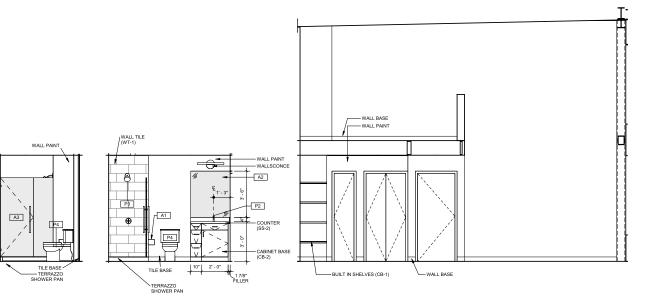

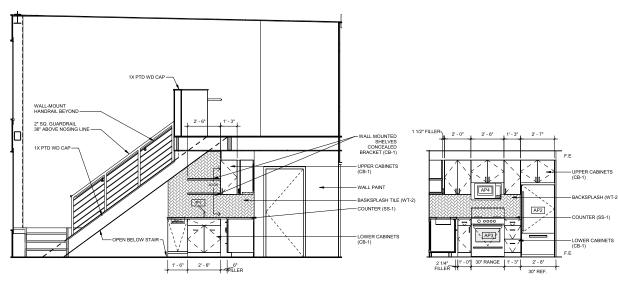

(A) UNIT C VANITY ©3 UNIT C NICHE
3/8" = 1'-0"

(1) UNIT C KITCHEN 3/8" = 1'-0"



phone: 215.829.0922 x154 CONTACT PERSON: Chris Stigler

OWNER Thom Tahopoulos phone: 610.909.0204

STRUCTURAL DCI+Macintosh Engineers phone: 484.475.2180 CONTACT PERSON: Steve Krumenacker

CIVIL Stantec phone: 215.665.7000 CONTACT PERSON: Greg Gress

2033 Chestnut Street Multifamily Building

Project Address: 2033 Chestnut St Philadelphia, PA 19103


Sheet Title: INTERIOR ELEVATIONS C+D



Date	Comments	
		_
		+
		_
		_
		_

BHA Job Number:	22-127
Scale:	3/8" = 1'-0"
Drawn By:	Author
Checked By:	Checker
Approved By:	Approver

A6.11

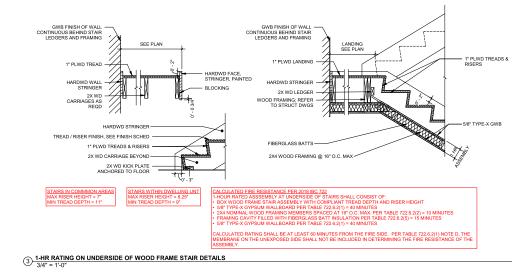

2X WD LEDGER -- 2 X 8 CONT FRT WD BLKG. 3/4" PLWD @ SHAFTWALL MiN. 2 HANDRAIL DETAILS - TYP 3/8" = 1'-0" 1 TYPICAL WOOD FRAME STAIR DETAILS
3/4" = 1'-0"

BLACKNEY H A Y E S ARCHITECTS

phone: 215.829.0922 x154 CONTACT PERSON: Chris Stigler

OWNER Thom Tahopoulos phone: 610.909.0204

STRUCTURAL DCI+Macintosh Engineers phone: 484.475.2180 CONTACT PERSON: Steve Krumenacker

CIVIL Stantec phone: 215.665.7000 CONTACT PERSON: Greg Gress

2033 Chestnut Street Multifamily Building

Project Address: 2033 Chestnut St Philadelphia, PA 19103

Sheet Title:
STAIR DETAILS



Date	Comments	ΤΔ
Buto	Commonto	
		-
		-
		-


 Scale:
 As indicat

 Drawn By:
 JJ


 Checked By:
 CS

 Approved By:
 JH


 Sheet No.
 A7.10

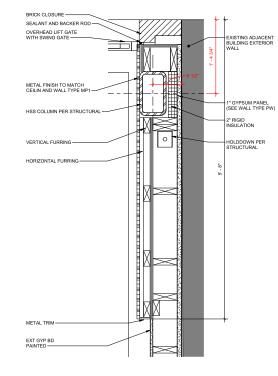

2 PLAN DETAIL - NE COLUMN
1 1/2" = 1'-0"

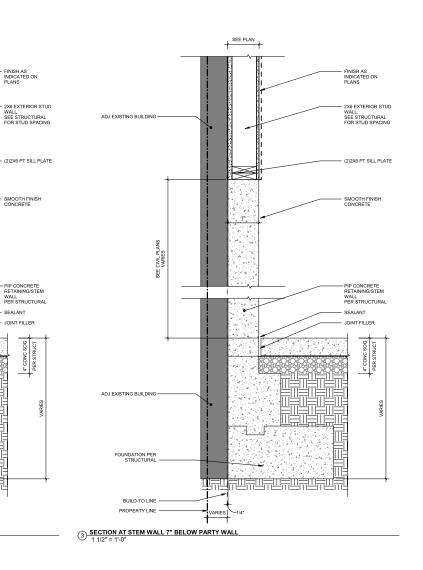

4 SECTION AT STEM WALL 7" ALONG EAST PROP LINE 1 1/2" = 1'-0"

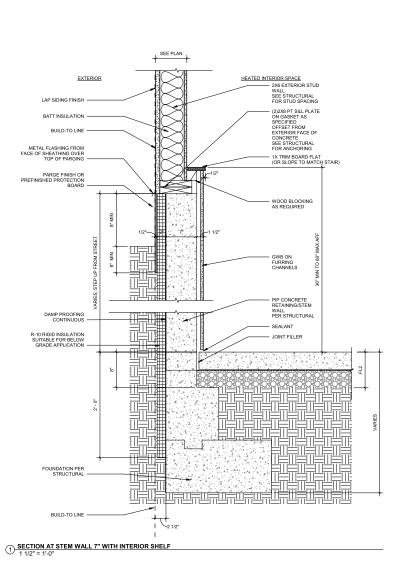



phone: 215.829.0922 x154 CONTACT PERSON: Chris Stigler

OWNER Thom Tahopoulos phone: 610.909.0204

STRUCTURAL DCI+Macintosh Engineers phone: 484.475.2180 CONTACT PERSON: Steve Krumenacker

CIVIL Stantec phone: 215.665.7000 CONTACT PERSON: Greg Gress

2033 Chestnut Street Multifamily Building

Project Address: 2033 Chestnut St Philadelphia, PA 19103

PARTITION, FIRE
RATED ASSEMBLY, &
PENETRATION **DETAILS**



elease		
Date	Comments	$\top \Delta$
		=
		_
		+
		_
		=
		+
		+
		_
HA Job Nu	umber: 22-127	
cale:	1 1/2" = 1	'-0"
rawn By:	JU	

DOOR SCHEDULE													
		ROOM LOCATION	ROOM LOCATION		D	OOR				FRAME			
DOOR NO.	DOOR TYPE	NUMBER	NAME	WIDTH	HEIGHT	MATERIAL	FINISH	FIRE RATING	TYPE	MATERIAL	FINISH	HARDWARE	COMMENTS
	•	•								•		•	
ST FLOOR													
	FG			3' - 0"	7' - 0"	WD							
0B	F			3" - 0"	7' - 0"	WD		-	-			-	
1	FG	11	LAUNDRY	3' - 0"	7' - 0"	WD			-				
1A	F			2" - 8"	6' - 8"	WD							
2	FG	12	MAINT	3' - 0"	7" - 0"	WD			-			-	
2A		12	MAINT	2' - 10"	6' - 8"	WD			-			-	
2B	F	12	MAINT	2' - 8"	6' - 8"	WD						-	
ND FLOOR	1-	In.	I										
1			UNIT A	3' - 0"	7' - 0"	WD	PTD	60	В			-	
1A		21A	CL	2' - 4"	6' - 8"	WD	PTD	-	-			-	
1B		21B	BTHRM	2' - 8"	6' - 8"	WD	PTD		В				
1C		21C	MECH	2" - 8"	6' - 8"	WD	PTD					-	
5		25	UNIT B	3' - 0"	7" - 0"	WD	PTD	60	В			-	
5A		25A	MECH	2' - 10"	6' - 8"	WD	PTD	-	-			-	
5B	В	25B	BTHRM	3' - 0"	6' - 8"	WD	PTD		-			-	
ND LOFT													
2			A LOFT	2' - 8"	6' - 8"	WD	PTD	-	-			-	
ŝ	F	26	B LOFT	2' - 8"	6' - 8"	WD	PTD		-			-	
RD FLOOR													
1			UNIT C	3' - 0"	7' - 0"	WD	PTD	60	В			-	
1A	F	10B	UTILITY	1'-6"	6' - 8"	WD	PTD		-			-	
1B		10A	UTILITY	3' - 0"	6' - 8"	WD	PTD					-	·
1C		10A	UTILITY	2' - 10"	6' - 8"	WD	PTD						
1D	F	31D	BTHRM	2' - 10"	6' - 8"	WD	PTD	-	-			-	
3		33	3RD LANDING	2" - 8"	6' - 8"	WD	PTD		-			-	
5		35	UNIT D	3' - 0"	7' - 0"	WD	PTD	60	В			-	
5A	F	35A	BTHRM	2" - 4"	6' - 8"	WD	PTD		-			-	
	•	•	•							•		•	
RD LOFT													
2	F	32	C LOFT	2' - 8"	6' - 8"	WD	PTD	-				-	
6A	2F	36	D LOFT	3' - 0"	6' - 8"	WD	PTD		-			-	
6B		36	D LOFT	3' - 0"	6' - 8"	WD	PTD	-				-	



phone: 215.829.0922 x154 CONTACT PERSON: Chris Stigler

OWNER Thom Tahopoulos phone: 610.909.0204

STRUCTURAL DCI+Macintosh Engineers phone: 484.475.2180 CONTACT PERSON: Steve Krumenacker

CIVIL Stantec phone: 215.665.7000 CONTACT PERSON: Greg Gress

2033 Chestnut Street Multifamily Building

Project Address: 2033 Chestnut St Philadelphia, PA 19103

Sheet Title:
DOORS




Date	Comments	Δ


BHA Job Number:	22-127
Scale:	As indicated
Drawn By:	JU
Checked By:	CS
Approved By:	JH

Approved By: JH

A9.10

 $\underbrace{\text{$\uparrow$}}_{6^{\text{n}}=\,1^{\text{h}}\text{-}0^{\text{n}}} \text{$\text{TRANSITION FLOOR AT RESILIENT FLOORING TO SEALE} D \text{ CONCRETE}}_{6^{\text{n}}=\,1^{\text{h}}\text{-}0^{\text{n}}}$

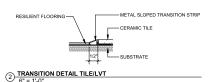

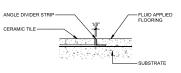

(3) TRANSITION DETAIL CERAMIC/ CONCRETE

ALL GLAZING UNITS IGU UON. OTHER TYPES AS INDICATED. GLAZING IN HAZARDOUS LOCATIONS AS DEFINED BY II 2406.4 SHALL COMPLY WITH 2406.1.1 THROUGH 2406.1. ALL OPENINGS TO BE VIF. CODE MAX 6HACT OF 0.32 CODE MAX 6HACT OF 0.32

OOOR TYPES

1/4" = 1'-0"

BLACKNEY HAYES ARCHITECTS

phone: 215.829.0922 x154 CONTACT PERSON: Chris Stigler

OWNER Thom Tahopoulos phone: 610.909.0204

STRUCTURAL DCI+Macintosh Engineers phone: 484.475.2180 CONTACT PERSON: Steve Krumenacker

CIVIL Stantec phone: 215.665.7000 CONTACT PERSON: Greg Gress

2033 Chestnut Street Multifamily Building

Project Address: 2033 Chestnut St Philadelphia, PA 19103

Sheet Title:
WINDOWS

Date	Comments	
Date	Confinents	
		_
		_
_		_
_		_
		_
_		_
-		_
		-
_		_
		_
		_
		_

BHA Job Number: 22-127
Scalle: As indicate
Drawn By: JU
Checked By: CS
Approved By: JH
Sheet No.

A9 20

