ADDRESS: 3401 HAMILTON ST

Proposal: Construct mixed-use building Review Requested: Final Approval

Owner: 3401 Hamilton LLC

Applicant: Derek Spencer, Gnome Architects LLC

History: Non-historic commercial structure and parking lot

Individual Designation: None

District Designation: Powelton Village Historic District, Non-contributing, 11/10/2022

Staff Contact: Kim Chantry, kim.chantry@phila.gov

BACKGROUND: This application proposes to construct a four-story mixed-use masonry building on a non-contributing property at the corner of N. 34th and Hamilton Streets in the newly designated Powelton Village Historic District. The Historical Commission enjoys plenary jurisdiction over this proposal owing to the one-story, non-contributing building, which was on the site at the time of the designation of the historic district. The surrounding context is primarily three-story brick and stone twins and rows with set back from the streets with front yards.

The proposed building lacks any setback from the sidewalk. The fenestration and overall flatness of the facades lacks the rhythm typical of the surrounding residential context.

SCOPE OF WORK:

Construct four-story mixed-use building with pilot houses and deck.

STANDARDS FOR REVIEW:

- Standard 9: New additions, exterior alterations, or related new construction will not
 destroy historic materials, features, and spatial relationships that characterize the
 property. The new work will be differentiated from the old and will be compatible with the
 historic materials, features, size, scale and proportion, and massing to protect the
 integrity of the property and its environment.
 - The proposed construction is in keeping with the general materials and height of the district, but not the setbacks, size, scale, proportion, fenestration, or features of the district, failing to satisfy Standard 9.

STAFF RECOMMENDATION: Denial, pursuant to Standard 9.



11.15.2022

Gnome Architects LLc.

1901 S. 9th Street, RM. 310
Philadelphia, PA 19148
gabe@gnomearch.com
215 279 7531

City of Philadelphia Historical Commision 1515 Arch St. 13th Floor

RE: 3401 Hamilton St.

Philadelphia, PA 19104

Application for Formal Review

Owner: 3401 Hamilton LLC

To Members of Philadelphia Historical Commission,

Please see the attached application for formal review of a proposed 4 story structure, containing 15 dwelling units and 1 vacant commercial space. Included in the presentation documents are photos, zoning & architectural plans, and elevations/renderings.

Please do not hesitate to contact me should you have any questions.

Best Regards,
Gabriel Deck RA, LEED AP
Principal Architect



(1) VIEW ON 34TH ST



(3) VIEW ON HAMILTON ST



(2) VIEW WEST ON HAMILTON ST



(4) VIEW SOUTH ON 34TH ST



(1) 412 N. 34TH ST



(4) 3312-18 HAMILTON ST




(2) 424 N. 34TH ST





(5) 411-37 N. 34TH ST



(3) 3403 HAMILTON ST

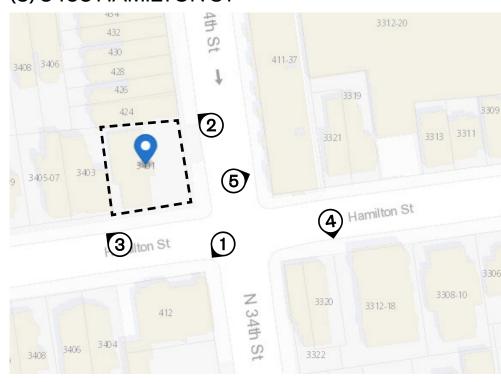


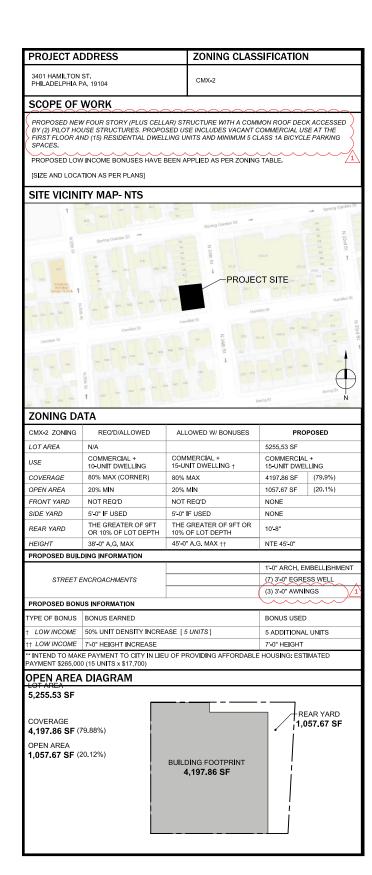


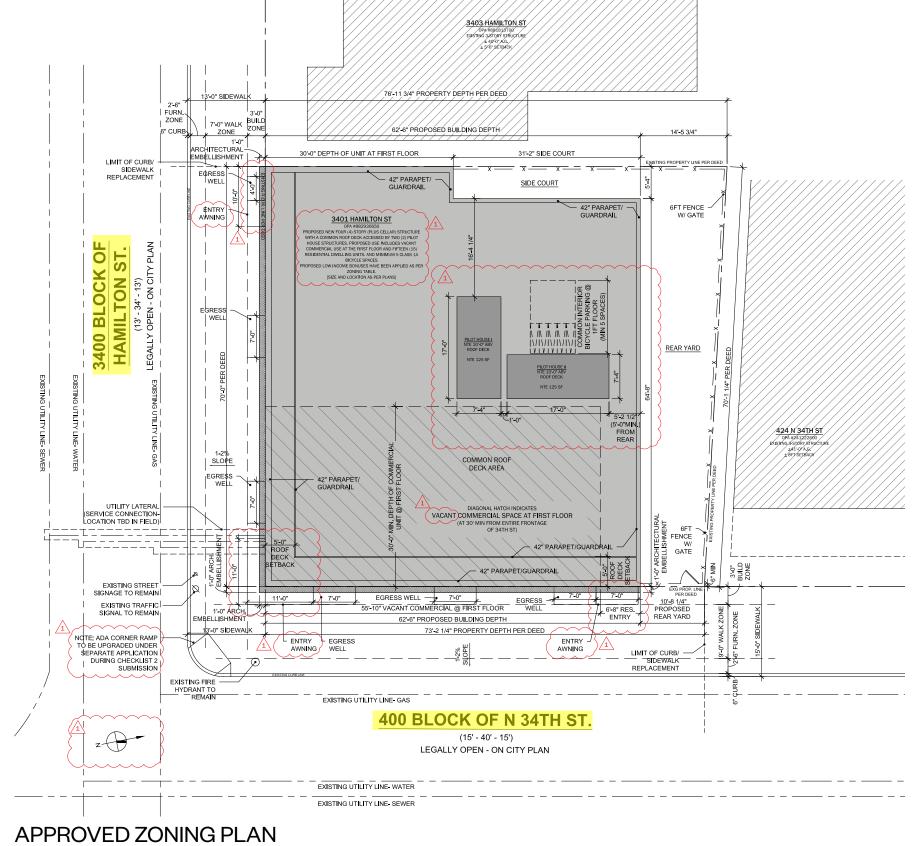

APPROVED ZONING PLAN SCALE: 1/16" = 1'-0"

ZONING PLAN

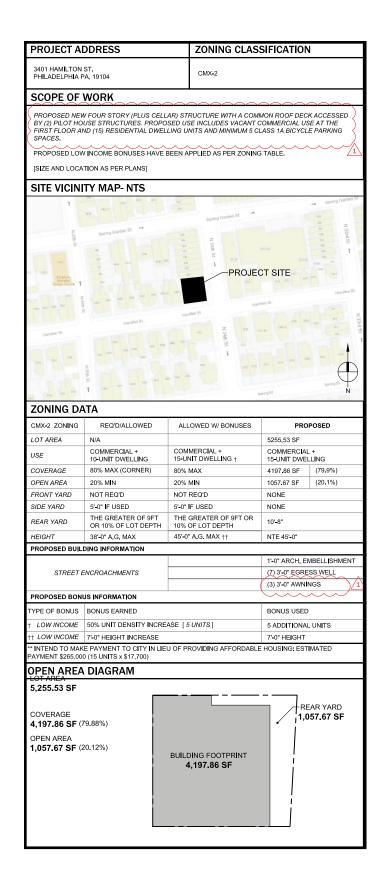

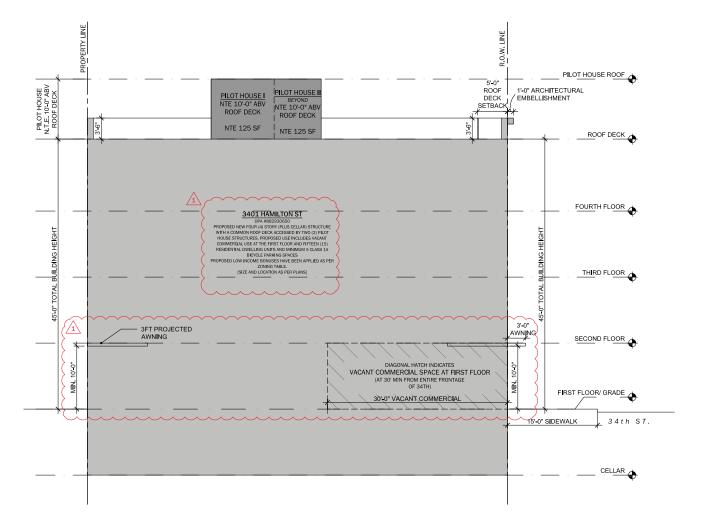

APPROVED ZONING SECTION SCALE: 1/16" = 1'-0"



CORNER VIEW AT 34TH & HAMILTON

3401 HAMILTON ST | PHC | PAGE 6



43 G




34TH ST ELEVATION 3401 HAMILTON ST | PHC | PAGE 8



HAMILTON ST ELEVATION
3401 HAMILTON ST | PHC | PAGE 9





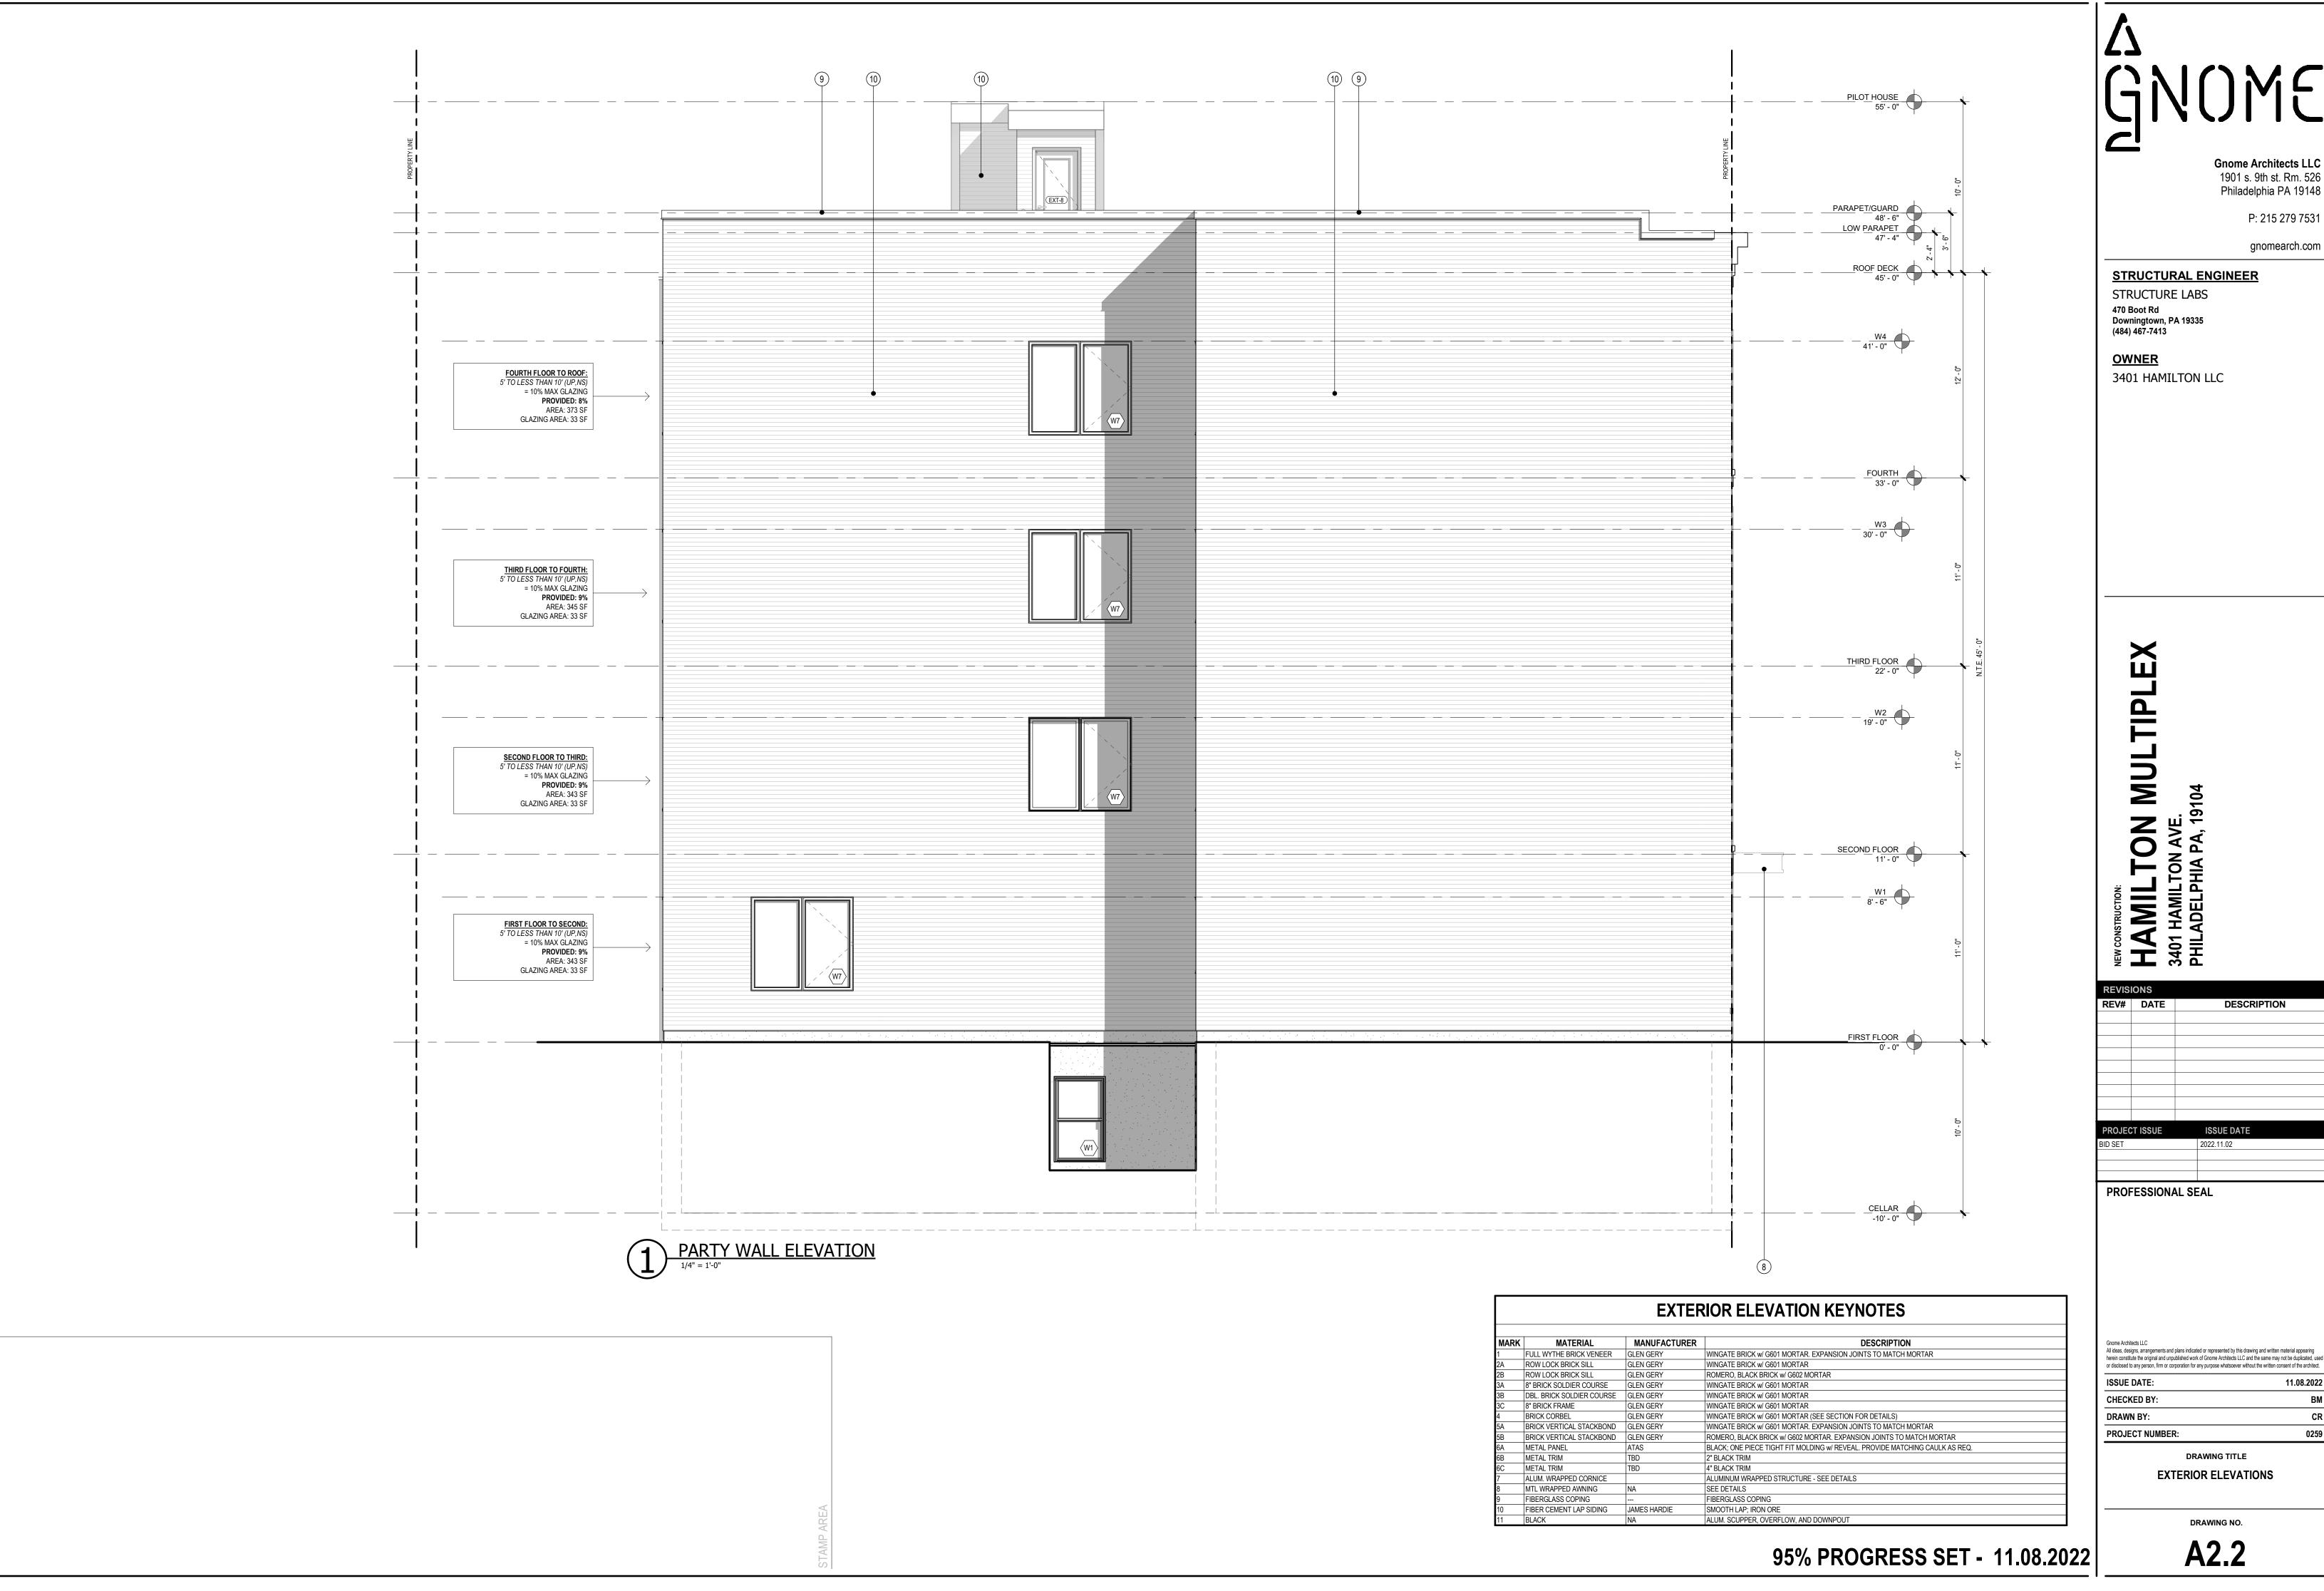

Gnome Architects LLC 1901 s. 9th st. Rm. 526 Philadelphia PA 19148

gnomearch.com

DESCRIPTION

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EXTERIOR ELEVATIONS



- . REFER TO STRUCTURAL DRAWINGS FOR BRACED WALL PANEL DETAIL INFORMATION. 2. ALL NEW PARTITIONS ARE DIMENSIONED TO FACE OF WALL FINISH. NOTIFY ARCHITECT OF ANY FRAMING DISCREPANCIES BETWEEN STRUCTURAL AND ARCHITECTURAL
- 3. UNTAGGED WALLS ARE TYP. 2x4 NON RATED INTERIOR WALLS. REFER TO PARTITION TYPES FOR ADDITIONAL INFORMAITON.
- 4. REFER TO OVERALL PLANS AND ELEVATIONS FOR WINDOWS. UNIT WINDOW LOCATIONS MAY VARY ACROSS FLOORS.

PLAN SYMBOL LEGEND

$\langle x \rangle$	WINDOW TAG
[#] 	PARTITION TA

- #
- SMOKE DETECTOR ALL UNITS SHALL BE HARD WIRED W/BATTERY BACKUP AND INTERCONNECTED. SMOKE DETECTORS TO BE INSTALLED IN EACH BEDROOM, HALL AREA, AND IN THE IMMEDIATE VICINITY OF BEDROOMS AND ON EACH FLOOR OF THE DWELLING.
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- **EXHAUST FAN** MIN. C.F.M. PER APPLICABLE CODE

	•—1	KEYED	PLAN	NO.	ΓΕ
MARK		D	ESCRIPTION		
1	DDOVIDE 36" CONTINIO	IC HANDDAIL ON E	OTH CIDES OF	CTEDC I	

PROVIDE 36" CONTINIOUS HANDRAIL ON BOTH SIDES OF STEPS. HANDRAIL SHALL EXTEND/WRAP 1' PAST LAST RISER PER 1014.6 OF THE I.B.C. PROVIDE 36" CONTINIOUS HANDRAIL AT ALL STEPS PROVIDE 42" PARAPET/ GAURDRAIL (TYP.) FROM HIGHEST POINT OF ROOF SURFACE; INCLUDING ALL RIDGES & CRICKETS FIBERGLASS ROOF MEMBRANE SYSTEM w/CLASS B (MIN) ROOF COVERING OVER ROOF STRUCTURE AS PER DETAILS

PROVIDE F.R.T. PLYWOOD 4'-0" MIN. OFF PROPERTY LINE 42" GAURDRAIL - REFER TO GENERAL NOTES FOR GAURDRAIL REQUIREMENTS PROVIDE 1:48 SLOPED CRICKET: VALLEY TO HAVE 1:96 MIN SLOPE (TYP.)

MIN. TREAD DEPTH 9" MAX. RISER HGHT 8" V.I.F. RISER COUNT AS REQ'D

MIN. TREAD DEPTH 11" MAX. RISER HGHT 7" V.I.F. RISER COUNT AS REQ'D 10 EGRESS WELL W/ WALKABLE FLUSH GRATE AS PER DETAIL PROVIDE HARD DUCTED DRYER EXHAUST SYSTEM IN ACCORDANCE WITH IMC 2018 REQUIREMENTS

M.E.P. CHASE WALL SIZE & LOCATIONS TO BE COORDINATED w/ M.E.P. DRAWING EMERGENCY ESCAPE LADDER PER IBC 1029.5.2 (SEE EGRESS WELL DETAIL)

INTERNAL ROOF DRAIN: PROVIDE OVERFLOW IN ACCORDANCE WITH LOCAL CODE REQUIREMNETS THROUGH WALL SCUPPER & DOWNSPOUT: PROVIDE OVERFLOW IN ACCORDANCE W/ LOCAL

REQUIRMENTS 16 PROVIDE SWING GATE IN ACCORDANCE WITH IBC SECTION 1023.8

PROVIDE STANDPIPE IN ACCORDANCE IBC SECTION 905.3.1 ACCESSIBLE PRIMARY ENTRACE. PROVIDE MAX 1/2" THRESHOLD IN ACCORDANCE W/ ICC A117.1-2021, SECTION 1004.11.1 19 SLOPED METAL WRAPPED AWNING

20 ENTRY FOB & INTERCOM 4" MIN. DOOR CURB PER PECO REQUIREMENTS

12X12 SUMP PUMP w. STL. GRATE PER PECO REQUIREMENTS HVAC ON RAISED PLATFORM w/ HOT WATER BELOW


SLOPE FLOOR TO DRAIN


25 LOW PARAPET - SEE DETAILS ADA COMMERCIAL BATHROOM PER 2017 ANSI STANDARDS - SEE DETAILS FOR REFERENCE.

CONDENSOR LOCATION, COORD. w/ HVAC REQ. UNDER SEPERATE PERMIT. PROVIDE PAD, DUNAGE, & FALL PROTECTION AS REQ.

28 PREFAB METAL GRATE STAIR OVER FIBERGLASS DECK. MIN. TREAD DEPTH 11" MAX. RISER HGHT 7" V.I.F. RISER COUNT AS REQ'D

				BL	IILDING DOOR SCHEDU	JLE
	DOOR WIDTH					
				1		
Mark		SECOND LEAF	HEIGHT	RATING	DOOR HARDWARE SET	COMMENTS
C-01	3' - 0"		6' - 8"		SET #9	
C-02	3' - 0"		7' - 0"	1/3HR	SET #7	
C-03	3' - 0"		7' - 0"	1/3HR	SET#7	
C-04	3' - 0"		7' - 0"	3HR	SET#7	
C-05	3' - 0"		7' - 0"	1/3HR	SET#5	
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C-07	3' - 0"		6' - 8"		SET #10	
EXT-1	3' - 0"		7' - 0"		SET#2	
EXT-2	3' - 0"		7' - 0"		SET#1	
EXT-3	3' - 0"	3' - 0"	8' - 6"		SET#3	
EXT-4	3' - 0"		8' - 6"		SET#1	
EXT-5	3' - 0"		8' - 6"		SET#1	
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EXT-7	2' - 6"		7' - 0"		SET #8	
EXT-8	2' - 6"		7' - 0"		SET#8	
EXT-9	3' - 0"	3' - 0"	7' - 0"		SET#6	
STA-0	3' - 0"		7' - 0"	90 MIN	SET#5	
STA-1	3' - 0"		7' - 0"	90 MIN	SET#5	
STA-2	3' - 0"		7' - 0"	90 MIN	SET#5	
STA-3	3' - 0"		7' - 0"	90 MIN	SET#5	
STA-4	3' - 0"		7' - 0"	90 MIN	SET#5	
STB-2	3' - 0"		7' - 0"	90 MIN	SET#5	
STB-3	3' - 0"		7' - 0"	90 MIN	SET#5	
STB-4	3' - 0"		7' - 0"	90 MIN	SET#5	
U-01	3' - 0"		7' - 0"	1/3HR	SET#4	
U-03	3' - 0"		7' - 0"	1/3HR	SET #4	
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U-05	3' - 0"		7' - 0"	1/3HR	SET#4	
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J-09	3' - 0"		7' - 0"	1/3HR	SET #4	
J-10	3' - 0"		7' - 0"	1/3HR	SET #4	
J-11	3' - 0"		7' - 0"	1/3HR	SET #4	
U-12	3' - 0"		7' - 0"	1/3HR	SET #4	
U-13	3' - 0"		7' - 0"	1/3HR	SET #4	
J-14	3' - 0"		7' - 0"	1/3HR	SET #4	
11.45	יי חיי		7' 0"	1/2LID	CET #4	

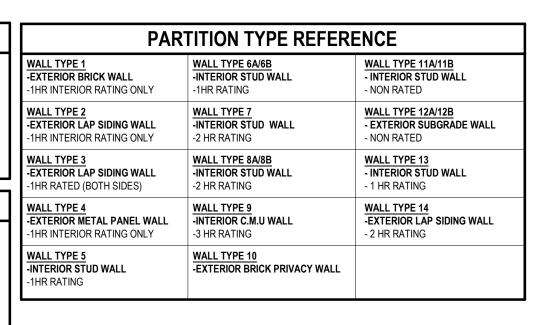

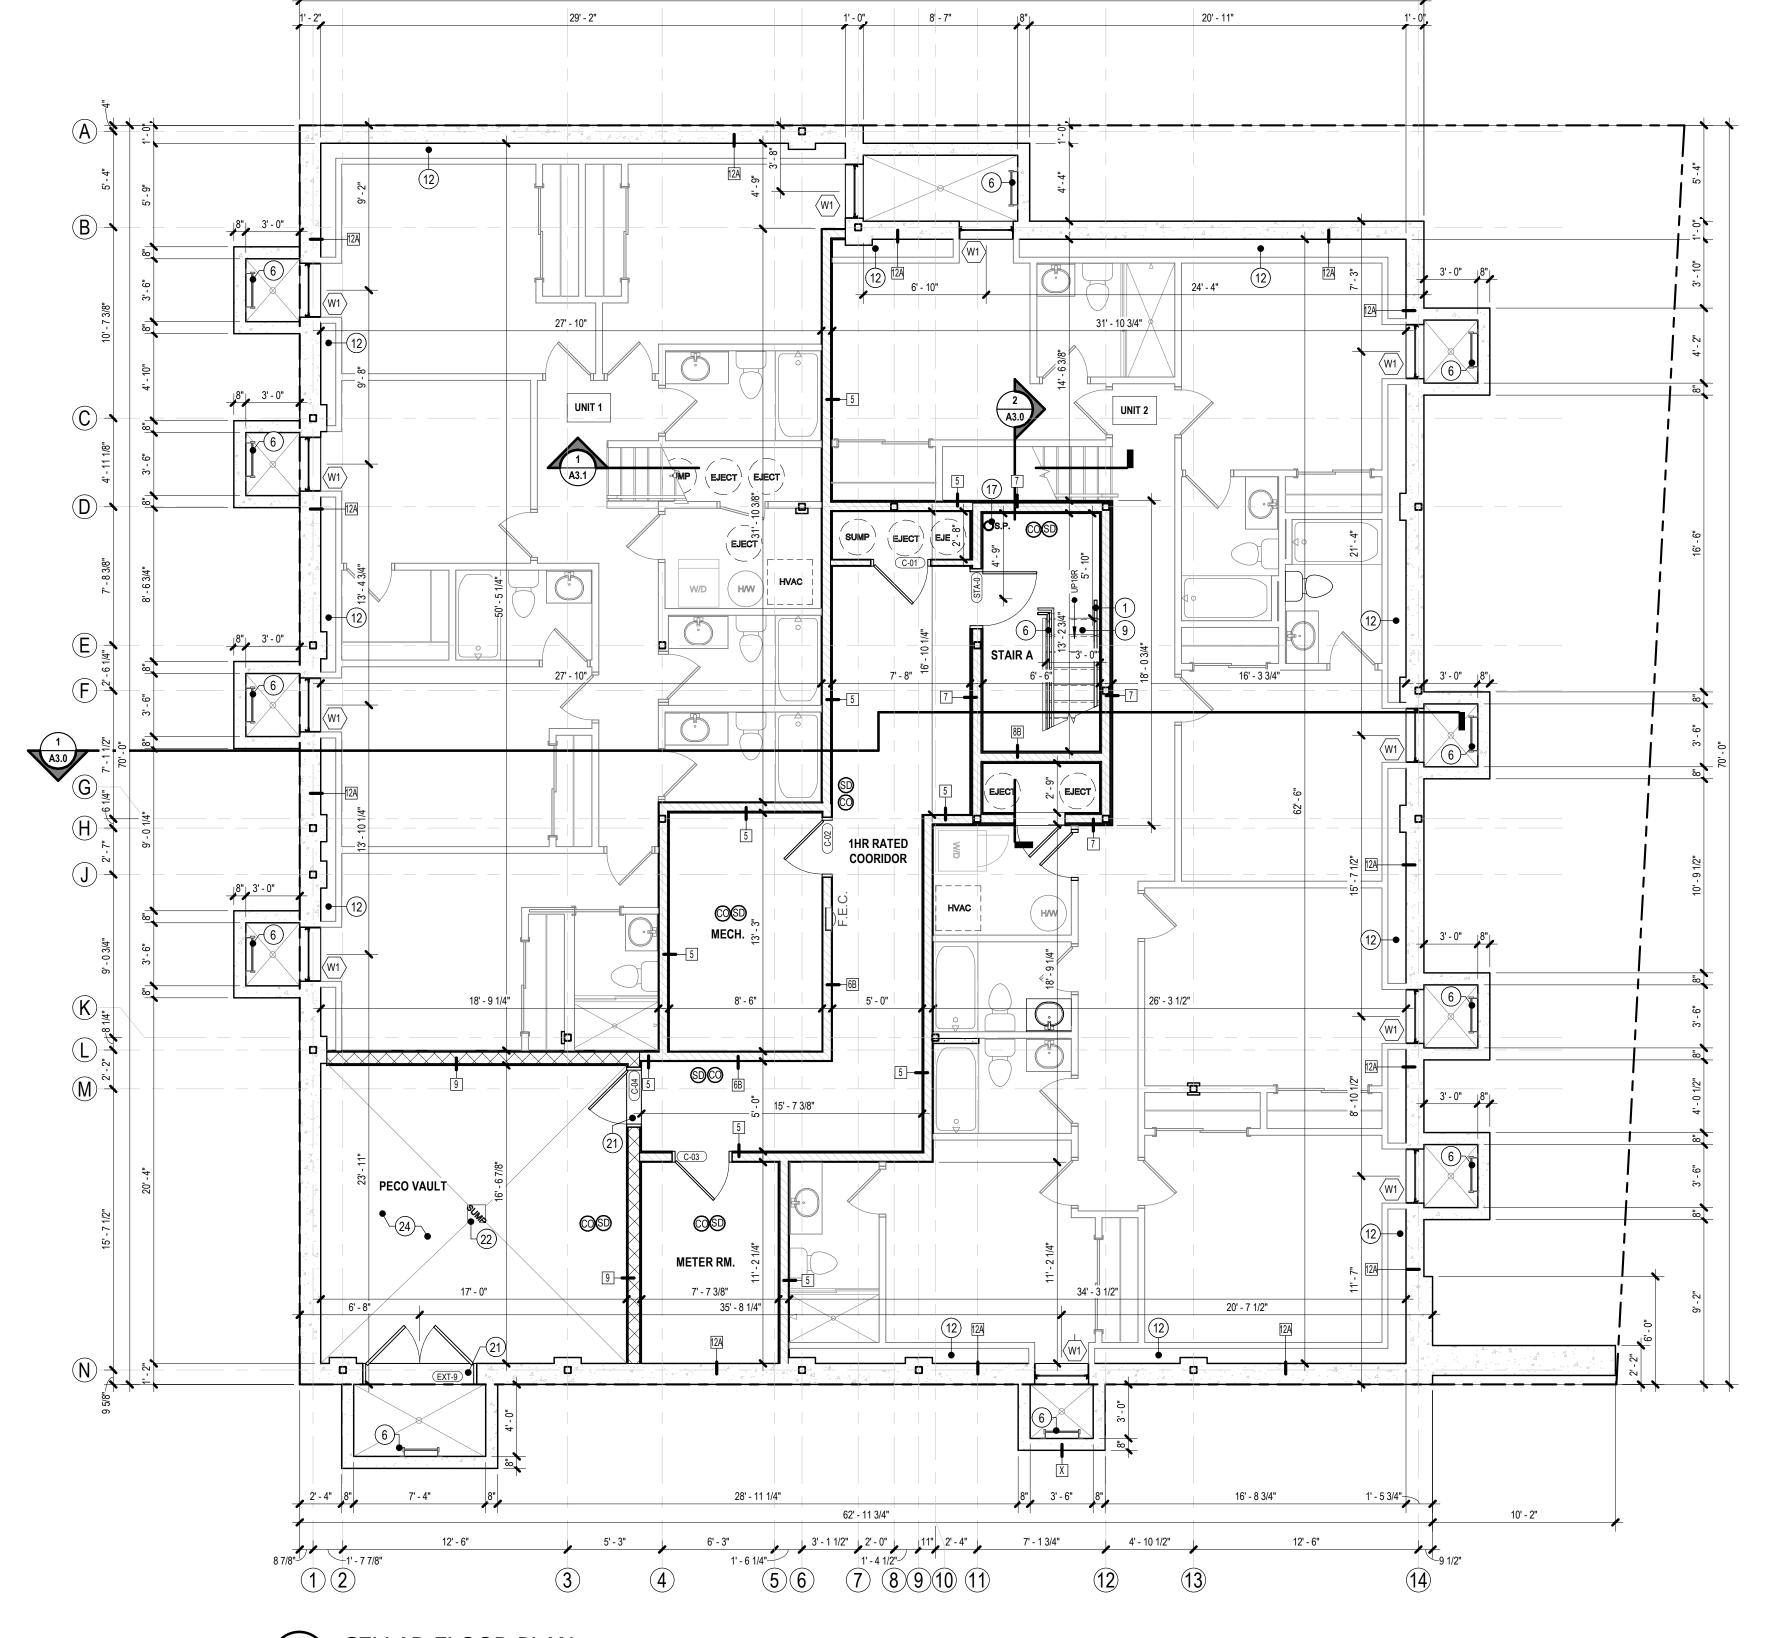

CELLAR FLOOR PLAN

3/16" = 1'-0"

Gnome Architects LLC 1901 s. 9th st. Rm. 526 Philadelphia PA 19148

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P: 215 279 7531

STRUCTURAL ENGINEER STRUCTURE LABS 470 Boot Rd Downingtown, PA 19335

<u>OWNER</u>

(484) 467-7413

3401 HAMILTON LLC

<u>_</u>

REVISIONS REV# DATE DESCRIPTION

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CHECKED BY: PROJECT NUMBER:

> DRAWING TITLE **CELLAR FLOOR PLAN**

> > DRAWING NO.

A1.0

95% PROGRESS SET - 11.08.2022

GENERAL PLAN NOTES	PAR	TITION TYPE REFER	ENCE
REFER TO STRUCTURAL DRAWINGS FOR BRACED WALL PANEL DETAIL INFORMATION. ALL NEW PARTITIONS ARE DIMENSIONED TO FACE OF WALL FINISH. NOTIFY ARCHITECT OF ANY FRAMING DISCREPANCIES BETWEEN STRUCTURAL AND ARCHITECTURAL	WALL TYPE 1 -EXTERIOR BRICK WALL -1HR INTERIOR RATING ONLY	WALL TYPE 6A/6B -INTERIOR STUD WALL -1HR RATING	WALL TYPE 11A/11B - INTERIOR STUD WALL - NON RATED
PLANS. 3. UNTAGGED WALLS ARE TYP. 2x4 NON RATED INTERIOR WALLS. REFER TO PARTITION TYPES FOR ADDITIONAL INFORMAITON.	WALL TYPE 2 -EXTERIOR LAP SIDING WALL -1HR INTERIOR RATING ONLY	WALL TYPE 7 -INTERIOR STUD WALL -2 HR RATING	WALL TYPE 12A/12B - EXTERIOR SUBGRADE WALL - NON RATED
REFER TO OVERALL PLANS AND ELEVATIONS FOR WINDOWS. UNIT WINDOW LOCATIONS MAY VARY ACROSS FLOORS.	WALL TYPE 3 -EXTERIOR LAP SIDING WALL -1HR RATED (BOTH SIDES)	WALL TYPE 8A/8B -INTERIOR STUD WALL -2 HR RATING	WALL TYPE 13 - INTERIOR STUD WALL - 1 HR RATING
PLAN SYMBOL LEGEND	WALL TYPE 4 -EXTERIOR METAL PANEL WALL	WALL TYPE 9 -INTERIOR C.M.U WALL	WALL TYPE 14 -EXTERIOR LAP SIDING WALL
X WINDOW TAG	-1HR INTERIOR RATING ONLY	-3 HR RATING	- 2 HR RATING
# PARTITION TAG	WALL TYPE 5 -INTERIOR STUD WALL	WALL TYPE 10 -EXTERIOR BRICK PRIVACY WALL	
SMOKE DETECTOR	-1HR RATING		

9	EXHAUST FAN MIN. C.F.M. PER APPLICABLE CODE			
	◆──① KEYED PLAN NOTES			
MARK	DESCRIPTION			
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12	M.E.P. CHASE WALL SIZE & LOCATIONS TO BE COORDINATED w/ M.E.P. DRAWING REQUIREMENTS			
13	EMERGENCY ESCAPE LADDER PER IBC 1029.5.2 (SEE EGRESS WELL DETAIL)			
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15	THROUGH WALL SCUPPER & DOWNSPOUT: PROVIDE OVERFLOW IN ACCORDANCE W/ LOCAREQUIRMENTS			
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19	SLOPED METAL WRAPPED AWNING			
20	ENTRY FOB & INTERCOM			
21	4" MIN. DOOR CURB PER PECO REQUIREMENTS			
22	12X12 SUMP PUMP w. STL. GRATE PER PECO REQUIREMENTS			
23	HVAC ON RAISED PLATFORM w/ HOT WATER BELOW			
24	SLOPE FLOOR TO DRAIN			
25	LOW PARAPET - SEE DETAILS			
26	ADA COMMERCIAL BATHROOM PER 2017 ANSI STANDARDS - SEE DETAILS FOR REFERENCE			
27	CONDENSOR LOCATION, COORD. w/ HVAC REQ. UNDER SEPERATE PERMIT. PROVIDE PAD, DUNAGE, & FALL PROTECTION AS REQ.			
28	PREFAB METAL GRATE STAIR OVER FIBERGLASS DECK. MIN. TREAD DEPTH 11" MAX. RISER HGHT 7" V.I.F. RISER COUNT AS REQ'D			

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SMOKE DETECTOR

COOKING APPLIANCE.

				BU	JILDING DOOR S	SCHEDULE
Mark		DOOR				
	W	IDTH		1		
	FIRST LEAF	SECOND LEAF	HEIGHT	RATING	DOOR HARDWARE SET	COMMENTS
C-01	3' - 0"		6' - 8"		SET#9	
C-02	3' - 0"		7' - 0"	1/3HR	SET #7	
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J-09	3' - 0"		7' - 0"	1/3HR	SET#4	
J-10	3' - 0"		7' - 0"	1/3HR	SET#4	
J-11	3' - 0"		7' - 0"	1/3HR	SET#4	
J-12	3' - 0"		7' - 0"	1/3HR	SET #4	
J-13	3' - 0"		7' - 0"	1/3HR	SET #4	
J-14	3' - 0"		7' - 0"	1/3HR	SET#4	
J-15	3' - 0"		7' - 0"	1/3HR	SET#4	

	76' - 11 3/4" 62' - 6" BLDG. WIDTH	<u> </u>
54	31' - 4" 23' - 1" 8' - 1"	
B	W6 5 10 10 REF 2 WT EXT.1)	2-8"
To - 73/8"	UNIT 1 5BD/5BR 13 29'-8 1/2" 30'-3 1/2"	8 - 2 -
D	1HR SHARED ENTRY (D) (C) (A) (A) (A) (A) (A) (A) (A) (A) (A) (A	8 - 0"
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39 - 8" (M) (M) (M) (M) (M) (M) (M) (M	60'-11"	40' - 10"
15' - 7 12"	2HR VACANT COMMERICAL SPACE 10'-8 1/4" REAR YARD	
	3' GATE (PER OWNER) W2 W2 W1 W2 W1 W2 W2 W2 W3 W4 W5 W4 W5 W5 W6 W6 W7 W7 W7 W7 W7 W7 W7 W7	
7' - 2 1/8"	16' - 0" 8' - 0" 8' - 0" 62' - 6" BLDG. WIDTH 73' - 2 1/4" PROP. PER DEED 5' - 3" 7' - 9 1/4" 3' - 1 1/2" 2' - 0" 11" 2' - 4" 7' - 1 3/4" 4' - 10 1/2" 12' - 6"	
1 2 FIRST FLOOR P 3/16" = 1'-0"		

Gnome Architects LLC 1901 s. 9th st. Rm. 526 Philadelphia PA 19148

gnomearch.com

P: 215 279 7531

STRUCTURAL ENGINEER STRUCTURE LABS 470 Boot Rd Downingtown, PA 19335 (484) 467-7413

<u>OWNER</u>

3401 HAMILTON LLC

HAMILTON MULTIPLEX
3401 HAMILTON AVE.
PHIILADELPHIA PA, 19104

REVISIONS REV# DATE DESCRIPTION **ISSUE DATE**

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Gnome Architects LLC

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CHECKED BY:

PROJECT NUMBER: DRAWING TITLE

DRAWING NO.

FIRST FLOOR PLAN

A1.1

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PLAN SYMBOL LEGEND

\ <u>`</u>	WINDOW TAG
[#] 	PARTITION TAG


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9	MIN. C.F.M. PER APPLICABLE CODE

	•—1 KEYED PLAN NOTES			
MARK	DESCRIPTION			
1	PROVIDE 36" CONTINIOUS HANDRAIL ON BOTH SIDES OF STEPS. HANDRAIL SHALL EXTEND/WRAP 1' PAST LAST RISER PER 1014.6 OF THE I.B.C.			
2	PROVIDE 36" CONTINIOUS HANDRAIL AT ALL STEPS			
3	PROVIDE 42" PARAPET/ GAURDRAIL (TYP.) FROM HIGHEST POINT OF ROOF SURFACE; INCLUDING ALL RIDGES & CRICKETS			
4	FIBERGLASS ROOF MEMBRANE SYSTEM w/CLASS B (MIN) ROOF COVERING OVER ROOF STRUCTURE AS PER DETAILS			
5	PROVIDE F.R.T. PLYWOOD 4'-0" MIN. OFF PROPERTY LINE			
6	42" GAURDRAIL - REFER TO GENERAL NOTES FOR GAURDRAIL REQUIREMENTS			
7	PROVIDE 1:48 SLOPED CRICKET: VALLEY TO HAVE 1:96 MIN SLOPE (TYP.)			
8	MIN. TREAD DEPTH 9" MAX. RISER HGHT 8" V.I.F. RISER COUNT AS REQ'D			
9	MIN. TREAD DEPTH 11" MAX. RISER HGHT 7" V.I.F. RISER COUNT AS REQ'D			
10	EGRESS WELL W/ WALKABLE FLUSH GRATE AS PER DETAIL			
11	PROVIDE HARD DUCTED DRYER EXHAUST SYSTEM IN ACCORDANCE WITH IMC 2018 REQUIREMENTS			
12	M.E.P. CHASE WALL SIZE & LOCATIONS TO BE COORDINATED w/ M.E.P. DRAWING REQUIREMENTS			
13	EMERGENCY ESCAPE LADDER PER IBC 1029.5.2 (SEE EGRESS WELL DETAIL)			
14	INTERNAL ROOF DRAIN: PROVIDE OVERFLOW IN ACCORDANCE WITH LOCAL CODE REQUIREMNETS			
15	THROUGH WALL SCUPPER & DOWNSPOUT: PROVIDE OVERFLOW IN ACCORDANCE W/ LOC. REQUIRMENTS			
16	PROVIDE SWING GATE IN ACCORDANCE WITH IBC SECTION 1023.8			
17	PROVIDE STANDPIPE IN ACCORDANCE IBC SECTION 905.3.1			
18	ACCESSIBLE PRIMARY ENTRACE. PROVIDE MAX 1/2" THRESHOLD IN ACCORDANCE W/ ICC A117.1-2021, SECTION 1004.11.1			
19	SLOPED METAL WRAPPED AWNING			
20	ENTRY FOB & INTERCOM			
21	4" MIN. DOOR CURB PER PECO REQUIREMENTS			
22	12X12 SUMP PUMP w. STL. GRATE PER PECO REQUIREMENTS			
23	HVAC ON RAISED PLATFORM w/ HOT WATER BELOW			
24	SLOPE FLOOR TO DRAIN			
25	LOW PARAPET - SEE DETAILS			
26	ADA COMMERCIAL BATHROOM PER 2017 ANSI STANDARDS - SEE DETAILS FOR REFERENC			
27	CONDENSOR LOCATION, COORD. w/ HVAC REQ. UNDER SEPERATE PERMIT. PROVIDE PAD, DUNAGE, & FALL PROTECTION AS REQ.			
28	PREFAB METAL GRATE STAIR OVER FIBERGLASS DECK. MIN. TREAD DEPTH 11" MAX. RISEI HGHT 7" V.I.F. RISER COUNT AS REQ'D			

PARTITION TYPE REFERENCE					
WALL TYPE 1 -EXTERIOR BRICK WALL -1HR INTERIOR RATING ONLY	WALL TYPE 6A/6B -INTERIOR STUD WALL -1HR RATING	WALL TYPE 11A/11B - INTERIOR STUD WALL - NON RATED			
WALL TYPE 2 -EXTERIOR LAP SIDING WALL -1HR INTERIOR RATING ONLY	WALL TYPE 7 -INTERIOR STUD WALL -2 HR RATING	WALL TYPE 12A/12B - EXTERIOR SUBGRADE WALL - NON RATED			
WALL TYPE 3 -EXTERIOR LAP SIDING WALL -1HR RATED (BOTH SIDES)	WALL TYPE 8A/8B -INTERIOR STUD WALL -2 HR RATING	WALL TYPE 13 - INTERIOR STUD WALL - 1 HR RATING			
WALL TYPE 4 -EXTERIOR METAL PANEL WALL -1HR INTERIOR RATING ONLY	WALL TYPE 9 -INTERIOR C.M.U WALL -3 HR RATING	WALL TYPE 14 -EXTERIOR LAP SIDING WALL - 2 HR RATING			
WALL TYPE 5 -INTERIOR STUD WALL -1HR RATING	WALL TYPE 10 -EXTERIOR BRICK PRIVACY WALL				

				DI	IILDING DOOR S	CHEDIII E
	T	2002		DU	ILDING DOOK 3	OCHEDULE
		DOOR				
	l l	WIDTH				
Mark	FIRST LEAF	F SECOND LEAF	HEIGHT	RATING	DOOR HARDWARE SET	COMMENTS
C-01	3' - 0"		6' - 8"		SET#9	
C-02	3' - 0"		7' - 0"	1/3HR	SET #7	
C-03	3' - 0"		7' - 0"	1/3HR	SET #7	
C-04	3' - 0"		7' - 0"	3HR	SET #7	
C-05	3' - 0"		7' - 0"	1/3HR	SET #5	
C-06	3' - 0"		7' - 0"	1/3HR	SET #5	
C-07	3' - 0"		6' - 8"		SET #10	
EXT-1	3' - 0"		7' - 0"		SET #2	
EXT-2	3' - 0"		7' - 0"		SET #1	
EXT-3	3' - 0"	3' - 0"	8' - 6"		SET#3	
EXT-4	3' - 0"		8' - 6"		SET #1	
EXT-5	3' - 0"		8' - 6"		SET#1	
EXT-6	3' - 0"		8' - 6"		SET #2	
EXT-7	2' - 6"		7' - 0"		SET#8	
EXT-8	2' - 6"		7' - 0"		SET#8	
EXT-9	3' - 0"	3' - 0"	7' - 0"		SET#6	
STA-0	3' - 0"		7' - 0"	90 MIN	SET #5	
STA-1	3' - 0"		7' - 0"	90 MIN	SET #5	
STA-2	3' - 0"		7' - 0"	90 MIN	SET#5	
STA-3	3' - 0"		7' - 0"	90 MIN	SET#5	
STA-4	3' - 0"		7' - 0"	90 MIN	SET#5	
STB-2	3' - 0"		7' - 0"	90 MIN	SET#5	
STB-3	3' - 0"		7' - 0"	90 MIN	SET#5	
STB-4	3' - 0"		7' - 0"	90 MIN	SET #5	
U-01	3' - 0"		7' - 0"	1/3HR	SET#4	
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U-10	3' - 0"		7' - 0"	1/3HR	SET#4	
U-11	3' - 0"		7' - 0"	1/3HR	SET#4	
U-12	3' - 0"		7' - 0"	1/3HR	SET #4	
U-13	3' - 0"		7' - 0"	1/3HR	SET #4	
U-14	3' - 0"		7' - 0"	1/3HR	SET #4	
U-15	3' - 0"		7' - 0"	1/3HR	SET #4	

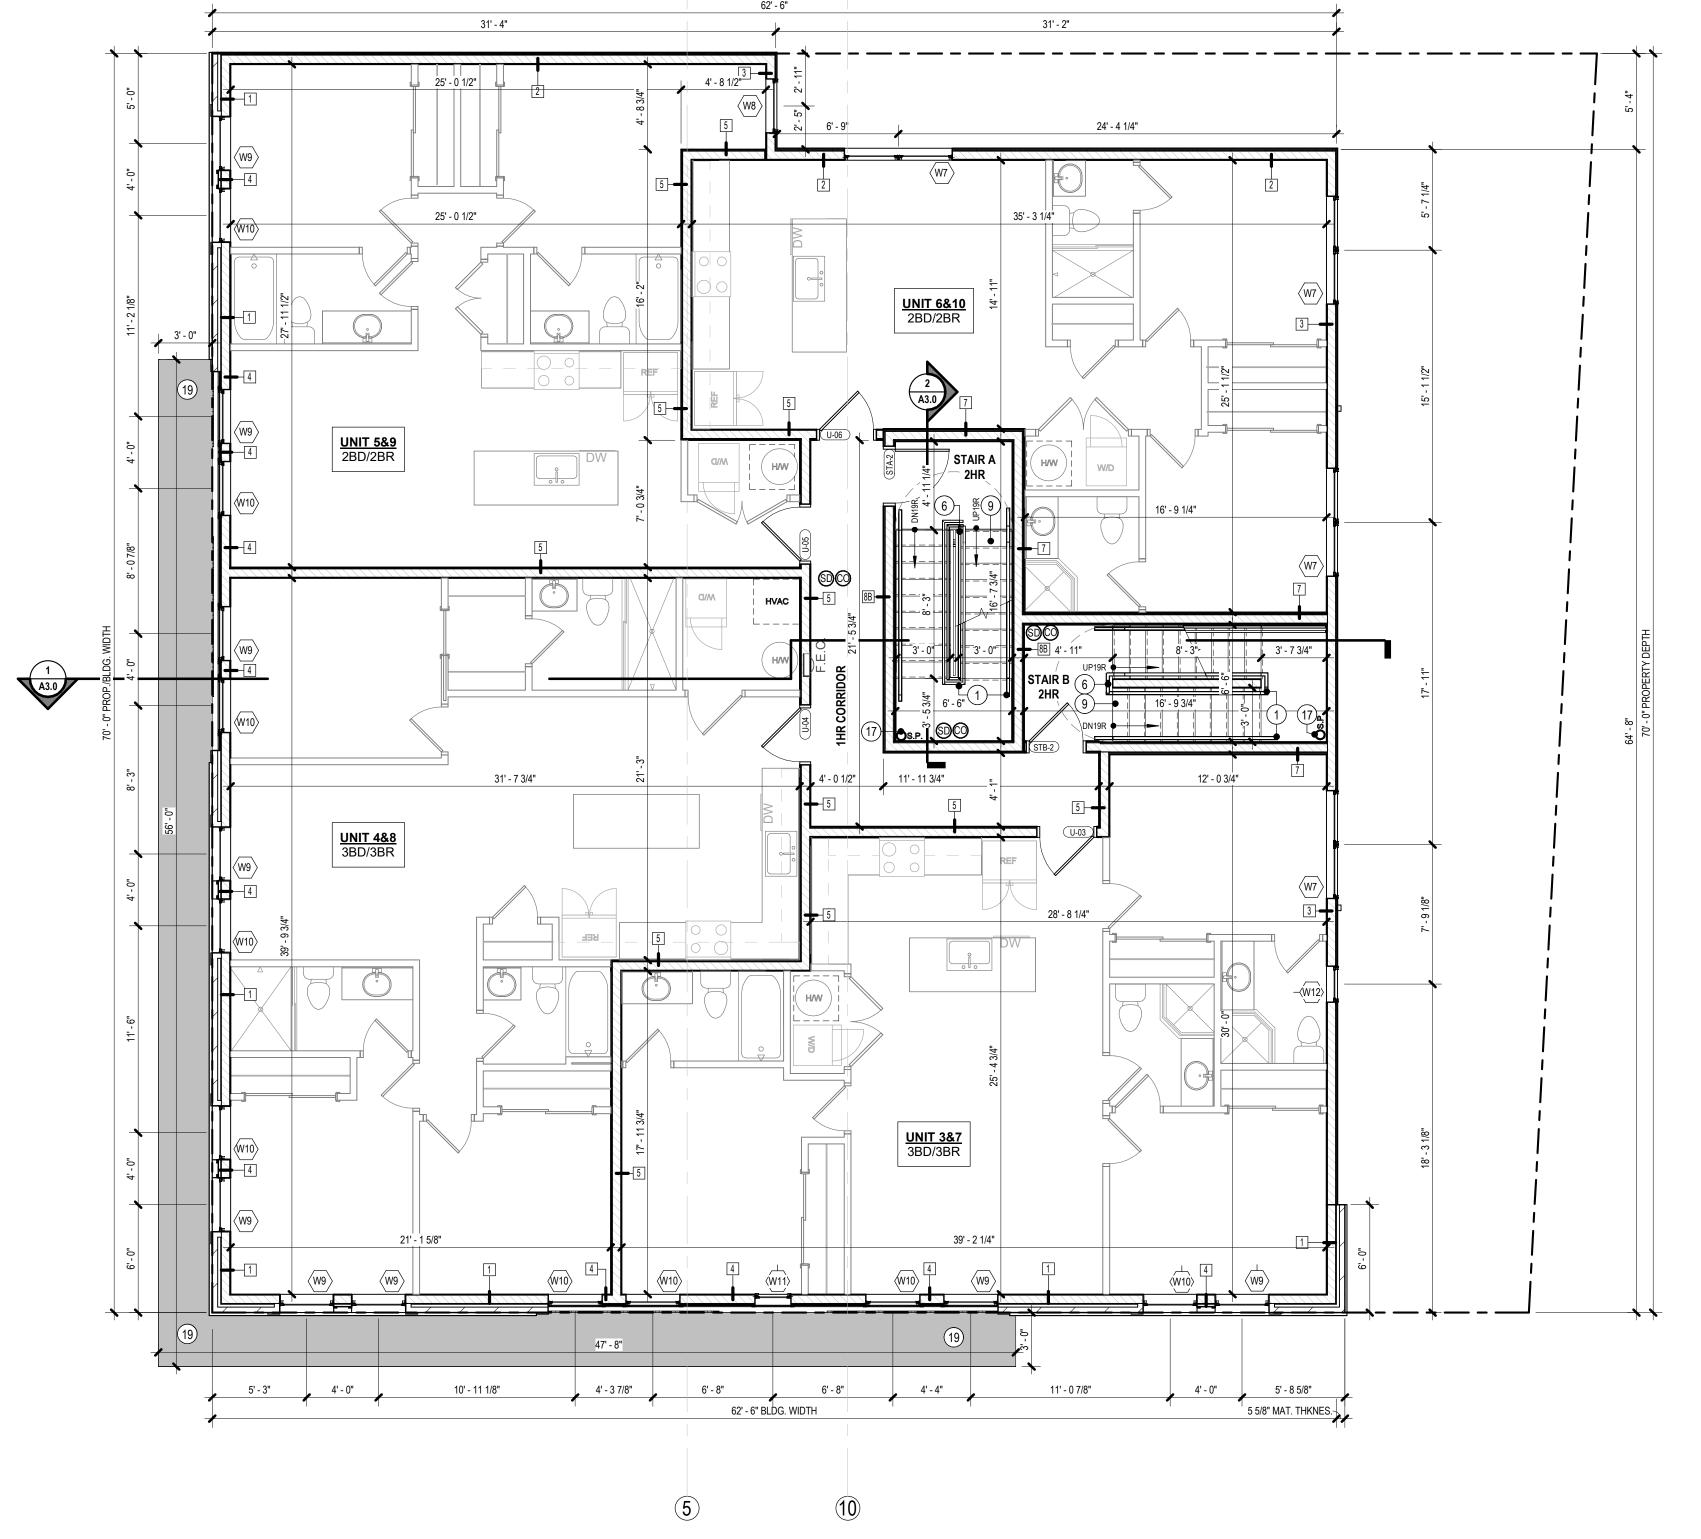

SECOND FLOOR

3/16" = 1'-0"

Gnome Architects LLC 1901 s. 9th st. Rm. 526 Philadelphia PA 19148

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<u>OWNER</u>

3401 HAMILTON LLC

REVISIONS REV# DATE DESCRIPTION **ISSUE DATE**

PROFESSIONAL SEAL

All ideas, designs, arrangements and plans indicated or represented by this drawing and written material appearing herein constitute the original and unpublished work of Gnome Architects LLC and the same may not be duplicated, used or disclosed to any person, firm or corporation for any purpose whatsoever without the written consent of the architect.

PROJECT NUMBER:

CHECKED BY:

DRAWING TITLE SECOND FLOOR PLAN

> DRAWING NO. A1.2

95% PROGRESS SET - 11.08.2022

- . REFER TO STRUCTURAL DRAWINGS FOR BRACED WALL PANEL DETAIL INFORMATION. 2. ALL NEW PARTITIONS ARE DIMENSIONED TO FACE OF WALL FINISH. NOTIFY ARCHITECT OF ANY FRAMING DISCREPANCIES BETWEEN STRUCTURAL AND ARCHITECTURAL
- 3. UNTAGGED WALLS ARE TYP. 2x4 NON RATED INTERIOR WALLS. REFER TO PARTITION TYPES FOR ADDITIONAL INFORMAITON.
- 4. REFER TO OVERALL PLANS AND ELEVATIONS FOR WINDOWS. UNIT WINDOW LOCATIONS MAY VARY ACROSS FLOORS.

PLAN SYMBOL LEGEND


$\langle \dot{x} \rangle$	WINDOW TAG
#	PARTITION TAG

- SMOKE DETECTOR ALL UNITS SHALL BE HARD WIRED W/BATTERY BACKUP AND INTERCONNECTED. SMOKE DETECTORS TO BE INSTALLED IN EACH BEDROOM, HALL AREA, AND IN THE IMMEDIATE VICINITY OF BEDROOMS AND ON EACH FLOOR OF THE DWELLING.
- REQUIRED WITHIN 15 FEET OF THE ENTRANCE TO EVERY BEDROOM OR WITHIN 15 FEET OF A BED IN SLEEPING AREAS WHERE THERE IS NO ENCLOSED BEDROOM.
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 DIRECTLY IN FRONT OF A DOOR TO A BATHROOM OR WITHIN 5 FEET OF A
- **EXHAUST FAN**
- MIN. C.F.M. PER APPLICABLE CODE

	•—1 KEYED PLAN NOTES
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				BL	IILDING DOOR SCHEDU	LE
		DOOR				
	WIDTH					
Mark	FIRST LEAF	SECOND LEAF	HEIGHT	RATING	DOOR HARDWARE SET	COMMENTS
C-01	3' - 0"		6' - 8"		SET#9	
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U-14	3' - 0"		7' - 0"	1/3HR	SET#4	
U-15	3' - 0"		7' - 0"	1/3HR	SET#4	



THIRD FLOOR PLAN

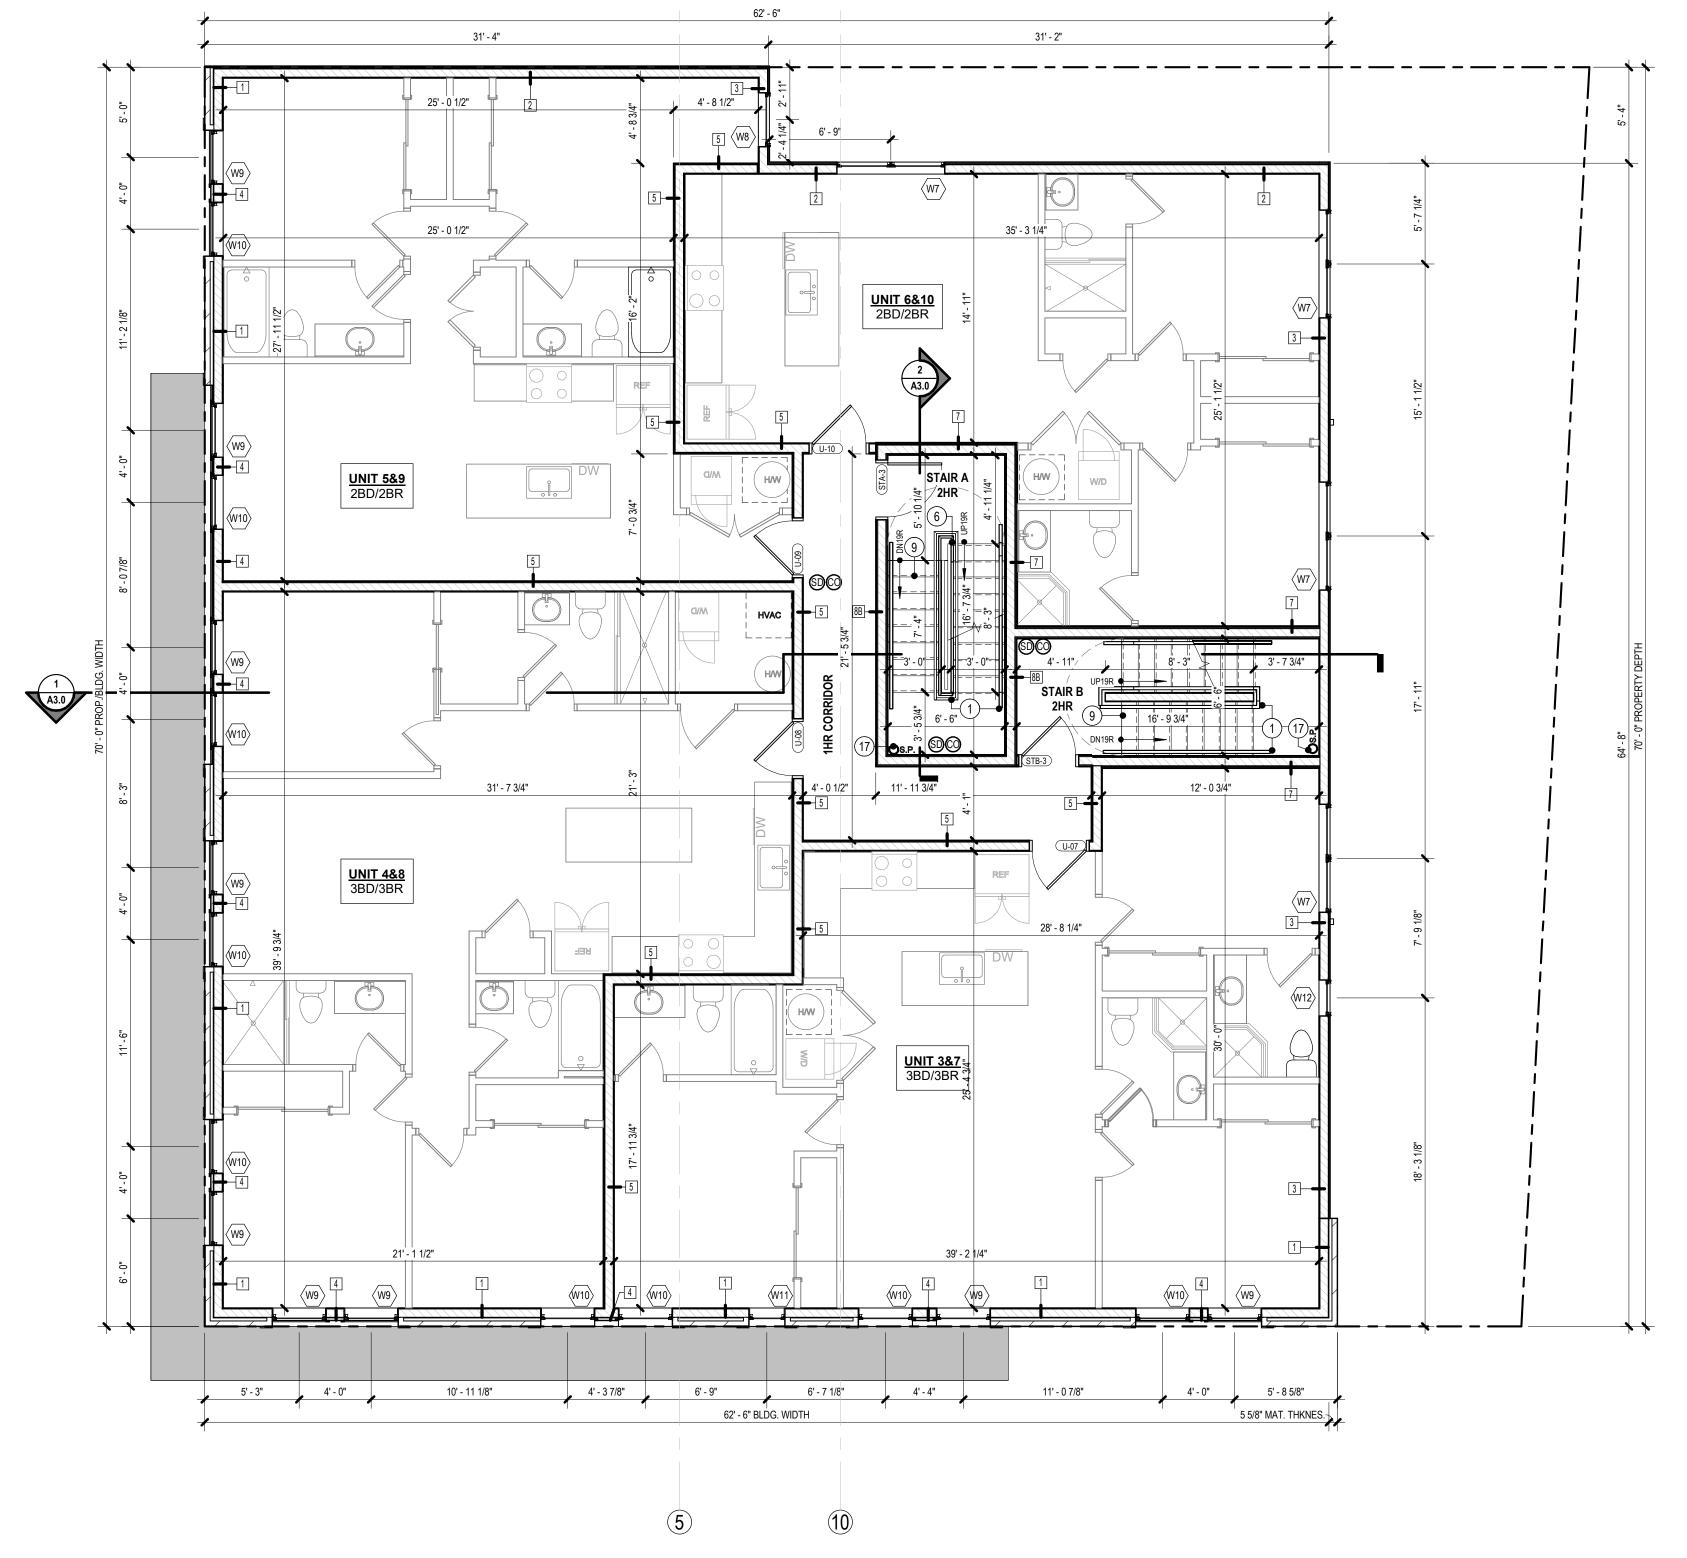3/16" = 1'-0"

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REVISIONS REV# DATE DESCRIPTION **ISSUE DATE**

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CHECKED BY: PROJECT NUMBER:

> **DRAWING TITLE** THIRD FLOOR PLAN

> > DRAWING NO.

A1.3

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LOCATIONS MAY VARY ACROSS FLOORS. PLAN SYMBOL LEGEND

(x)	WINDOW TAG
#	PARTITION TAG


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				BL	IILDING DOOR S	CHEDULE
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U-10 U-11	3' - 0"		7' - 0"	1/3HR	SET #4	
J-11 J-12	3' - 0"		7' - 0"	1/3HR	SET #4	
J-12 J-13	3' - 0"		7' - 0"	1/3HR 1/3HR	SET #4	
J-13 J-14	3' - 0"		7' - 0"	1/3HR 1/3HR	SET #4	
U-14 U-15	3' - 0"		7' - 0"	1/3HR 1/3HR	SET #4	



FOURTH FLOOR PLAN

3/16" = 1'-0"

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<u>OWNER</u>

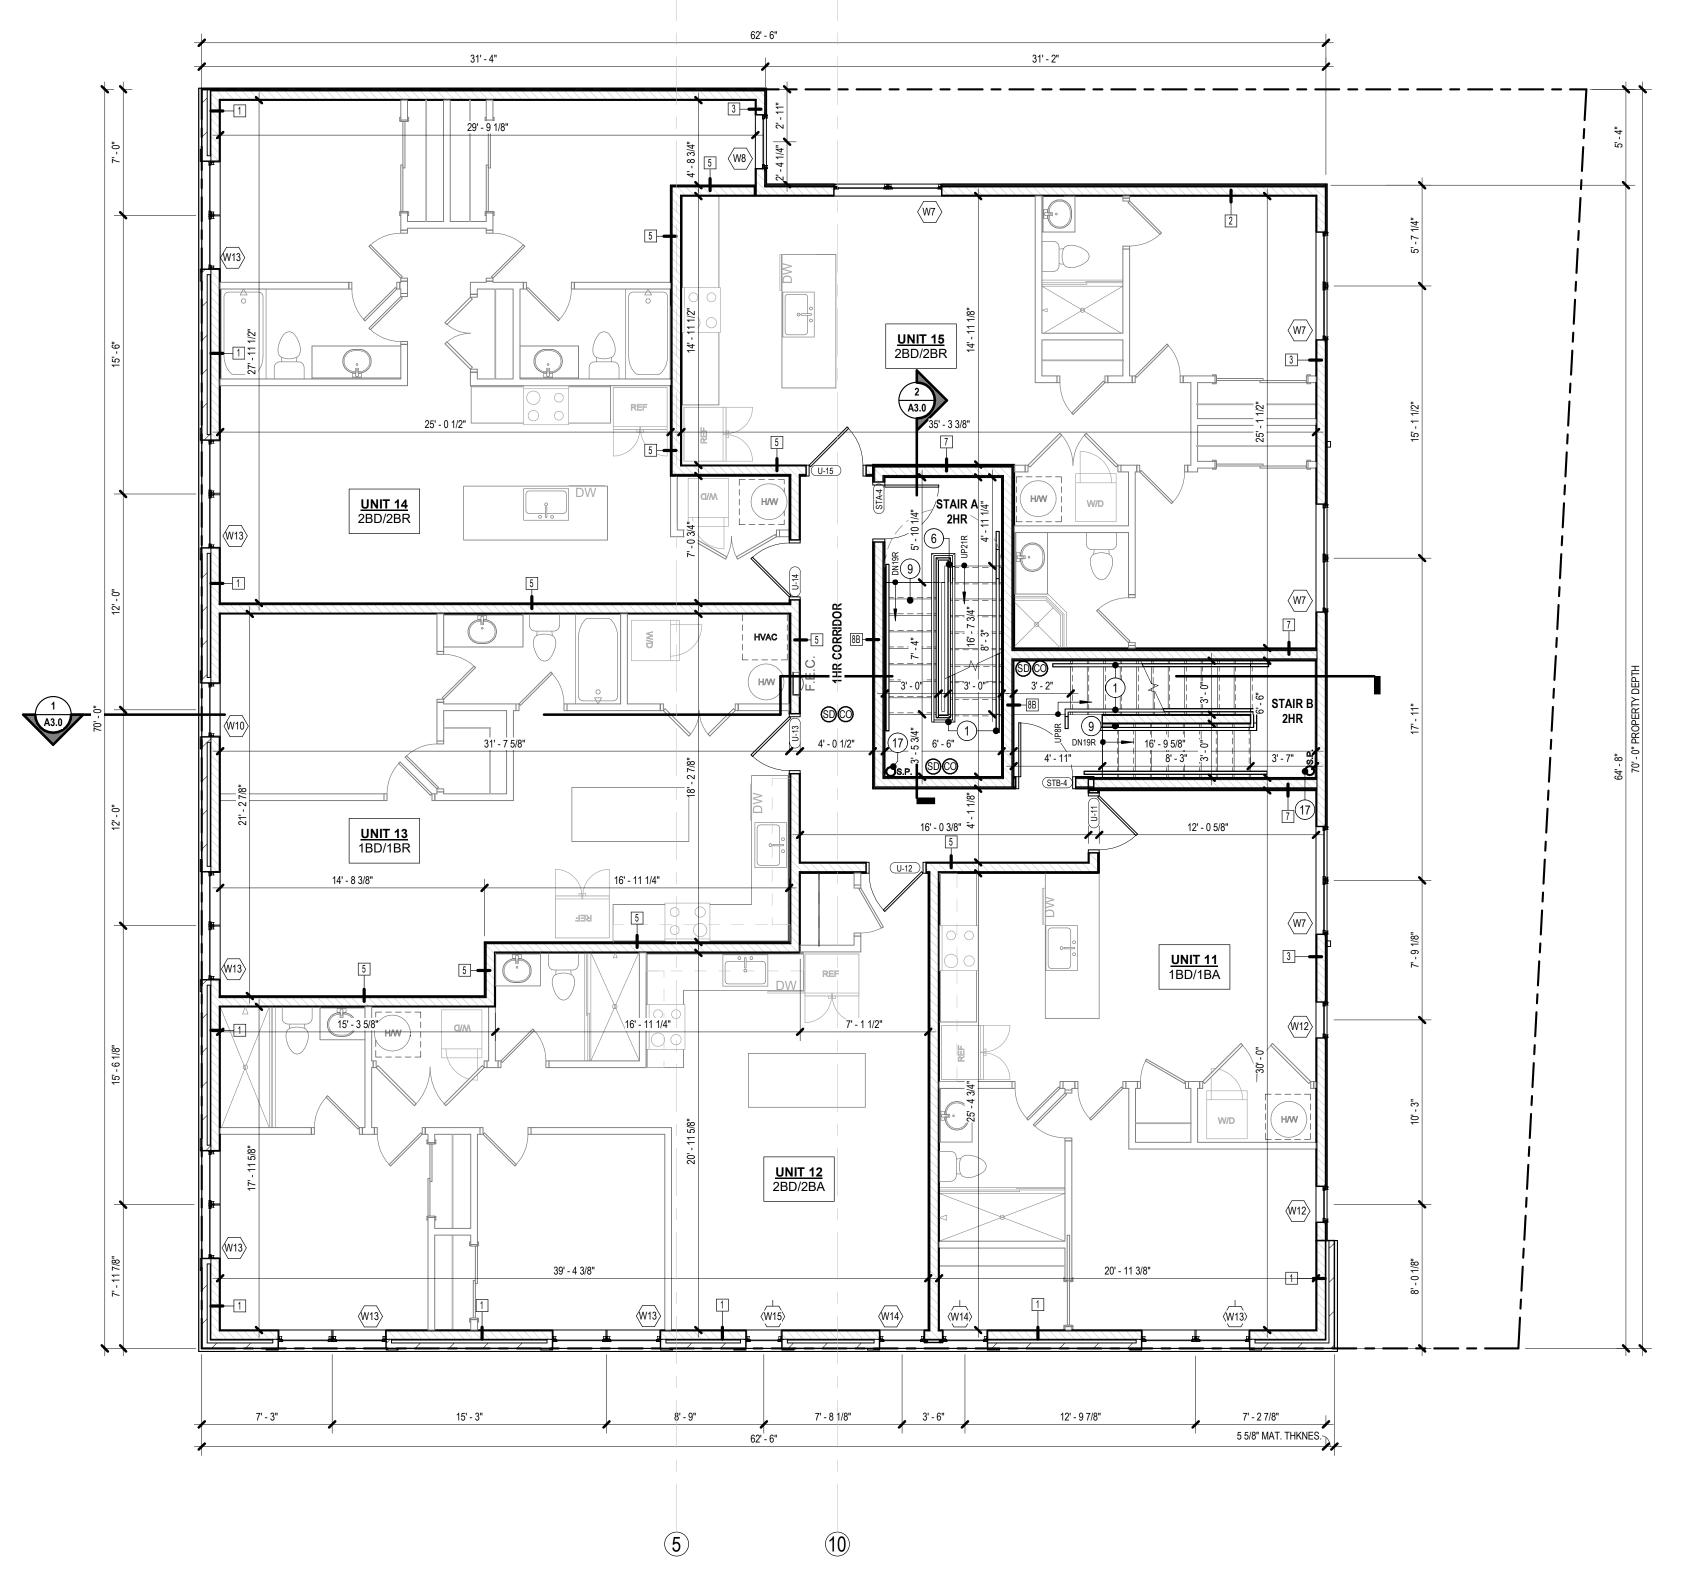3401 HAMILTON LLC

REVISI	IONS		
REV#	DATE	DESCRIPTION	
ROJEC	T ISSUE	ISSUE DATE	
D SET		2022.11.02	

PROFESSIONAL SEAL

PROJECT NUMBER:

All ideas, designs, arrangements and plans indicated or represented by this drawing and written material appearing

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> **DRAWING TITLE FOURTH FLOOR PLAN**

> > DRAWING NO.

A1.4

GENERAL PLAN NOTES 1. REFER TO STRUCTURAL DRAWINGS FOR BRACED WALL PANEL DETAIL INFORMATION. 2. ALL NEW PARTITIONS ARE DIMENSIONED TO FACE OF WALL FINISH. NOTIFY ARCHITECT OF ANY FRAMING DISCREPANCIES BETWEEN STRUCTURAL AND ARCHITECTURAL

PLANS.

3. UNTAGGED WALLS ARE TYP. 2x4 NON RATED INTERIOR WALLS. REFER TO PARTITION TYPES FOR ADDITIONAL INFORMAITON.

TYPES FOR ADDITIONAL INFORMAITON.

4. REFER TO OVERALL PLANS AND ELEVATIONS FOR WINDOWS. UNIT WINDOW LOCATIONS MAY VARY ACROSS FLOORS.

PLAN SYMBOL LEGEND

$\langle x \rangle$	WINDOW TAG
#	PARTITION TAG

SD SMOKE DETECTOR
ALL UNITS SHALL BE HARD WIRED W/BATTERY BACKUP AND INTERCONNECTED.
SMOKE DETECTORS TO BE INSTALLED IN EACH BEDROOM, HALL AREA, AND IN
THE IMMEDIATE VICINITY OF BEDROOMS AND ON EACH FLOOR OF THE DWELLING.

CARBON MONOXIDE DETECTOR

REQUIRED WITHIN 15 FEET OF THE ENTRANCE TO EVERY BEDROOM OR WITHIN 15
FEET OF A BED IN SLEEPING AREAS WHERE THERE IS NO ENCLOSED BEDROOM.


IT SHALL BE CENTRALLY LOCATED OR ON A WALL OR THE CEILING BUT NOT
DIRECTLY IN FRONT OF A DOOR TO A BATHROOM OR WITHIN 5 FEET OF A
COOKING APPLIANCE


EXHAUST FAN
MIN. C.F.M. PER APPLICABLE CODE

	•—1 KEYED PLAN NOTES
MARK	DESCRIPTION
1	PROVIDE 36" CONTINIOUS HANDRAIL ON BOTH SIDES OF STEPS. HANDRAIL SHALL EXTEND/WRAP 1' PAST LAST RISER PER 1014.6 OF THE I.B.C.
2	PROVIDE 36" CONTINIOUS HANDRAIL AT ALL STEPS
3	PROVIDE 42" PARAPET/ GAURDRAIL (TYP.) FROM HIGHEST POINT OF ROOF SURFACE; INCLUDING ALL RIDGES & CRICKETS
4	FIBERGLASS ROOF MEMBRANE SYSTEM w/CLASS B (MIN) ROOF COVERING OVER ROOF STRUCTURE AS PER DETAILS
5	PROVIDE F.R.T. PLYWOOD 4'-0" MIN. OFF PROPERTY LINE
6	42" GAURDRAIL - REFER TO GENERAL NOTES FOR GAURDRAIL REQUIREMENTS
7	PROVIDE 1:48 SLOPED CRICKET: VALLEY TO HAVE 1:96 MIN SLOPE (TYP.)
8	MIN. TREAD DEPTH 9" MAX. RISER HGHT 8" V.I.F. RISER COUNT AS REQ'D
9	MIN. TREAD DEPTH 11" MAX. RISER HGHT 7" V.I.F. RISER COUNT AS REQ'D
10	EGRESS WELL W/ WALKABLE FLUSH GRATE AS PER DETAIL
11	PROVIDE HARD DUCTED DRYER EXHAUST SYSTEM IN ACCORDANCE WITH IMC 2018 REQUIREMENTS
12	M.E.P. CHASE WALL SIZE & LOCATIONS TO BE COORDINATED w/ M.E.P. DRAWING REQUIREMENTS
13	EMERGENCY ESCAPE LADDER PER IBC 1029.5.2 (SEE EGRESS WELL DETAIL)
14	INTERNAL ROOF DRAIN: PROVIDE OVERFLOW IN ACCORDANCE WITH LOCAL CODE REQUIREMNETS
15	THROUGH WALL SCUPPER & DOWNSPOUT: PROVIDE OVERFLOW IN ACCORDANCE W/ LO REQUIRMENTS
16	PROVIDE SWING GATE IN ACCORDANCE WITH IBC SECTION 1023.8
17	PROVIDE STANDPIPE IN ACCORDANCE IBC SECTION 905.3.1
18	ACCESSIBLE PRIMARY ENTRACE. PROVIDE MAX 1/2" THRESHOLD IN ACCORDANCE W/ ICC A117.1-2021, SECTION 1004.11.1
19	SLOPED METAL WRAPPED AWNING
20	ENTRY FOB & INTERCOM
21	4" MIN. DOOR CURB PER PECO REQUIREMENTS
22	12X12 SUMP PUMP w. STL. GRATE PER PECO REQUIREMENTS
23	HVAC ON RAISED PLATFORM w/ HOT WATER BELOW
24	SLOPE FLOOR TO DRAIN
25	LOW PARAPET - SEE DETAILS
26	ADA COMMERCIAL BATHROOM PER 2017 ANSI STANDARDS - SEE DETAILS FOR REFEREN
27	CONDENSOR LOCATION, COORD. w/ HVAC REQ. UNDER SEPERATE PERMIT. PROVIDE PADUNAGE, & FALL PROTECTION AS REQ.
28	PREFAB METAL GRATE STAIR OVER FIBERGLASS DECK. MIN. TREAD DEPTH 11" MAX. RIS HGHT 7" V.I.F. RISER COUNT AS REQ'D

				BU	IILDING DOOR S	SCHEDULE
		DOOR				
	W	IDTH				
Mark	FIRST LEAF	SECOND LEAF	HEIGHT	RATING	DOOR HARDWARE SET	COMMENTS
C-01	3' - 0"		6' - 8"		SET#9	
C-02	3' - 0"		7' - 0"	1/3HR	SET #7	
C-03	3' - 0"		7' - 0"	1/3HR	SET #7	
C-04	3' - 0"		7' - 0"	3HR	SET #7	
C-05	3' - 0"		7' - 0"	1/3HR	SET #5	
C-06	3' - 0"		7' - 0"	1/3HR	SET #5	
C-07	3' - 0"		6' - 8"		SET #10	
EXT-1	3' - 0"		7' - 0"		SET #2	
EXT-2	3' - 0"		7' - 0"		SET #1	
EXT-3	3' - 0"	3' - 0"	8' - 6"		SET #3	
EXT-4	3' - 0"		8' - 6"		SET#1	
EXT-5	3' - 0"		8' - 6"		SET#1	
EXT-6	3' - 0"		8' - 6"		SET #2	
EXT-7	2' - 6"		7' - 0"		SET#8	
EXT-8	2' - 6"		7' - 0"		SET #8	
EXT-9		3' - 0"	7' - 0"		SET#6	
STA-0	3' - 0"		7' - 0"	90 MIN	SET #5	
STA-1	3' - 0"		7' - 0"	90 MIN	SET #5	
STA-2	3' - 0"		7' - 0"	90 MIN	SET #5	
STA-3	3' - 0"		7' - 0"	90 MIN	SET #5	
STA-4	3' - 0"		7' - 0"	90 MIN	SET #5	
STB-2	3' - 0"		7' - 0"	90 MIN	SET #5	
STB-3	3' - 0"		7' - 0"	90 MIN	SET #5	
STB-4	3' - 0"		7' - 0"	90 MIN	SET #5	
U-01	3' - 0"		7' - 0"	1/3HR	SET #4	
U-03	3' - 0"		7' - 0"	1/3HR	SET #4	
U-04	3' - 0"		7' - 0"	1/3HR	SET #4	
U-05	3' - 0"		7' - 0"	1/3HR	SET #4	
U-06	3' - 0"		7' - 0"	1/3HR	SET #4	
U-07	3' - 0"		7' - 0"	1/3HR	SET #4	
U-08	3' - 0"		7' - 0"	1/3HR	SET #4	
U-09	3' - 0"		7' - 0"	1/3HR	SET #4	
U-10	3' - 0"		7' - 0"	1/3HR	SET #4	
U-11	3' - 0"		7' - 0"	1/3HR	SET #4	
U-12	3' - 0"		7' - 0"	1/3HR	SET #4	
U-13	3' - 0"		7' - 0"	1/3HR	SET #4	
U-14	3' - 0"		7' - 0"	1/3HR	SET #4	
U-15	3' - 0"		7' - 0"	1/3HR	SET #4	

	PAR	TITION TYPE REFERI	ENCE
	WALL TYPE 1 -EXTERIOR BRICK WALL -1HR INTERIOR RATING ONLY	WALL TYPE 6A/6B -INTERIOR STUD WALL -1HR RATING	WALL TYPE 11A/11B - INTERIOR STUD WALL - NON RATED
	WALL TYPE 2 -EXTERIOR LAP SIDING WALL -1HR INTERIOR RATING ONLY	WALL TYPE 7 -INTERIOR STUD WALL -2 HR RATING	WALL TYPE 12A/12B - EXTERIOR SUBGRADE WALL - NON RATED
	WALL TYPE 3 -EXTERIOR LAP SIDING WALL -1HR RATED (BOTH SIDES)	WALL TYPE 8A/8B -INTERIOR STUD WALL -2 HR RATING	WALL TYPE 13 - INTERIOR STUD WALL - 1 HR RATING
-	WALL TYPE 4 -EXTERIOR METAL PANEL WALL -1HR INTERIOR RATING ONLY	WALL TYPE 9 -INTERIOR C.M.U WALL -3 HR RATING	WALL TYPE 14 -EXTERIOR LAP SIDING WALL - 2 HR RATING
	WALL TYPE 5 -INTERIOR STUD WALL -1HR RATING	WALL TYPE 10 -EXTERIOR BRICK PRIVACY WALL	

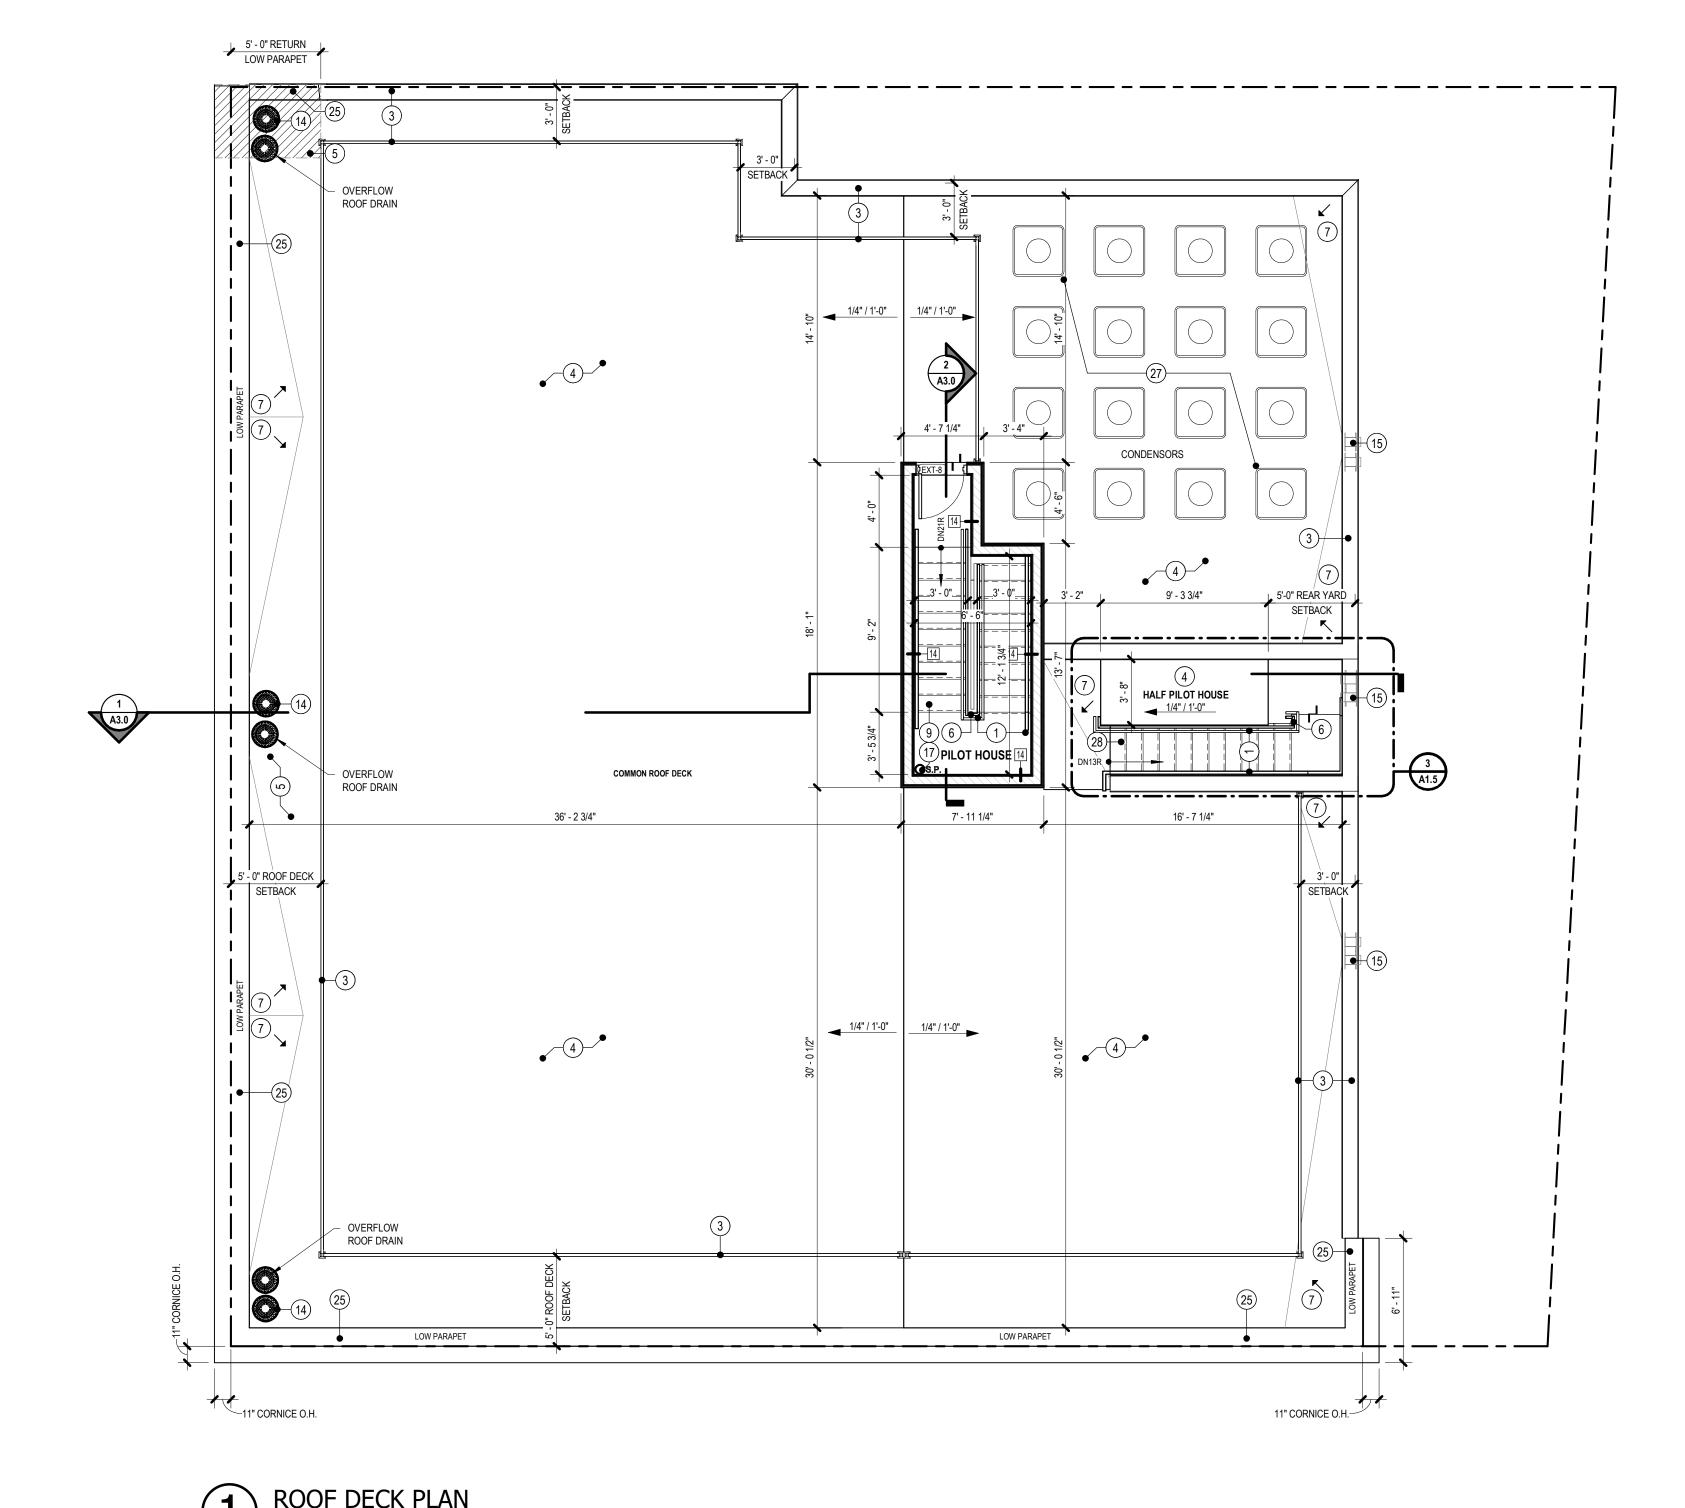

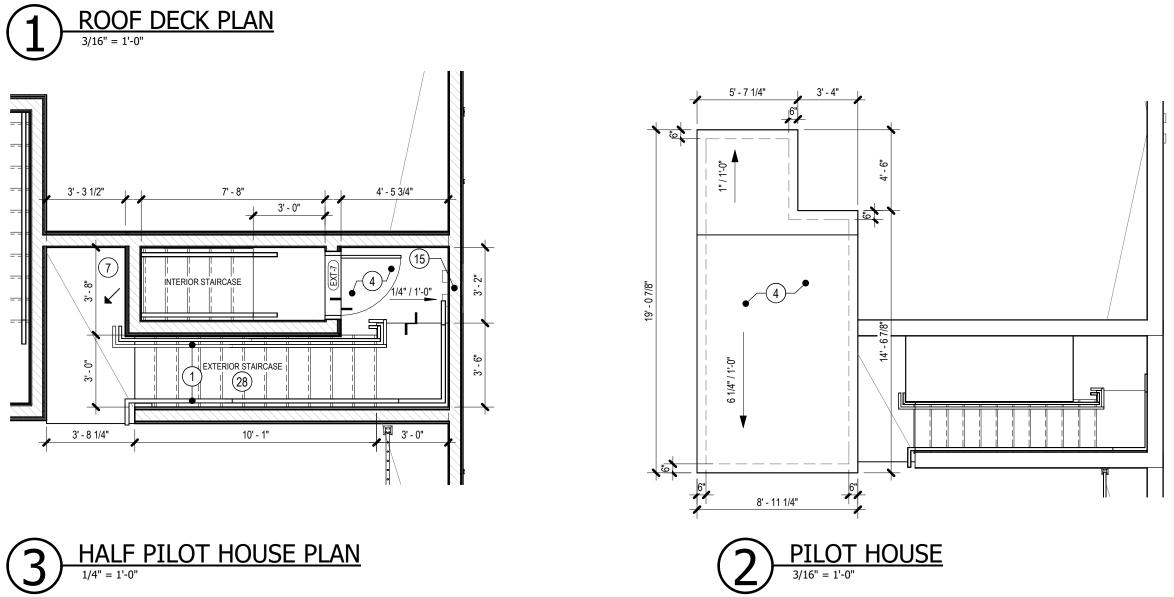

ANOME

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PROF	ESSION	AL SEAL
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ROOF DECK PLAN

DRAWING NO.

A1.5

IP AREA

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