ADDRESS: 700-02 AND 704 CHESTNUT ST

Proposal: Demolish building, construct addition

Review Requested: In Concept

Owner: 700 Chestnut Street Associates Applicant: Herb Schultz, Studio HS4

History: 1922; Washington Square Building; Magaziner, Eberhard & Harris

Individual Designation: None

District Designation: Chestnut Street East Historic District, Contributing, 11/12/2021

Staff Contact: Jon Farnham, jon.farnham@phila.gov

Overview: This application proposes the in-concept approval of the demolition of the building at 704 Chestnut Street and the construction of an addition to the building at 700-02 Chestnut Street. Currently, both buildings, at 700-02 and 704 Chestnut Street, are classified as contributing to the Chestnut Street East Historic District. In parallel with this application, the applicant is requesting that the Committee on Historic Designation and Historical Commission reclassify the property at 704 Chestnut Street as non-contributing to the historic district. If the Historical Commission declines to reclassify 704 Chestnut Street as non-contributing, then it cannot approve the demolition without a finding that the demolition is necessary in the public interest or that the building has no feasible reuse. The Architectural Committee should craft a recommendation for both scenarios, with the property at 704 Chestnut Street classified as contributing and non-contributing.

The addition would be constructed at 704 Chestnut Street and would extend onto the six-story historic building at 700-02 Chestnut Street. The addition would be 13 stories tall, with seven new stories on the six-story historic building. The historic building is 76'-4" tall to the roof. The enlarged building would be 160'-3" to the roof and 171'-7" to the top of the mechanical penthouse.

The nomination with inventory for the Chestnut Street East Historic District can be found at this link: https://www.phila.gov/media/20220112162008/Historic-District-Chestnut-St-East-Commercial.pdf

The application proposing the reclassification of the property at 704 Chestnut Street can be found at this link: https://www.phila.gov/media/20220714080821/704-Chestnut-St-reclassification.pdf

SCOPE OF WORK

- Demolish the three-story building at 704 Chestnut Street;
- Construct an addition to the building at 700-02 Chestnut Street.


STANDARDS FOR REVIEW:


The Secretary of the Interior's Standards for the Treatment of Historic Properties and Guidelines include:


- Standard 9: New additions, exterior alterations, or related new construction will not destroy historic materials, features, and spatial relationships that characterize the property. The new works shall be differentiated from the old and will be compatible with the historic materials, features, size, scale and proportion, and massing to protect the integrity of the property and its environment.
 - o If the building at 704 Chestnut Street is classified as contributing, the demolition of the building will destroy historic materials and features, and therefore will not satisfy Standard 9.


- If the addition is constructed, it will not be compatible with the historic materials, features, size, scale and proportion, and massing of the building at 700-02 Chestnut Street or the historic district as a whole and therefore will not protect the integrity of the property and its environment, and will not satisfy Standard 9.
- Section 14-1005(6)(d): Restrictions on Demolition No building permit shall be issued for the demolition of a historic building ... or of a building ... located within a historic district that contributes, in the Historical Commission's opinion, to the character of the district, unless the Historical Commission finds that issuance of the building permit is necessary in the public interest, or unless the Historical Commission finds that the building ... cannot be used for any purpose for which it is or may be reasonably adapted.
 - o If the building at 704 Chestnut Street is classified as contributing, the demolition of the building cannot be approved in satisfaction of Section 14-1005(6)(d) of the historic preservation ordinance unless the Historical Commission finds that issuance of the building permit is necessary in the public interest, or unless the Historical Commission finds that the building ... cannot be used for any purpose for which it is or may be reasonably adapted.

STAFF RECOMMENDATION: The staff recommends denial of the in-concept application, pursuant to Standard 9 and, depending on the outcome of the reclassification review, Section 1401005(6)(d) of the Philadelphia Code, the prohibitions against demolition.

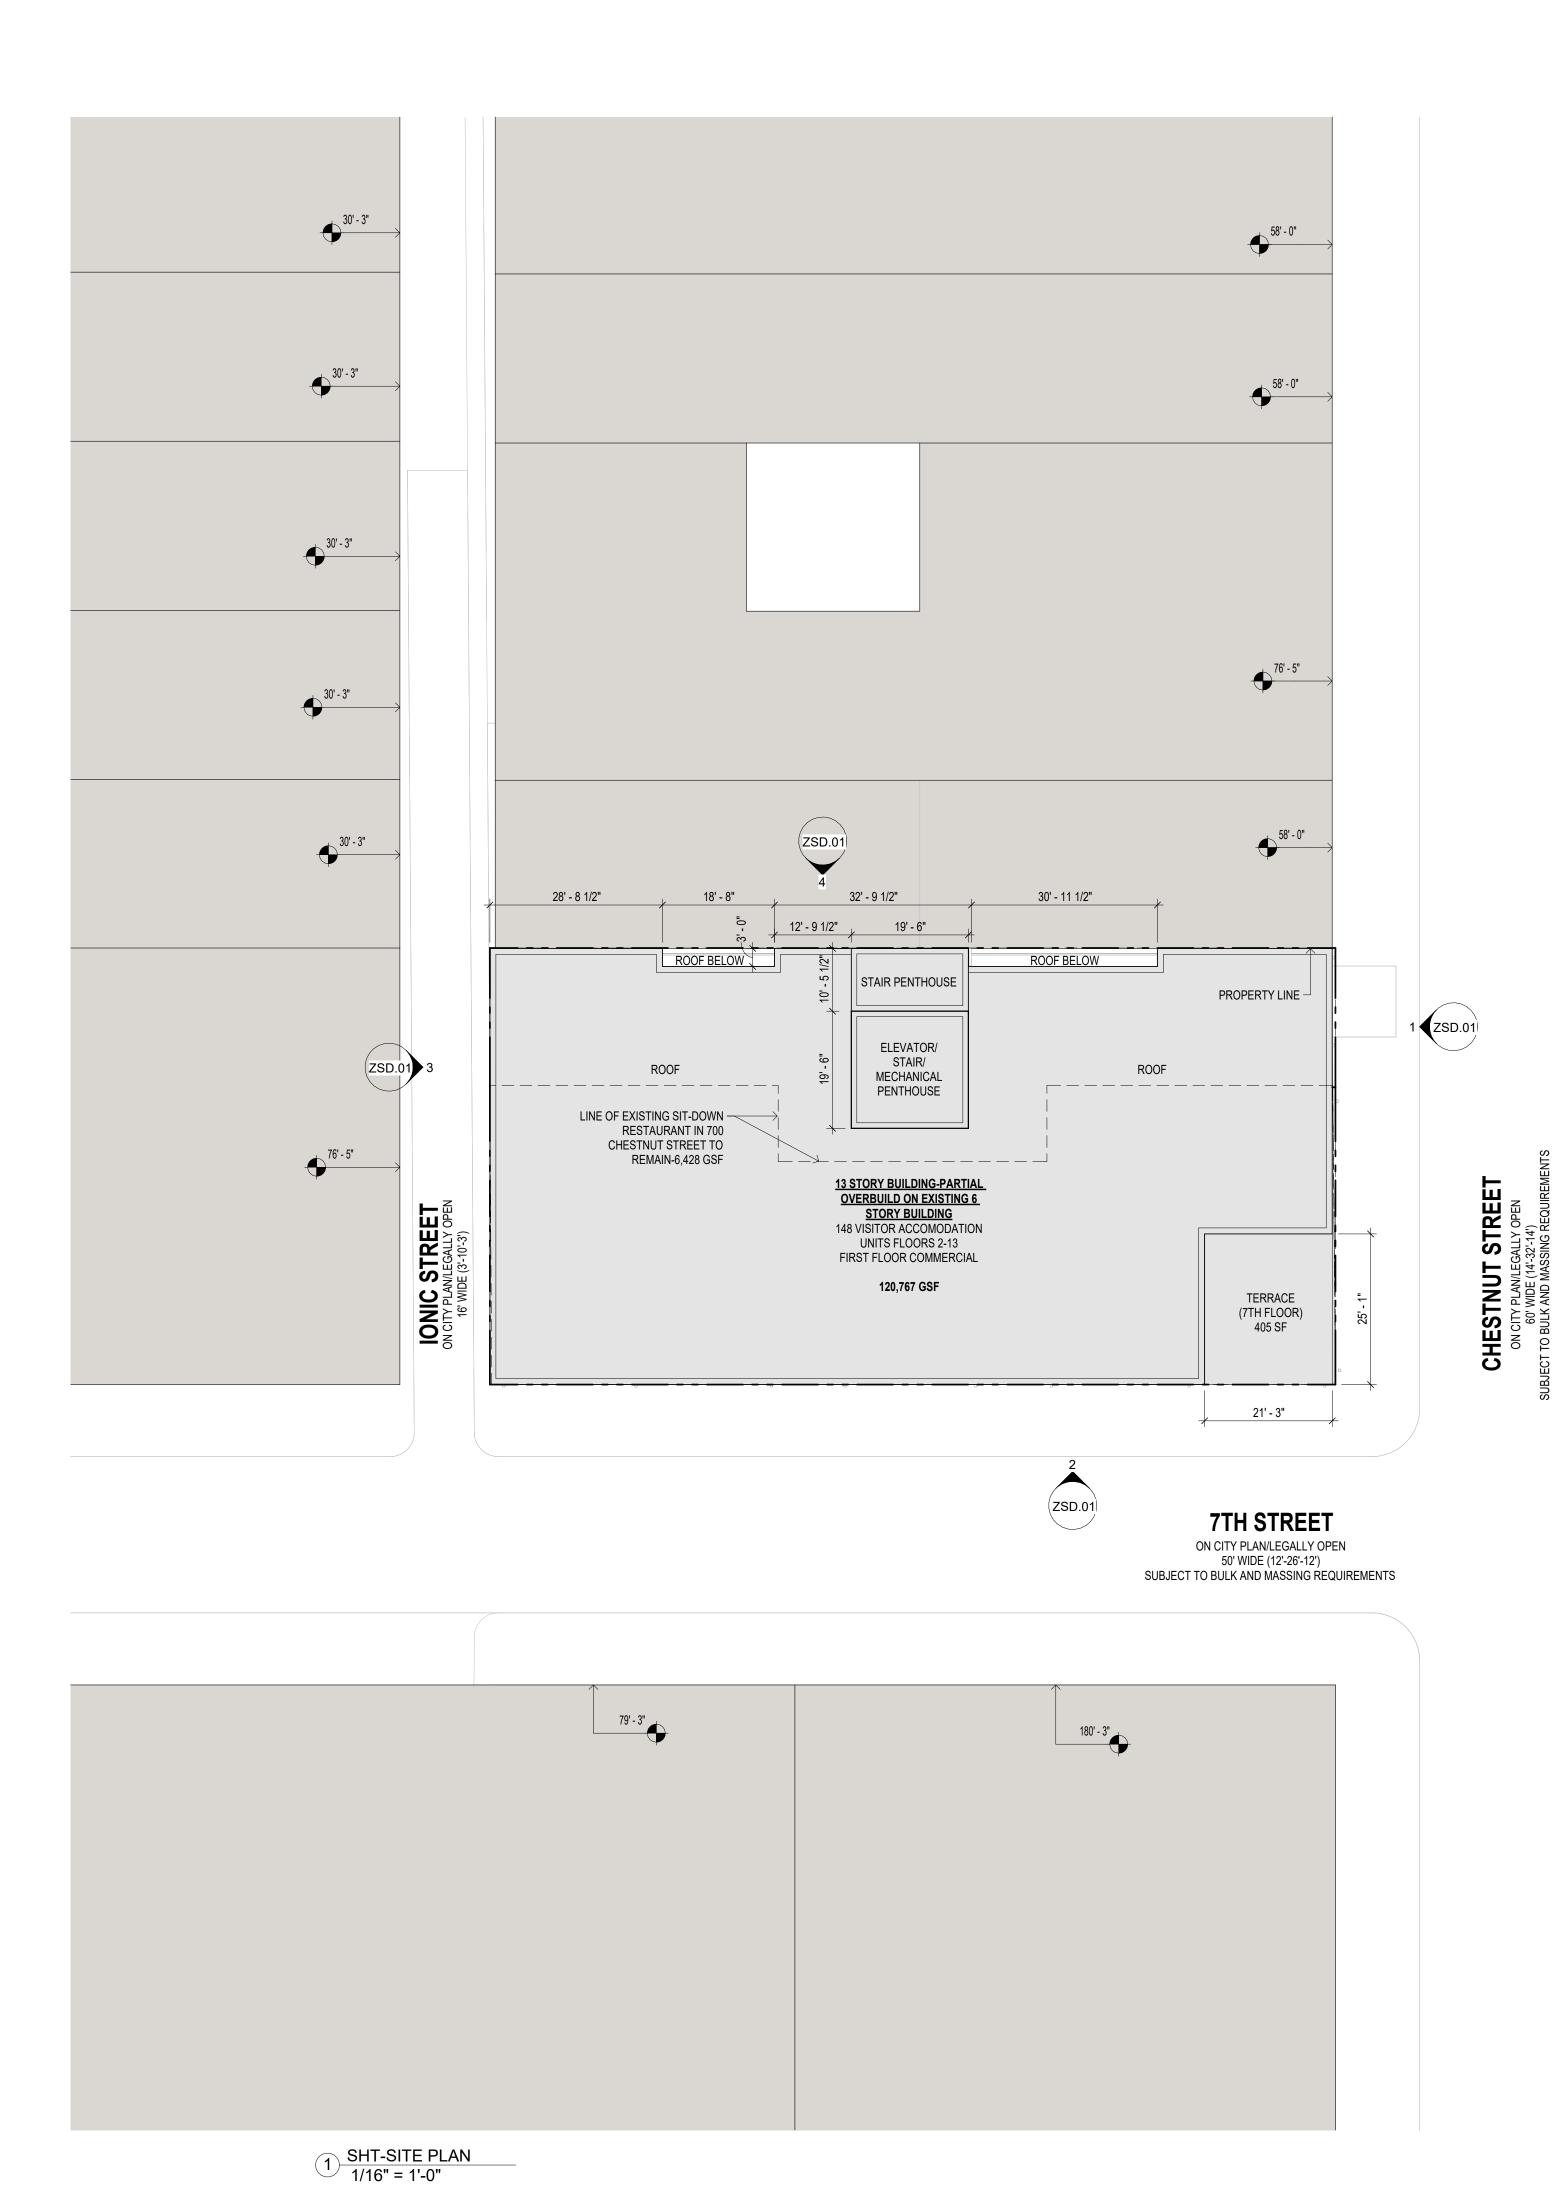

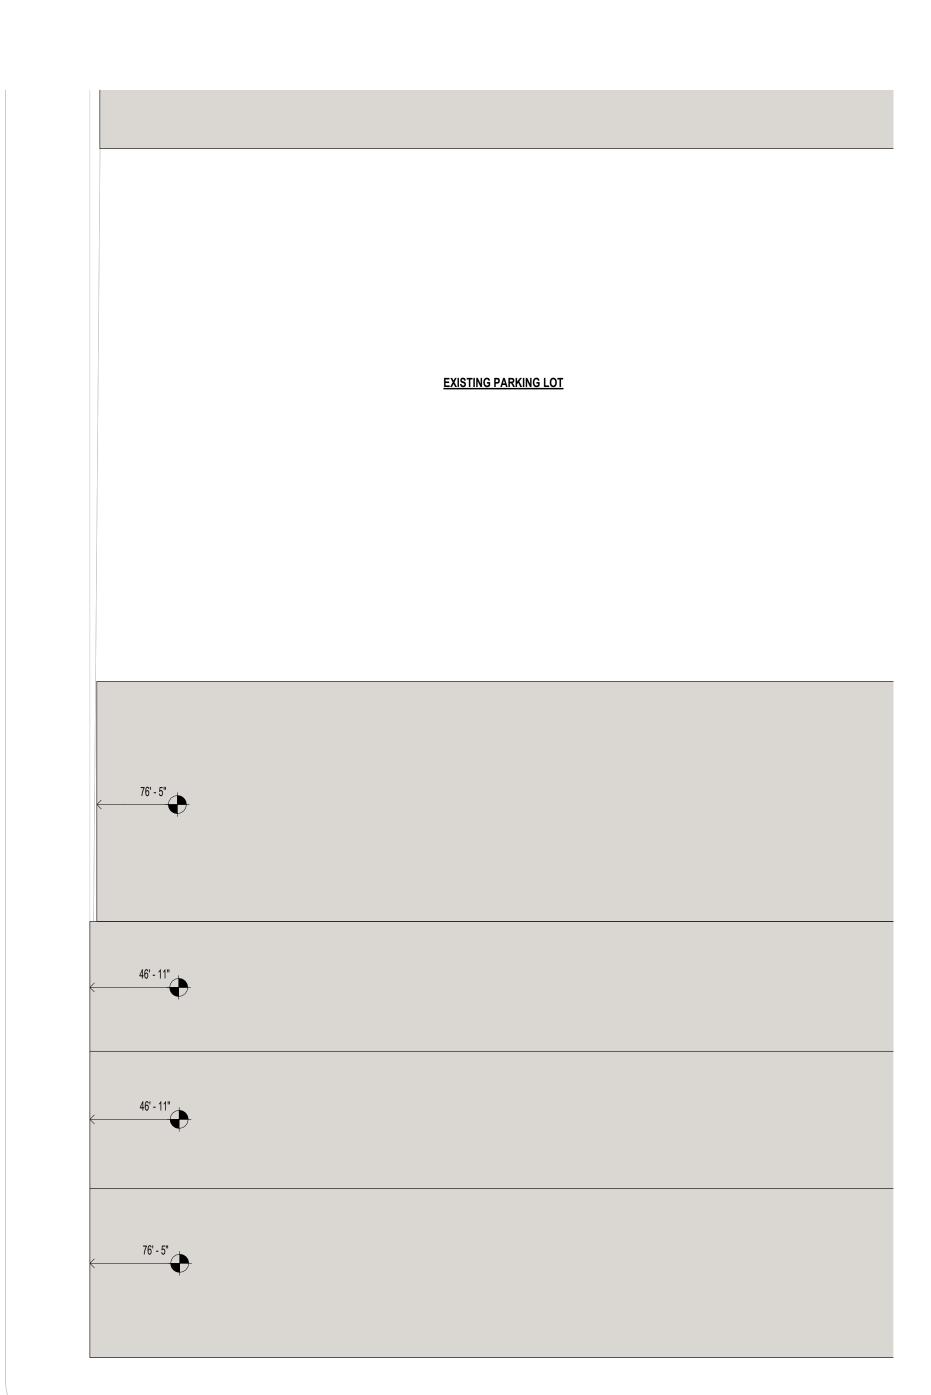

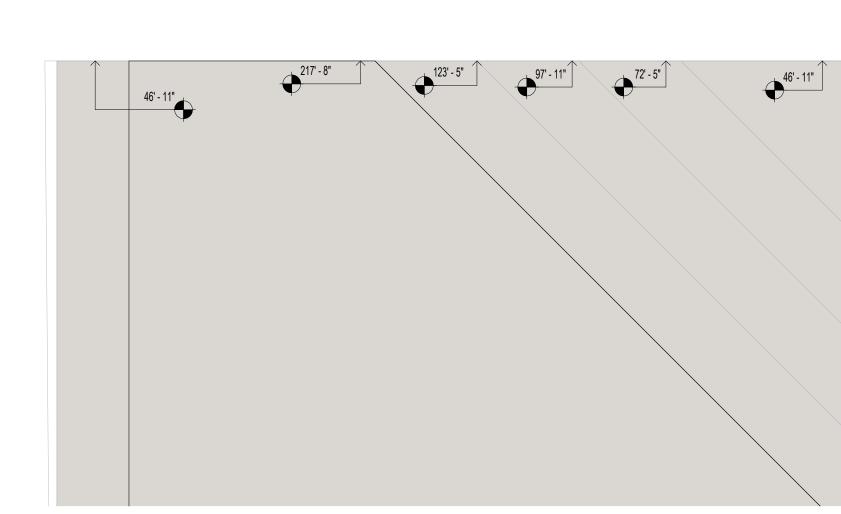

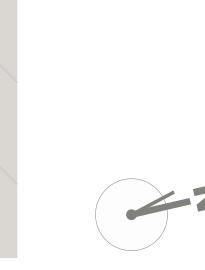



PROJECT NAME

700 CHESTNUT STREET PHILADEPHIA, PENNSYLVANIA

PROJECT TEAM

OWNER
HIGHTOP REAL ESTATE
448 NORTH 10TH STREET, SUITE 303
PHILADELPHIA, PENNSYLVANIA

<u>STRUCTURAL</u>

<u>SYSTEMS</u>

CIVIL ENGINEER

CONTRACTOR ACKNOWLEDGEMENT:

By using or agreeing to use any of the information set forth on the project drawing and specifications, each contractor, subcontractor and/ or supplier acknowledges that: (a) it has thoroughly reviewed <u>all</u> of the project drawings, specifications and existing conditions to obtain the information necessary for performance of it's work scope; (b) it has verified that the information used is accurate and

(c) it will report any inaccurate or incomplete information to the project architect immediately upon becoming aware of the error or omission; and (d) it will look solely to the party it has a contract with to recover economic losses or damages which are caused or alleged to have been caused by errors or omissions in the information used.

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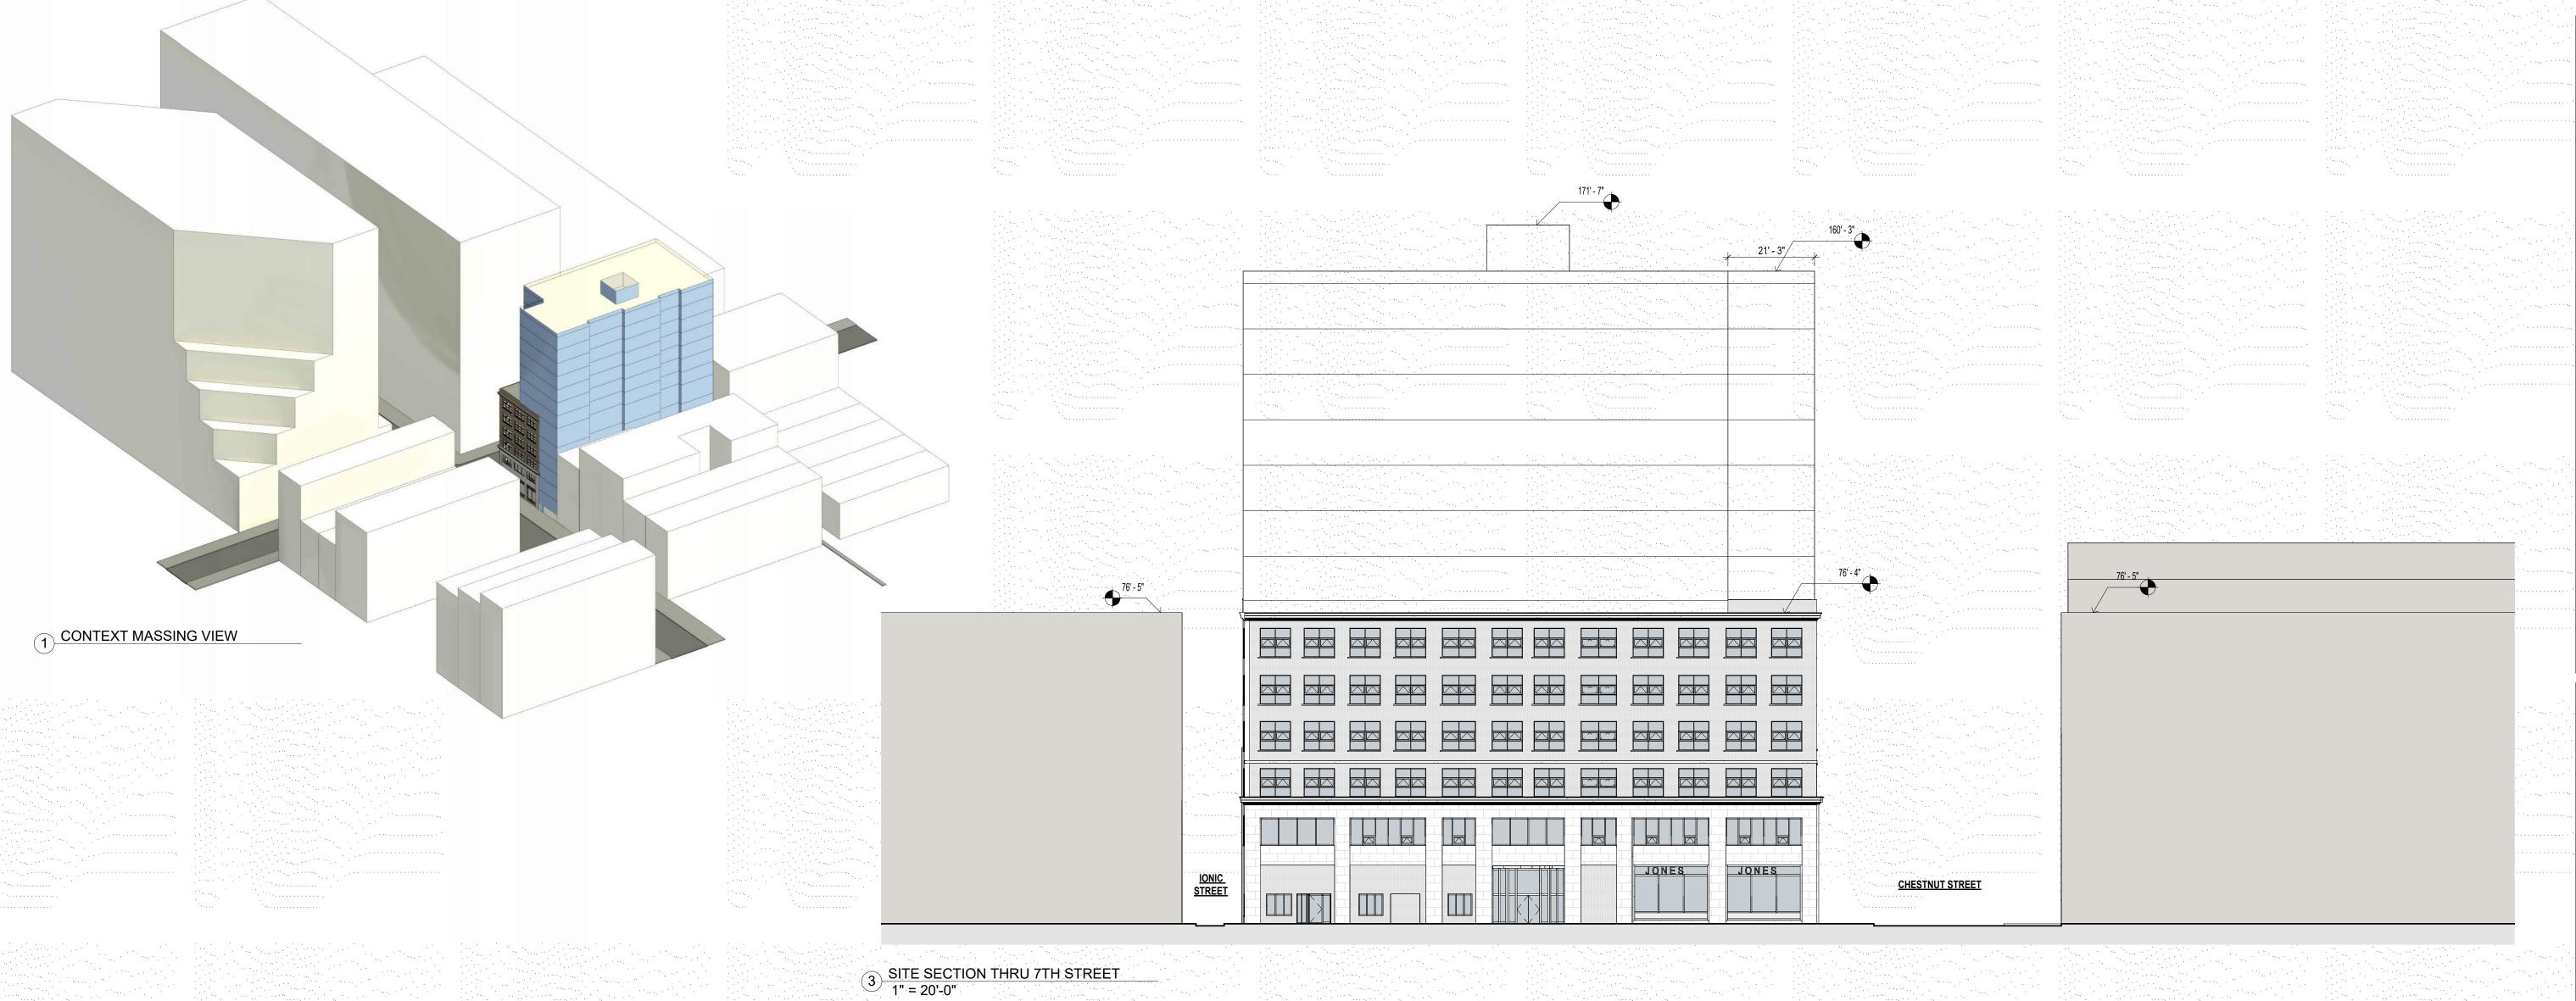
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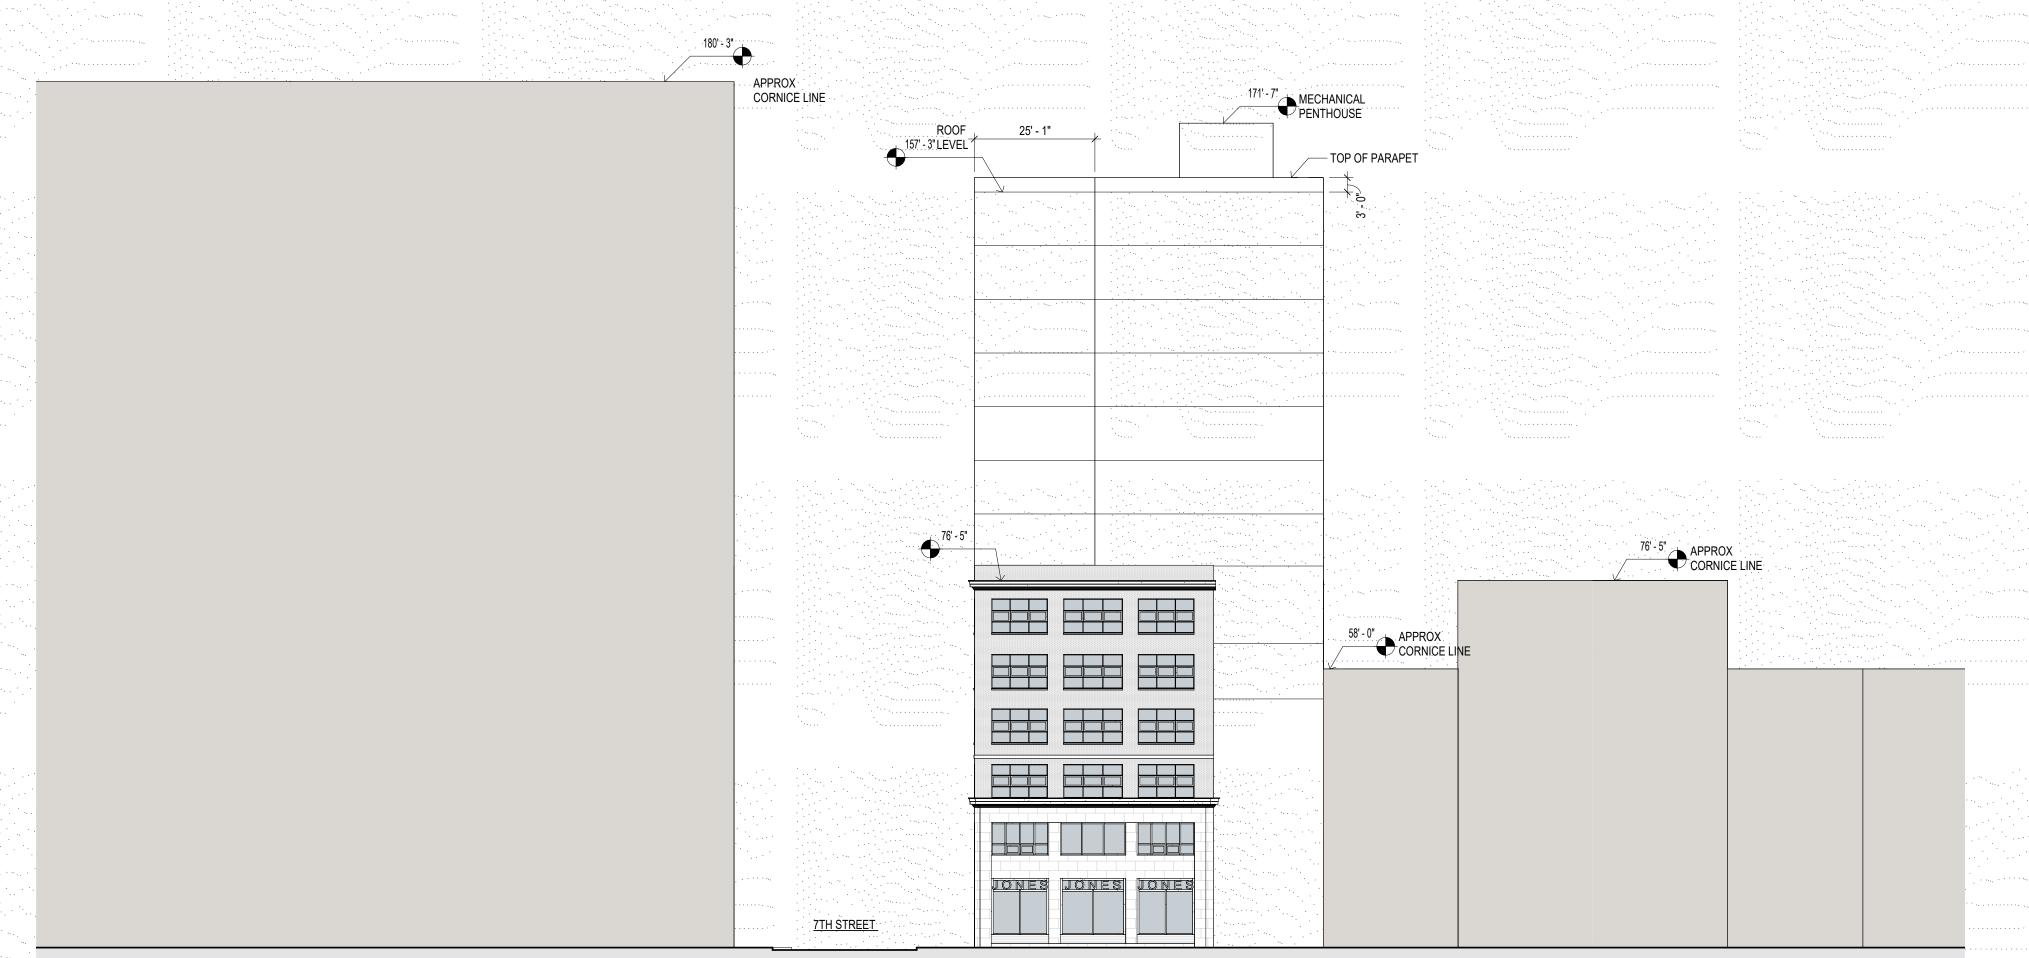
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SITE PLAN

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PROJECT NO. 2036





STUDIO

LIST STUDIO

ARCHITECTURE | DESIGN | DEVELOPMENT

575 NORTH MIDDLETOWN RD
MEDIA PA 19063 215 995 4908

PROJECT NAME

700 CHESTNUT STREET PHILADEPHIA, PENNSYLVANIA

PROJECT TEAM

OWNER
HIGHTOP REAL ESTATE
448 NORTH 10TH STREET, SUITE 303
PHILADELPHIA, PENNSYLVANIA

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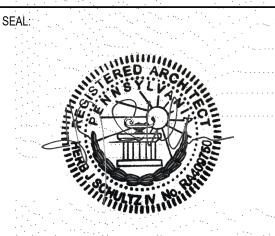
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REVISIONS

NO. DATE ISSUE

DRAWING TITLE

MASSING VIEW & SITE SECTIONS


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CUEET NO

H101

PROJECT NO. 2036

2 SITE SECTION THRU CHESTNUT 1" = 20'-0"



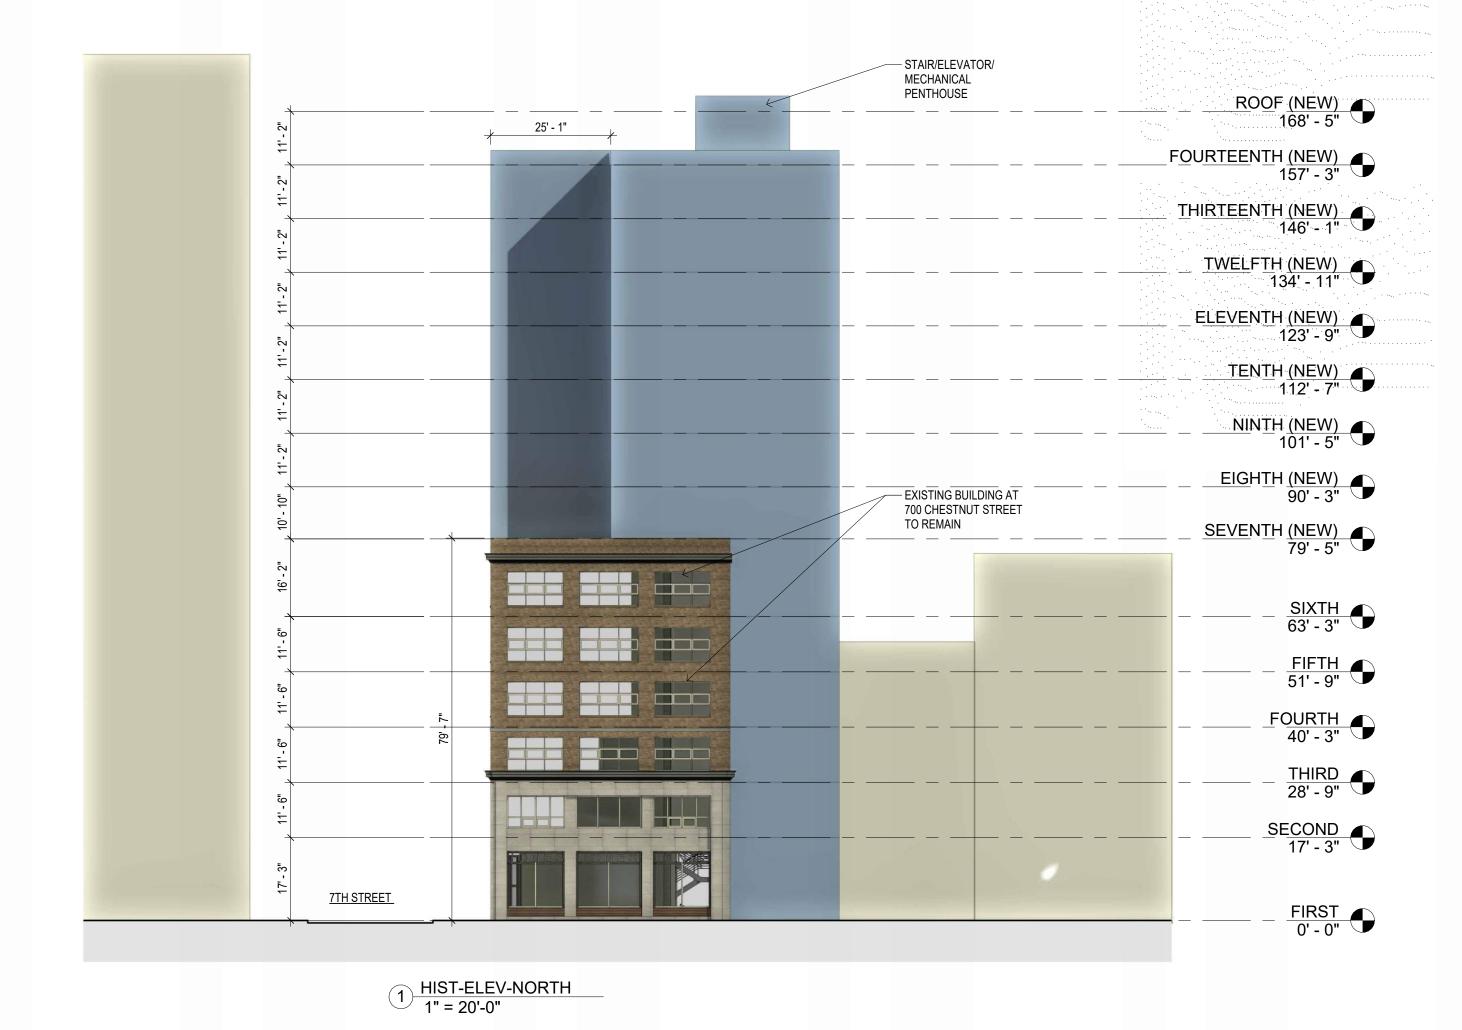

— STAIR/ELEVATOR/ MECHANICAL PENTHOUSE FOURTEENTH (NEW) 157' - 3" THIRTEENTH (NEW) 146' - 1" TWELFTH (NEW) 134' - 11" ELEVENTH (NEW) 123' - 9" TENTH (NEW) 112' - 7" NINTH (NEW) 101' - 5" EIGHTH (NEW) 90' - 3" SEVENTH (NEW) 79' - 5" SIXTH 63' - 3" FIFTH 51' - 9" FOURTH 40' - 3" THIRD 28' - 9" SECOND 17' - 3" 7TH STREET
STREET FIRST 0' - 0"

STAIR/ELEVATOR/ — MECHANICAL PENTHOUSE FOURTEENTH (NEW) 157' - 3" THIRTEENTH (NEW) 146' - 1" TWELFTH (NEW) 134' - 11" ELEVENTH (NEW) 123' - 9" TENTH (NEW) 112' - 7" NINTH (NEW) 101' - 5" EIGHTH (NEW) 90' - 3" SEVENTH (NEW) 79' - 5" EXISTING ROOF 79' - 5" SIXTH 63' - 3" FIFTH 51' - 9" FOURTH 40' - 3" THIRD 28' - 9" SECOND 17' - 3" CHESTNUT STREET <u>IONIC</u> STREET FIRST 0' - 0"

STUDIO

LIGHT STATE

ARCHITECTURE | DESIGN | DEVELOPMENT

575 NORTH MIDDLETOWN RD
MEDIA, PA 19063 215.995.4908

PROJECT NAME

700 CHESTNUT STREET PHILADEPHIA, PENNSYLVANIA

PROJECT TEAM

OWNER
HIGHTOP REAL ESTATE
448 NORTH 10TH STREET, SUITE 303
PHILADELPHIA, PENNSYLVANIA

<u>STRUCTURAL</u>

<u>SYSTEMS</u>

<u>CIVIL ENGINEER</u>

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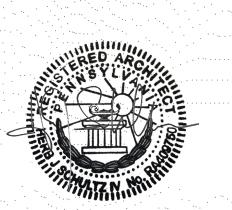
the project architect immediately upon becoming aware of the error or omission; and
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DRAWING TITLE

PROPOSED NEW ELEVATIONS

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 DATE:
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SHEET NO.

PROJECT NO.

H102

2036

4 HIST-ELEV-SOUTH 1" = 20'-0"

3 HIST-ELEV-WEST 1" = 20'-0"



VIEW OF 700 CHESTNUT LOOKING SOUTH



VIEW OF 700 CHESTNUT FROM ADJACENT CORNER



VIEW OF 700 CHESTNUTAT IONIC STREET

STUDIO

PROJECT NAME

700 CHESTNUT STREET PHILADEPHIA, PENNSYLVANIA

PROJECT TEAM

OWNER
HIGHTOP REAL ESTATE
448 NORTH 10TH STREET, SUITE 303
PHILADELPHIA, PENNSYLVANIA

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REVISIONS


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VIEWS OF **EXISTING**


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H103

PROJECT NO.



HIST-VIEW FROM PARKING ACROSS STREET

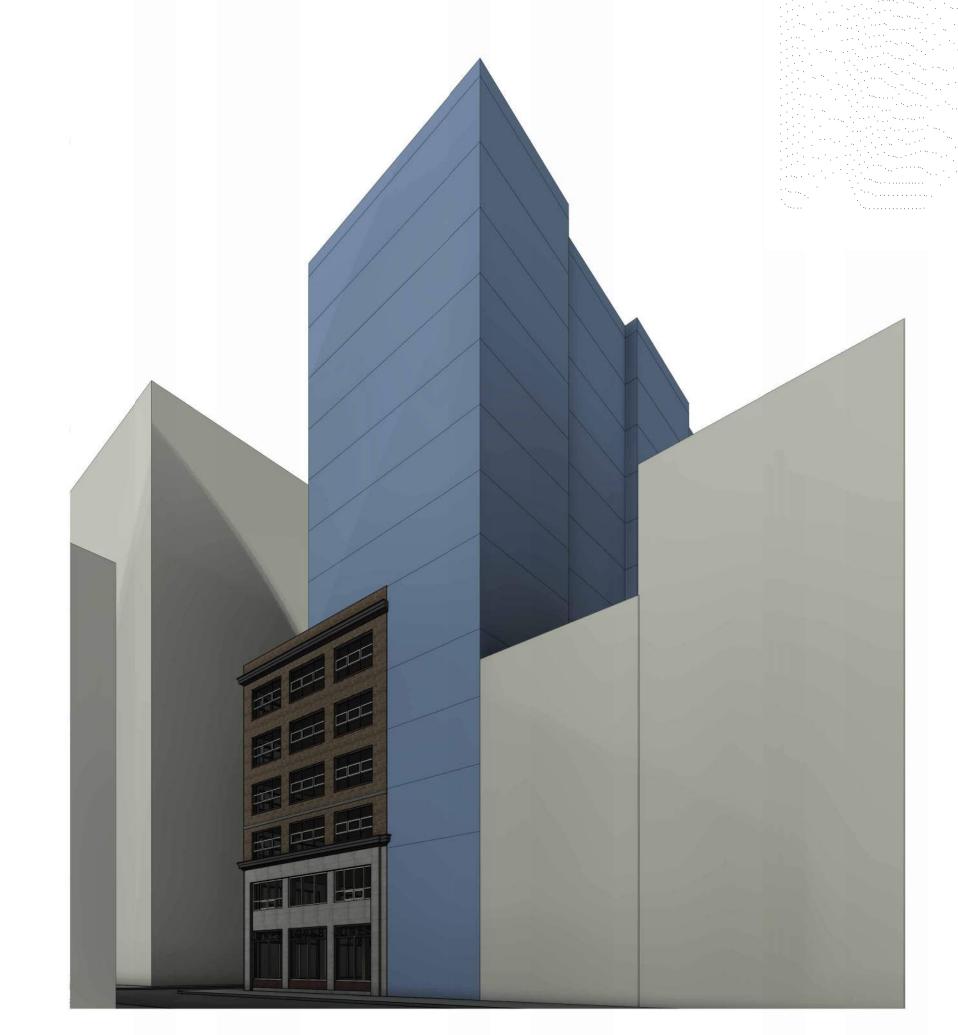

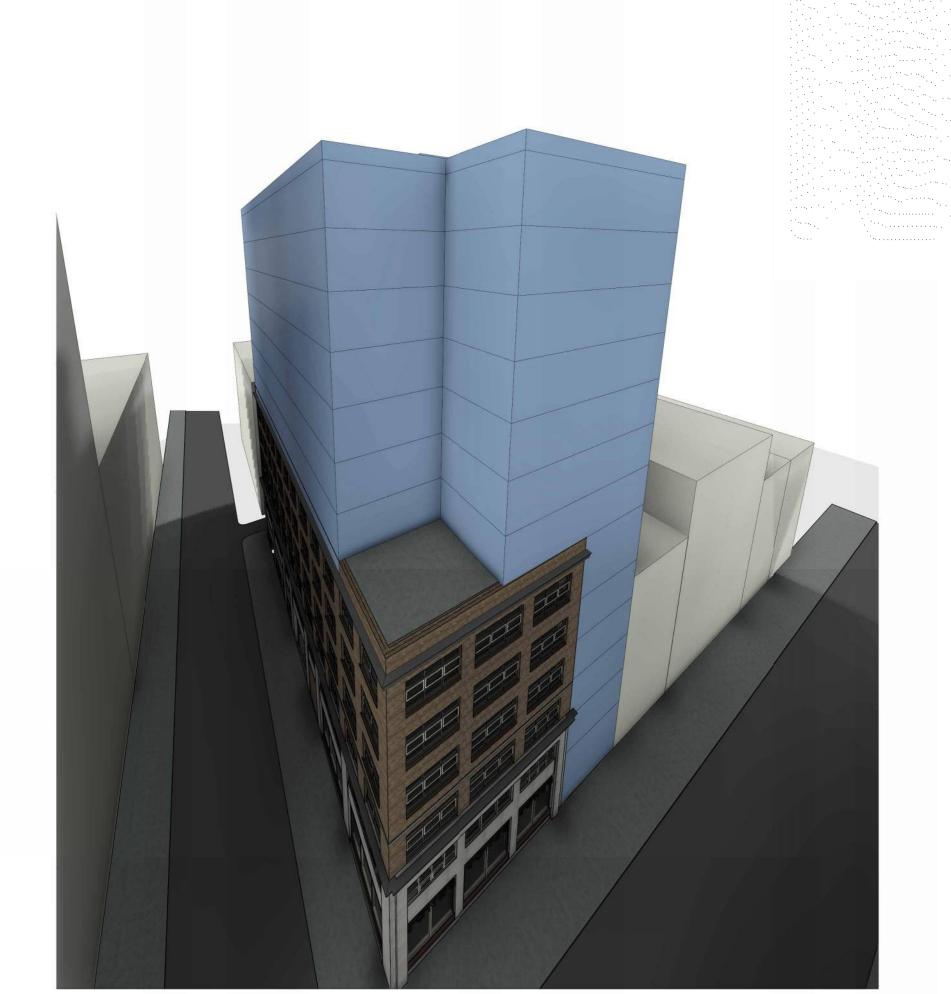



700 CHESTNUT STREET PHILADEPHIA, PENNSYLVANIA

OWNER
HIGHTOP REAL ESTATE
448 NORTH 10TH STREET, SUITE 303
PHILADELPHIA, PENNSYLVANIA

STRUCTURAL

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REVISIONS

DRAWING TITLE

PROJECT NO.

PROPOSED VIEWS

HIST-BIRDS EYE VIEW OF BUILDING

HIST-VIEW ACROSS STREET



STUDIO 575 NORTH MIDDLETOWN RD MEDIA, PA 19063 215.995.4908

PROJECT NAME

700 CHESTNUT STREET PHILADEPHIA, PENNSYLVANIA

PROJECT TEAM

OWNER
HIGHTOP REAL ESTATE
448 NORTH 10TH STREET, SUITE 303 PHILADELPHIA, PENNSYLVANIA

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REVISIONS ISSUE NO. DATE

DRAWING TITLE

PROPOSED ELEVATION FINISHES

1" = 20'-0" DRAWN BY: SCALE: 06/13/22 CHECKED BY: Checker

SHEET NO.

2036

PROJECT NO.



July 11, 2022 David Brown Cooke Brown 7 East Skippack Avenue Suite 310 Broad Axe, Pennsylvania 19002

Re: Structural Assessment for Existing building at 704 Chestnut Street

Dear David.

I am currently designing a new mixed-use project at 700-02 and 704 Chestnut Street. The properties are located in an Historic District. As such, our conceptual design plan involves maintaining the existing exterior envelopes of the buildings, with new construction built above the existing rooflines.

We are planning on implementing new floor plans that encompass both buildings with corridors connecting each side. Unfortunately, the floor elevations of each building are not the same; the second floor of 704 Chestnut is approximately 24" lower than 700 Chestnut and the third floor of 704 Chestnut is approximately 30" lower than 700 Chestnut. In order to meet ADA compliance, I need to provide an accessible route throughout each floor. This requires that I provide a contiguous walking path. The vertical distance is great enough that interior ramping at these floors is not workable. As such, I will need to demolish the existing second floor and third floor of 704 Chestnut and install new floors that align with the elevations of 700 Chestnut.

I'd like for you to assess the structural impacts of removing the existing floor framing while keeping the front and rear facades as well as the roof (we will need to install new structural elements for the overbuild that bypass the roof membrane.)

If your assessment finds that this is not feasible, I would like to review the impacts of removing the floor systems as well as the rear façade and roof while keeping the front façade in place.

Please call me should you have any questions.

Sincerely,

Herb Schultz IV, AIA LEED AP Principal, Studio HS4, LLC



David J. Brown, P.E., Vice President Joseph W. Cooke, P.E., Founder/Associate 215.654.0105 www.cookebrown.com 7 East Skippack Pike, Suite 310 Broad Axe, PA 19002

July 13, 2022

Studio HS4 575 North Middletown Rd Media, PA 19063 Attn: Mr. Herb Schultz

Ref: Existing Building Structural Evaluation

704 Chestnut St, Philadelphia, PA

#22062

Dear Mr. Schultz:

At your request, Cooke Brown visited the existing building at 704 Chestnut Street in Philadelphia, Pennsylvania. The purpose of our visit was to evaluate the existing structure and the effects of proposed renovations.

The renovations that are proposed are described in your letter dated July 11, 2022.

The primary renovations that are proposed are related to modifying the existing structure by removing and relocating the existing 2nd and 3rd floors while maintaining the exterior building envelope. The structural impacts of that proposed change are as follows.

- The existing front façade of the building is a primarily windows with some wood framing. It is supported by and integrated into the current floor framing. If the existing 2nd and 3rd floors will be removed, this façade will be completely unsupported and unstable.
- The rear façade of the building is constructed of brick masonry. It is dependent
 on bracing by the floor system at each level for lateral stability. If the 2nd and 3rd
 floor will be removed, this wall will be unstable.
- The existing roof structure is supported by the walls which are on and/or adjoin the property lines to the adjacent buildings. The stability of the roof structure in the case that the 2nd and 3rd floors are removed is dependent on the stability of those walls. The wall on the west side of the property is a party wall shared with 706 Chestnut. Additional field verification will be required to determine if the connection to 706 Chestnut is sufficient to maintain bracing of this wall prior to floor demolition. The wall on the east side of the property adjoins the neighboring building 700-702 Chestnut. This wall is primarily supported by 704

July 13, 2022 Studio HS4 Structural Evaluation 704 Chestnut St, Philadelphia, PA Page 2 of 4

Chestnut, and is not sufficiently supported by the adjacent building, therefore removal of the floors would result on this wall being unbraced and unstable.

Based on the above, it is our professional opinion that the 2nd and 3rd floor framing of 704 Chestnut cannot be removed without creating structurally unstable conditions for three of the four exterior walls (North, South, East) and for the roof. Some additional work may be required to improve the connections of the West wall to the neighboring building.

In addition to the above, you asked us to review the impact of removing the floor systems along with the rear façade and roof while maintaining the front façade in place.

The facade in question is shown in Image 1.



Image 1

We noted the following:

 The Chestnut façade at the ground floor level consists of storefront windows with stud framing. This is the Las Vegas Lounge area. All evidence indicates that all of the original façade elements have been removed at this level. The framing that is now present does not have any inherent self-supporting ability, and it will be unsupported if the floor structure behind is demolished. July 13, 2022 Studio HS4 Structural Evaluation 704 Chestnut St, Philadelphia, PA Page 3 of 4

• The Chestnut façade at the 2nd and 3rd levels consists primarily of windows, with wood framing at the window jams. There is a narrow band of brick at each side of the façade. This façade also does not have any inherent self-supporting ability and will be unsupported if the floor/roof structure is demolished.

The most important initial conclusion is that the façade will not be capable of supporting itself after the demolition of the floors and roof. If the floors and roof were to be removed, the façade would collapse. Therefore, the option of demolishing the interior of the building and leaving the façade unsupported is ruled out.

The next steps in our analysis are to review the option of preserving the façade using temporary bracing. To study this, we will first review the feasibility of supporting the façade by temporary bracing, and then review the risks and costs associated with this approach.

The primary challenge with using temporary bracing for this façade is that it is not currently capable of carrying its own self weight. From what we were able to observe, it appears that the façade is supported separately at each level by the existing floors. Therefore, any temporary support system would not only be providing lateral bracing but would also need to be able to carry the weight of the wall system. The normal way that this would be accomplished would be with a needle beam temporary lintel approach. This approach however is not practical since the façade mostly consists of only windows. Removal of the windows in order to allow for support of the facade would in reality be a removal the majority of the façade itself. Other than the windows there are only the jamb posts, and these cannot be cut to create access holes without compromising the integrity of the structure. The brick piers on the sides do not support the window wall system, so they are not available to use for this purpose. The only approach to bracing would be to use the window openings, and therefore the windows would have to be removed. Once it is given that the windows would have to be removed, a method could be developed to temporarily support the remaining elements. The normal method for this is to use a scaffolding system that is capable of supporting itself and the façade for gravity and lateral forces. Such a system is typically a custom fabricated steel structure which requires new foundations to be created in the sidewalk for support.

There are multiple levels of risks associated with the approach of using temporary bracing to support the façade. The individual items are as follows:

It may be found in the course of the work that portions of the façade are in a
deteriorated condition that makes the use of the temporary shoring system
unfeasible. We believe that this could be a significant issue at 704 Chestnut St
due to the renovations that were done at the Las Vegas Lounge façade. We also
observed some areas where cracks are present between the brick portions of the
wall and the party walls.

July 13, 2022 Studio HS4 Structural Evaluation 704 Chestnut St, Philadelphia, PA Page 4 of 4

- Potential for damage to the façade during the process is a concern. This risk
 would be less of a concern if the existing façade was constructed of more durable
 materials such as brick or stone masonry, but for this structure the materials
 being supported will only be wood with small areas of brick. Damage is a
 significant possibility in the process of removing the windows and from exposure
 of the structure to the elements during the project.
- There is some potential risk to the adjacent properties from this approach. Attempting to brace an existing structure of this type creates a situation where at some point through the process the existing façade could be found to be unstable, and the bracing could not be achieved. Should such a situation occur, it would become necessary to demolish the façade immediately as a matter of public safety. This would not allow for the careful demolition process that would normally be pursued to protect the adjacent structures.
- The construction of a temporary shoring system will be a major project, and it
 will have a large impact on the usability of the pedestrian sidewalk for the
 duration of the project. This may have a negative impact on access and usability
 of adjacent buildings and on the flow of traffic in the area.

Based on the above, it is our professional opinion that the option of keeping this façade is structural unwise and impractical. We do not recommend this option due to risks associated with bracing the façade, in combination with the fact that the windows, which make up the majority of the façade, will have to be removed anyway. We do not recommend pursuing such a bracing project when only a small fraction of the existing elements would be able to be saved, and there is a significant likelihood that even those elements will be found to be in a deteriorated condition once the project is underway.

The above reflects our professional opinion based on the information available to us at this time. If any new information becomes available, please provide it to us so that we have the opportunity to revise our report and recommendations.

Please contact the undersigned for any additional items related to this matter.

Sincerely,

David J. Brown, P.E.

Vice President