ADDRESS: 1524-38 GERMANTOWN AVE

Proposal: Rehabilitate building; construct additions

Review Requested: Final Approval

Owner: TR Gretz LP

Applicant: Anthony Tsirantonakis, T + Associates Architects

History: 1885; Gretz Brewery; 1894-96; 1900; 1901; 1903; 1905; c. 1944

Individual Designation: 11/9/2018

District Designation: None

Staff Contact: Laura DiPasquale, laura.dipasquale@phila.gov

BACKGROUND:

This application proposes the adaptive reuse of the former Gretz Brewery complex, which was listed on the Philadelphia Register of Historic Places in November 2018. The Historical Commission reviewed an in-concept application for this same scope on 12 April 2019, and voted unanimously to approve the in-concept application. As required by the Commission's Rules and Regulations, the applicant has now submitted for final approval. This final approval application includes details, such as specification sheets for windows and doors, which were not part of the in-concept application.

At the time of designation, the Commission voted to consider "Building 12" at the corner of Germantown Avenue and Redner Street as non-contributing, so that it may be approved for demolition to allow for greater flexibility with the plans for redevelopment. Also at the time of designation, the developer briefly showed preliminary plans to the Commission for redevelopment of the site, to demonstrate that plans for reuse of the property had been in the works for some time prior to the proposed historic designation. Several members of the staff toured the complex with the developer and architect in late 2018 and can confirm that the buildings have suffered from years of deferred maintenance and exposure to the elements. Several buildings in the complex are lacking roofs.

SCOPE OF WORK:

- Demolish non-contributing "Building 12" at corner of Germantown Avenue and Redner Street.
- Construct new mixed-use buildings on vacant lot created by demolition of "Building 12" and on existing vacant lot at corner of Germantown Avenue and W. Oxford Street.
- Construct overbuilds and additions on existing historic buildings.
- Rehabilitate historic facades and iconic chimney with "Gretz beer" signage.
- Install new windows and doors throughout.

STANDARDS FOR REVIEW:

- Standard 5: Distinctive materials, features, finishes, and construction techniques or examples of craftsmanship that characterize a property will be preserved.
 - The proposed project retains the historic facades and chimney, which are the highly visible portions of the complex that convey the historic materials and features.
- Standard 6: Deteriorated historic features will be repaired rather than replaced. Where the severity of deterioration requires replacement of a distinctive feature, the new feature will match the old in design, color, texture, and where possible materials. Replacement of missing features will be substantiated by documentary and physical evidence.

- The proposed project retains the historic street-facing facades. The interior of the complex, which is not visible from the street, is not a distinctive feature, and is in disrepair, and therefore does not require repair nor replacement in kind.
- Standard 9: New additions, exterior alterations, or related new construction will not destroy historic materials, features, and spatial relationships that characterize the property. The new work shall be differentiated from the old and will be compatible with the historic materials, features, size, scale and proportion, and massing to protect the integrity of the property and its environment.
- Standard 10: New additions and adjacent or related new construction will be undertaken in such a manner that, if removed in the future, the essential form and integrity of the historic property and its environment would be unimpaired.
 - The proposed project includes overbuilds with setbacks on historic facades, in an attempt to minimize the massing on the historic structures. Overall, the new construction portions of the complex may not strictly satisfy preservation standards, but should be considered owing to the poor condition of the complex, in addition to the plans having been developed prior to notice of proposed historic designation.

STAFF RECOMMENDATION: Approval, with the staff to review details, pursuant to Standards 5, 6, 9, and 10 and the Historical Commission's 12 April 2019 in-concept approval.

THE MINUTES OF THE 680TH STATED MEETING OF THE PHILADELPHIA HISTORICAL COMMISSION

FRIDAY, 12 APRIL 2019 ROOM 18-029, 1515 ARCH STREET ROBERT THOMAS, CHAIR

CALL TO ORDER

START TIME IN AUDIO RECORDING: 00:00:02

Mr. Thomas, the chair, called the meeting to order at 9:06 a.m. and announced the presence of a quorum. The following Commissioners joined him:

Commissioner	Present	Absent	Comment
Robert Thomas, AIA, Chair	Х		
Emily Cooperman, Ph.D., Committee on Historic Designation Chair	Х		
Kelly Edwards, MUP	Х		
Steven Hartner (Department of Public Property)	Х		
Josh Lippert (Department of Licenses & Inspections)	Х		
Mark Dodds (Division of Housing & Community Development)	Х		
John Mattioni, Esq.	Х		
Dan McCoubrey, AIA, LEED AP BD+C, Architectural Committee Chair		Х	
Jessica Sánchez, Esq. (City Council President)	Х		
Meredith Trego (Philadelphia City Planning Commission)	Х		
H. Ahada Stanford, Ph.D. (Commerce Department)		Х	
Betty Turner, MA, Vice Chair	Х		
Kimberly Washington, Esq.	Х		

The following staff members were present:

Jonathan E. Farnham, Ph.D., Executive Director Randal Baron, Historic Preservation Planner III Kim Chantry, Historic Preservation Planner II Laura DiPasquale, Historic Preservation Planner II Meredith Keller, Historic Preservation Planner II Allyson Mehley, Historic Preservation Planner I Megan Schmitt, Historic Preservation Planner I Leonard Reuter, Esq., Law Department

The following persons were present:

Justin Detwiler, John Milner Architects
Raymond Rola, Raymond F. Rola Architect
James Baylor
Wilber Winborne
Celeste Morello
Cliff Eyler
Joe Strampello, Mattioni, Ltd.
Pat Henningsen
Peter A. Lamlein

Jacob Cooper

Johnette Davies, Amtrak

Sue Patterson, Penn Knox Neighborhood Association

Paul Steinke, Preservation Alliance for Greater Philadelphia

Amelia Riley

David S. Traub, Save Our Sites

Steven Peitzman

Michael Phillips, Esq., Obermayer

Ben Leech, Preservation Alliance for Greater Philadelphia

J.M. Duffin

Oscar Beisert

Aaron Wunsch

Elizabeth Stegner, University City Historical Society

Michael Caine, Old First Church

Simon Kaufman, Partners for Sacred Places

Gabor Antalics

Anthony Giacobbe

Cindy Hamilton, Heritage Consulting Group

David La Fontaine, Community Ventures

Irwin Trauss, Penn Knox Neighborhood Association

Mark Sandberg

Marc Cam, Action News

William McGurrin

John Brady

Deja Lynn Alvarez

Faye Anderson, All That Philly Jazz

David Gest, Esq., Ballard Spahr

Matt McClure, Esq., Ballard Spahr

Arwa Abdelmoula, Esq., Ballard Spahr

Al Fuscaldo, Esq.

Philip Rosenzweig, Esq.

Caitlin McCabe, Philadelphia Inquirer

Robert Tunick

Josh Yeager

Wylie McDermott

Kyle Thorp

Danya Pilgrim

David Ertz, Cope-Linder-Nelson

Venice Whitaker

Craig Shelter, Shelter & Associates

John Turchi, Turchi Inc.

Robert Bowes

Doug Seiler

Robert Kramer

Ian Cope, Nelson

Richard DeMarco, Esq.

Paul Boni, Esq., Boni Law

ADDRESS: 1524-38 GERMANTOWN AVE

Proposal: Rehabilitate buildings; construct additions

Review Requested: In Concept

Owner: TR-GRETZ LP

Applicant: Anthony Tsirantonakis, T + Associates

History: 1885; Gretz Brewery; 1894-96; 1900; 1901; 1903; 1905; c. 1944

Individual Designation: 11/9/2018

District Designation: None

Staff Contact: Randal Baron, randal.baron@phila.gov, 215-686-7660

BACKGROUND:

This in-concept application proposes the adaptive reuse of the former Gretz Brewery complex, which was listed on the Philadelphia Register of Historic Places in November 2018. At the time of designation, the Commission voted to consider "Building 12" at the corner of Germantown Avenue and Redner Street as non-contributing, so that it may be approved for demolition to allow for greater flexibility with the plans for redevelopment. Also at the time of designation, the developer briefly showed preliminary plans to the Commission for redevelopment of the site, to demonstrate that plans for reuse of the property had been in the works for some time prior to the proposed historic designation. Several members of the staff toured the complex with the developer and architect in late 2018 and can confirm that the buildings have suffered from years of deferred maintenance and exposure to the elements. Several buildings in the complex are lacking roofs.

SCOPE OF WORK

- Demolish non-contributing "Building 12" at corner of Germantown Avenue and Redner Street.
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- Construct overbuilds and additions on existing historic buildings.
- Rehabilitate historic facades and iconic chimney with "Gretz beer" signage.

STANDARDS FOR REVIEW:

The Secretary of the Interior's Standards for the Treatment of Historic Properties and Guidelines include:

- Standard 5: Distinctive materials, features, finishes, and construction techniques or examples of craftsmanship that characterize a property will be preserved.
 - The proposed project retains the historic facades and chimney, which are the highly visible portions of the complex that convey the historic materials and features.
- Standard 6: Deteriorated historic features will be repaired rather than replaced. Where the severity of deterioration requires replacement of a distinctive feature, the new feature will match the old in design, color, texture, and where possible materials. Replacement of missing features will be substantiated by documentary and physical evidence.
 - The proposed project retains the historic street-facing facades. The interior of the complex, which is not visible from the street, is not a distinctive feature, and is in disrepair, and therefore does not require repair nor replacement in kind.
- Standard 9: New additions, exterior alterations, or related new construction shall not destroy historic materials that characterize the property. The new work shall be

differentiated from the old and shall be compatible with the massing, size, scale, and architectural features to protect the historic integrity of the property and its environment.

- Standard 10: New additions and adjacent or related new construction shall be undertaken in such a manner that if removed in the future, the essential form and integrity of the historic property and its environment would be unimpaired.
 - The proposed project includes overbuilds with setbacks on historic facades, in an attempt to minimize the massing on the historic structures. Overall, the new construction portions of the complex may not strictly satisfy preservation standards, but should be considered owing to the poor condition of the complex, in addition to the plans having been developed prior to notice of proposed historic designation.
- Section 6.9.a.10 of the Commission's Rules & Regulations (also known as the "Transition Rule"): The Commission, its committees, and staff may consider development plans in place at the time of the issuance of the notice announcing the consideration of a designation including but not limited to executed contracts, substantial design development, or other evidence of a material commitment to development in the review of applications.
 - At the time that the letters were sent to the property owner notifying of the proposed historic designation, plans for a mixed-use adaptive reuse of the complex had been developed. Those plans were in line with the application subject to this in-concept review. The Architectural Committee and Historical Commission may take into account development plans in place at the time of the issuance of the notice announcing the consideration of a designation when reviewing plans for this site.

STAFF RECOMMENDATION: Approval in-concept, with the recommendation that massing of new construction on historic buildings be reduced where possible, pursuant to Standards 5, 6, and 9 and Section 6.9.a.10 of the Commission's Rules & Regulations.

ARCHITECTURAL COMMITTEE RECOMMENDATION: The Architectural Committee voted to recommend approval in-concept, provided the overbuilds are set back more on the historic buildings; the bright white color, corner building, and Redner Street façade designs are modified as per the Committee's comments; and the architect works with the staff on the window and storefront details, pursuant to Standards 5, 6, and 9, and Section 6.9.a.10 of the Historical Commission's Rules & Regulations.

START TIME OF DISCUSSION IN AUDIO RECORDING: 01:23:00

PRESENTERS:

- Mr. Baron presented the application to the Historical Commission.
- Architect Anthony Tsirantonakis and owner Tony Rufo of TR-Gretz LP represented the application.

Discussion: Mr. Baron explained that the architects had worked with the staff and incorporated all of the Architecture Committee suggestions into their revised drawings. Mr. Tsirantonakis explained that they had worked diligently with all of the stakeholders to make a successful project.

PUBLIC COMMENT:

- Paul Steinke of the Preservation Alliance for Greater Philadelphia supported the application.
- Oscar Beisert of the Keeping Society supported the application and noted that, with the help of the market, even an industrial complex in very poor condition can be adaptively reused.

HISTORICAL COMMISSION FINDINGS AND CONCLUSIONS:

The Historical Commission found that:

- The architect implemented the Architectural Committee's recommendations including revising the corner building to reflect the older building that had stood on the site, revised the setback of the overbuilds from 8 feet to 10 feet, changed the color of the overbuilds to reflect the terra cotta, revised and showed the Redner Street façade and attempted to make the chimney more prominent.
- The architect should continue to work with the staff on the windows, doors and storefronts as he prepares an application for final approval.
- At the time that the letters were sent to the property owner notifying of the proposed historic designation, plans for a mixed-use adaptive reuse of the complex had been developed. Those plans were in line with the application subject to this in-concept review. The Architectural Committee and Historical Commission may take into account development plans in place at the time of the issuance of the notice announcing the consideration of a designation when reviewing plans for this site.

The Historical Commission concluded that:

- The revised application satisfies Standards 5, 6, and 9.
- Section 6.9.a.10 of the Commission's Rules & Regulations, the transition rule, should be applied.

ACTION: Ms. Cooperman moved to approve the revised application in concept as presented to the Historical Commission at its meeting of 12 April 2019, pursuant to Standards 5, 6, and 9 and Section 6.9.a.10 of the Commission's Rules & Regulations. Ms. Edwards seconded the motion, which passed unanimously.

ITEM: 1524-38 GERMANTOWN AVE MOTION: Approval in concept MOVED BY: Cooperman SECONDED BY: Edwards

VOTE						
Commissioner	Yes	No	Abstain	Recuse	Absent	
Thomas, Chair	Х					
Cooperman	Х					
Edwards	Х					
Hartner (DPP)	Х					
Lippert (L&I)	Х					
Dodds (DHCD)	Х					
Mattioni	Х					
McCoubrey					Х	
Sánchez (Council)	Х					
Trego (PCPC)	Х					
Stanford (Commerce)					Х	
Turner, Vice Chair	Х					
Washington	Х					
Total	11				2	

THE REPORT OF THE COMMITTEE ON HISTORIC DESIGNATION, 12 MARCH 2019

Emily Cooperman, Chair

ADDRESS: 153 N 4TH ST, PART OF THE PROPERTY AT 322-40 RACE ST

Proposed Action: Reclassification

Property Owner: Elders + Deacons, the Minister Trustees Applicant: Cindy Hamilton, Heritage Consulting Group

Staff Contact: Jon Farnham, jon.farnham@phila.gov, 215-686-7660

OVERVIEW: This application proposes to reclassify the building at 153 N. 4th Street as noncontributing in the Old City Historic District. It is currently listed as contributing to the district.

The lot at 153 N. 4th Street is not a tax parcel; it is part of the larger tax parcel known as 322-40 Race Street, which includes the Old First Reformed United Church of Christ building facing Race Street and two rowhouses facing N. 4th Street. Despite being a single tax parcel, the property has three entries in the historic district's inventory. The church building is classified as significant. The rowhouse at 151 N. 4th Street, which was constructed about 1760, is classified as significant. The rowhouse in question at 153 N. 4th Street, which was constructed in 1974, is classified as contributing. The rowhouse in question is Neo-Georgian in style, but is not a reconstruction of a building that stood on the site. The history of the building is fully documented in the applicant's submission.

When the Historical Commission designated the Old City Historic District on 12 December 2003, it debated the endpoint of the period of significance, ultimately setting it 1929. At the end of the review, the Historical Commission voted "to approve the Committee on Historic Designation's recommendation to designate the Old City Historic District with the following two amendments: that the boundary between Front and S. 2nd Streets be extended south from Ionic to Walnut Street; and that date of significance be established at 1676 to 1929 with the stipulation that all buildings built after 1929 be listed as 'non-contributing' unless already individually designated." The building at 153 N. 4th Street was constructed in 1974, 45 years after the end of the period of

T + Associates ARCHITECTS

525 S. 4 th Street, Suite 591 Philadelphia, P A 19147 215.629.6374

July 13, 2021

Kim Chantry

Historic Preservation Planner Philadelphia Historical Commission One Parkway, 13th floor 1515 Arch Street Philadelphia, PA 19102

Email: kim.chantry@phila.gov

Re: 1524-38 Germantown Avenue

Application for PHC "Final" Review

Dear Randy,

The property referenced above is a recently designated site and I would like the project referenced above to be considered for an "Final" Review by the Philadelphia Historical Commission.

Attached with this cover letter are the required materials including:

- Building Permit Application
- Digital Submission to Architectural Committee (July 13, 2021) Project Brochures which include existing photographs, existing drawings, zoning submission, design drawings and renderings of the proposed design, Façade Restoration and drawings required for the proposed design and Architectural drawings of the proposed design

Please feel free to contact me if you have questions. My phone no. is 215.629.6374 and my email is anthonyt@t-associates.net

Sincerely,

Anthony Tsirantonakis RA
T + Associates Inc. Architects

Tony

Job Number: (for office use only)

(PERMIT TYPE PREFIX – YEAR – NUMBER)

Application for Construction Permit

Use this application to obtain permits for a residential or commercial construction proposal.

Mechanical / Fuel Gas, Electrical, Plumbing, and Fire Suppression trade details are found on page 2.

Address Identify the location of work for the permit(s).		1524-38 Germantown Avenue
If the activity will take place in a specific building, tenant space, floor level, or suite, note that detail in the 'Specific Location' field. If applicable, list PR #.	1	Specific Location Check box if this application is part of a project and provide project number: PR-2 0 -
Applicant Identify how you are associated with the property.		I am the: ☐ Property Owner ☐ Tenant ☐ Equitable Owner ✓ Licensed Professional or Tradesperson Name Anthony Tsirantonakis T + Associates Architects
Licensed professionals include design professionals, attorneys, and expediters. A tradesperson must have	2	Address 525 S. 4th Street, Philadelphia, PA 19147
an active Philadelphia license for their trade or hold a PA Home Improvement Contractor Registration.		anthonyt@t-associates.net Phone 2 1 5 6 2 9 6 3 7 4
Property Owner Identify the deeded property owner.		TR Gretz LP
If there was a recent change of ownership, documentation such as a	3	Address 441 E. Elm Street, Conshohocken, PA
deed or settlement sheet will be required.		rufo@rufocontracting.com
Design Professional in Responsible Charge Identify the PA- licensed design	4	Anthony Tsirantonakis T + Associates Architects
professional who is legally responsible.		PA License # Phila. Commercial Activity License #
теариташе.		Email anthonyt@t-associates.net
Project Scope Use this section to provide project details; all fields are mandatory.		(a) Occupancy Single-Family Two-Family Other, please describe: 200 Residential units, 6 Commercial units
(a) Choose the proposed occupancy of the entire building. If not one- or two-family, provide a description of group(s) per code.		(b) Scope of Work New Construction Addition and/or Alteration Shell (No Fit Out) – Option for Commercial Permits Only
(b) Identify if the project will be new construction, an addition, or interior/exterior alterations.		(c) Earth Disturbance Area of Earth Disturbance 12,345 (Sq. Ft.)
(c) List the site area that will be disturbed by construction, if any. Enter 'zero' if no disturbance.		(d) Building Floor Areas
(d) Note the new floor area created, including basements, cellars, and	5	New Floor Area 106,623 (Sq. Ft.) Existing Altered Area 61,127 (Sq. Ft.)
occupiable roofs. Where existing areas will be altered, list those areas		(e) Number of Stories /
separately. (e) State the number of new or		(f) Description of Work Renovation of existing buildings and addition for use as (200) Residential units
affected stories. (f) Provide a detailed description of		and (6) commercial units - includes (42) off-street parking spaces
the work proposed.		(a) Project Conditions
(g) Select all conditions that apply to this project (if any).		(g) Project Conditions ✓ Project Impacts Street/Right-of-Way New High Rise ✓ Green Roof Included
		Modular Construction

Job Number. (for office use offly)
(PERMIT TYPE PREFIX – YEAR – NUMBER)

Project Details & Contractor Information		(a) Check all that apply: ✓ Building Mechanical & Fuel Gas Electrical I	Plumbing Fire Suppression
(a) Select all disciplines of work for which permits are being requested. If 'Building' is not requested, provide the number		Note: Trades listed below are mandatory for all residential new construction jobs.	P or CP-2 0 -
of the associated permit that was previously issued (where		Provide the associated Zoning Permit number for this construction, if applied	cable: ZP-2 0 19 - 9 0 5 9 2 5
applicable). If a Zoning Permit was issued for this work, provide		(b) General Building Construction Contractor Inf	
the related permit number. (b) Identify the general		AMR Contracting Inc.	Cost of Building Work \$ 18,000,000
contractor and estimated cost of building construction.		License Number 16600	Phone 6 1 0 8 3 4 7 5 0 0
(c) Identify the mechanical contractor, estimated cost of mechanical work, equipment		(c) Mechanical/Fuel Gas Work & Contractor Info	rmation
type, and quantity as: Number of registers/		Name	Cost of Mechanical Work \$
diffusers (separate new/relocated)		License Number	Cost of Fuel Gas Work \$
 Number of appliances Number of Type I / Type II kitchen hoods Where fuel gas work is included, 		Equipment Types: Registers / Diffusers Appliances Hoods	Phone
note the estimated cost of fuel gas work.		Equipment Detail & Quantities	
(d) Identify the licensed electrical contractor, estimated		(d) Electrical Work & Contractor Information	New Installation Alteration *Rough-In
cost of electrical work, and a registered third-party electrical inspection agency.		Name	Cost of Electrical Work \$
(e) Identify the registered master plumber, estimated cost of		License Number	Phone
plumbing work, number of fixtures, and check location of		Third-Party Inspection Agency Name	
work as: Interior Exterior Drainage and/or		(e) Plumbing Work & Contractor Information	New Installation Alteration *Rough-In
Water Distribution		Name	Cost of Plumbing Work \$
(f) Identify the licensed fire suppression contractor,		License Number	Phone
estimated cost of fire suppression work, and number of devices:		Check one:	Interior Work Exterior Building Drainage
 Sprinkler Heads (separate new/ 		Number of Fixtures	Exterior Water Distribution; line size (in.)
relocated quantities) • Standpipes		(f) Fire Suppression Work & Contractor Informat	ion New Installation Alteration *Rough-In
Fire PumpsStand-alone Backflow Prevention Devices		Name	Cost of Fire Supp. Work \$
 Kitchen Extinguishing Systems Hydrants 		License Number	Phone , , , , , , , , , , , , , , , , ,
*ROUGH-IN NOTICE: If you are seeking a rough-in permit, an		Sprinkler Heads: Standpipes:	Fire Pumps:
application for plan review must be submitted already.		Commercial Kitchen Systems: Backflow Devices	s: Hydrants:
eclaration & Signature			

D

All provisions of the Building Code and other City ordinances will be complied with, whether specified herein or not. Plans approved by the Department form a part of this application. I hereby certify that the statements contained herein are true and correct to the best of my knowledge and belief. I further certify that I am authorized by the owner to make the foregoing application, and that, before I accept my permit for which this application is made, the owner shall be made aware of all conditions of the permit. I understand that if I knowingly make any false statements herein, I am subject to such penalties as may be prescribed by law or ordinance, inclusive of the penalties contained in 18 Pa. C.S. § 4904

Applicant Signature:	Anthony Tsi	 07	, 13	,2021	




PHILADELPHIA HISTORICAL COMMISION FINAL SUBMISSION JULY 13, 2021

THE RUFO COMPANIES - TR GRETZ LP OWNER/DEVELOPER



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- A. EXISTING CONDITIONS: PHOTOS
- B. EXISTING CONDITIONS: DRAWINGS
- C. BUILDING 12: SUBMISSION FOR NON-CONTRIBUTING STATUS
 - D. ZONING SUBMISSION
- E. DESIGN RENDERINGS, LANDSCAPE, WINDOWS AND MATERIALS
 - F. FAÇADE RESTORATION DRAWINGS
 - G. ARCHITECTURAL DRAWINGS

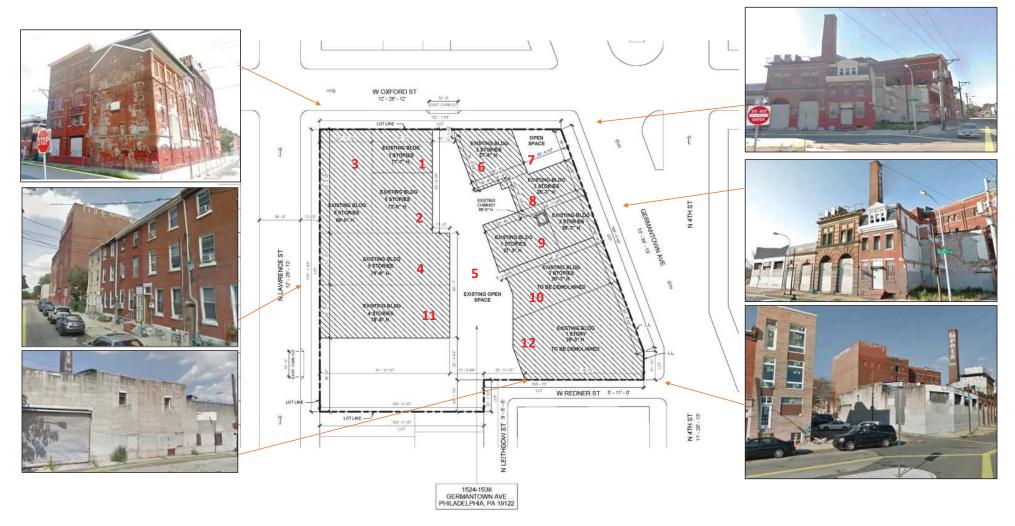

EXISTING CONTEXT

GRETZ BUILDING

PH-00



BIRD'S EYE VIEW - GERMANTOWN AVENUE 2017



BIRD'S EYE VIEW – OXFORD STREET 2017

EXISTING SITE PHOTOS





BIRD'S EYE VIEW - LAWRENCE STREET 2017

BIRD'S EYE VIEW - REDNER STREET 2017

EXISTING SITE PHOTOS









STREET VIEW - OXFORD ST (LOOKING WEST) 2018

EXISTING STREET VIEWS







STREET VIEW - N. LAWRENCE ST (LOOKING NORTH) 2018



STREET VIEW – N. LAWRENCE ST (LOOKING SOUTH) 2018

EXISTING STREET VIEWS







STREET VIEW - REDNER ST (LOOKING WEST) 2018




STREET VIEW - N. LEITHGOW ST (LOOKING NORTH) 2018

EXISTING STREET VIEWS





Building 1 Brew House

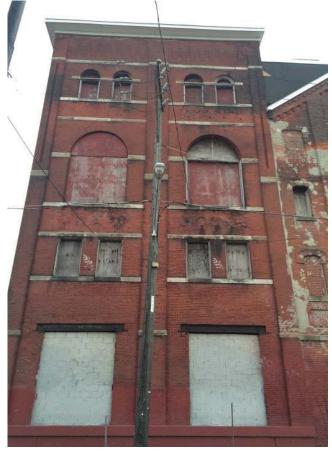

WEST FAÇADE – LAWRENCE STREET 2017



SOUTHEAST VIEW - 1970-80s



NORTH & EAST FACADES- LAWRENCE STREET 2017

THE RUFO COMPANIES - TR GRETZ LP OWNER/DEVELOPER

EXISTING BUILDING VIEWS



Building 2 Mill House







AERIAL VIEW - CONTEXT - 2018


THE RUFO COMPANIES - TR GRETZ LP OWNER/DEVELOPER


EXISTING BUILDING VIEWS





Building 3 Ice House

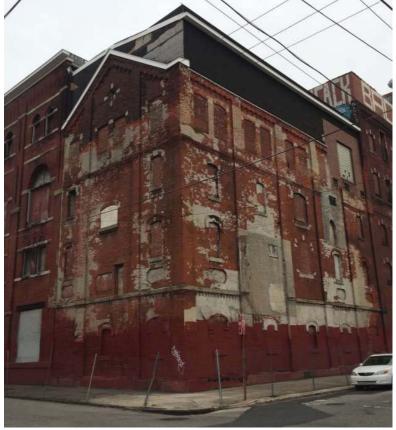

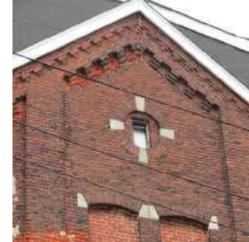







DATE STONE- 1885

HISTORIC CORNER VIEW - 1896


THE RUFO COMPANIES - TR GRETZ LP OWNER/DEVELOPER

EXISTING CORNER VIEW - 2018


EXISTING & HISTORIC BUILDING VIEWS



Building 4 Beer Cellar 1

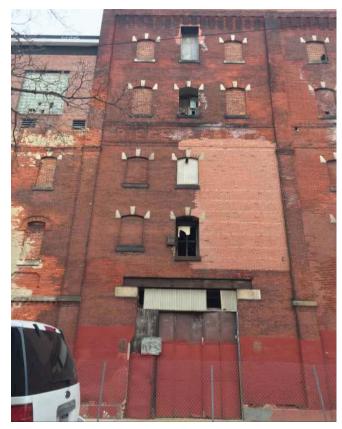

WEST FAÇADE – LAWRENCE STREET 2018

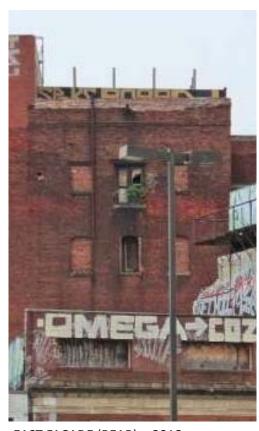

EAST FAÇADE (REAR) – 2018

THE RUFO COMPANIES - TR GRETZ LP OWNER/DEVELOPER

EXISTING BUILDING VIEWS



Building 5 Loading Shed





EXISTING COURTYARD - 2018

THE RUFO COMPANIES - TR GRETZ LP OWNER/DEVELOPER

EXISTING COURTYARD VIEWS



Building 6 Bottling House 1





NORTH FACADE- 2018

THE RUFO COMPANIES - TR GRETZ LP OWNER/DEVELOPER

EXISTING BUILDING VIEWS






Building 7 Tavern Demolished



PRE-DEMOLITION - 2013

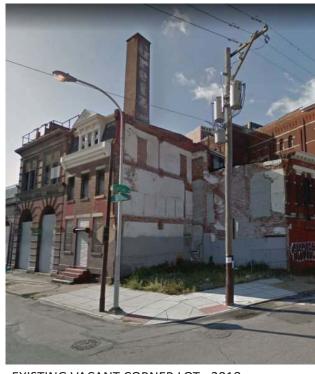

EXISTING VACANT CORNER LOT- 2018

THE RUFO COMPANIES - TR GRETZ LP OWNER/DEVELOPER

EXISTING BUILDING VIEWS



Building 8 Office



EXISTING EAST FAÇADE - 2018



EXISTING NORTH FAÇADE - 2018

THE RUFO COMPANIES - TR GRETZ LP OWNER/DEVELOPER

EXISTING BUILDING VIEWS



Building 9 Engine House



EXISTING SMOKESTACK - 2018



EAST FAÇADE - 2018






TERRA COTTA DETAILS - 2013

THE RUFO COMPANIES - TR GRETZ LP OWNER/DEVELOPER

EXISTING BUILDING VIEWS



Building 10 Bottling House 2

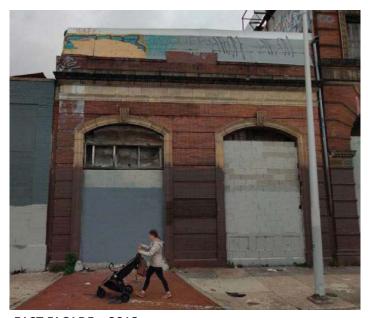

EAST FAÇADE - 2018



NORTHWEST VIEW - 1970-80s

THE RUFO COMPANIES - TR GRETZ LP OWNER/DEVELOPER

EXISTING & HISTORIC BUILDING VIEWS

GRETZ BUILDING




Building 11 Beer Cellar 2



WEST FAÇADE – 2018



WEST & SOUTH FACADES - 2018

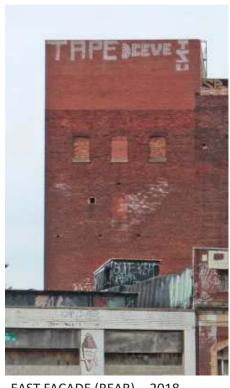

EAST FAÇADE (REAR) - 2018

THE RUFO COMPANIES - TR GRETZ LP OWNER/DEVELOPER

EXISTING BUILDING VIEWS



Building 12 Bottling House 3



REDNER ST VIEW - 2018



EXISTING VIEW - 2018



HISTORIC VIEW - 1940s-1950s

THE RUFO COMPANIES - TR GRETZ LP OWNER/DEVELOPER

EXISTING & HISTORIC BUILDING VIEWS

GRETZ BUILDING







T+ASSOCIATES INC. ARCHITECTS 525 S. 4TH ST, STE 591 PHILADELPHIA, PA 19147 T: 215.629.6374



P ENGINEER:

PHILADELPHIA HISTORICAL COMMISION -CONCEPT SUBMISSION

3-12-19

THE GRETZ COMPLEX 1524-1538 GERMANTOWN AVE PHILADELPHIA, PA 19122

PROVED BY: Author PPROVED BY: AT CALE: 1/8" = 1-0"

EXISTING SITE PLAN

DWG. NO.

3-12-19


THE GRETZ COMPLEX 1524-1538 GERMANTOWN AVE PHILADELPHIA, PA 19122

EXISTING CELLAR FLOOR

 \bigoplus^{N}

DWG. NO. **EX-100**

CELLAR FLOOR - EXISTING PLAN
EX-100 SCALE: 1/8" = 1'-0"

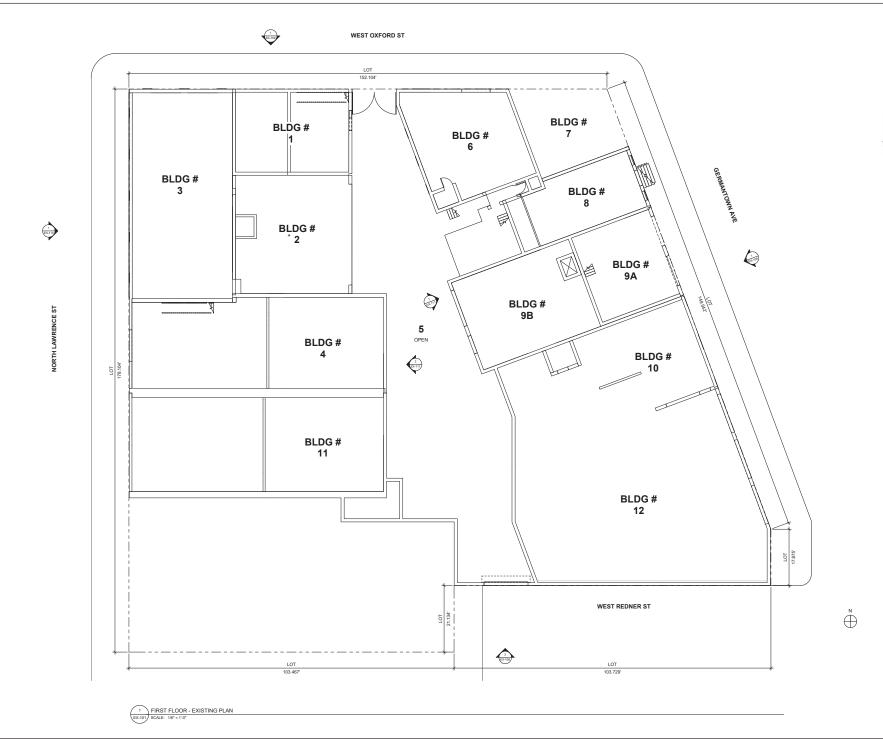



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MEP ENGINEER:

PHILADELPHIA HISTORICAL COMMISION -CONCEPT SUBMISSION

3-12-19

THE GRETZ COMPLEX 1524-1538 GERMANTOWN AVE PHILADELPHIA, PA 19122

RAWN BY: Author PPROVED BY: AT CALE: 1/8" = 1'-0"

EXISTING FIRST FLOOR

DWG. NO. EX-101

PHILADELPHIA HISTORICAL COMMISION -CONCEPT SUBMISSION

3-12-19

THE GRETZ COMPLEX 1524-1538 GERMANTOWN AVE PHILADELPHIA, PA 19122

EXISTING SECOND FLOOR

DWG. NO. **EX-102**

¥ BLDG# BLDG# BLDG# BLDG# 3 BLDG# BLDG# BLDG # 9A BLDG # 9B 5 OPEN BLDG# 2 2 2 2 ROOF BELOW BLDG # 10 BLDG# 11 ROOF BELOW BLDG# 12 2 EX-108

1 SECOND FLOOR - EXISTING PLAN

EX-102 SCALE: 1/8" = 1'-0"

1 23.100



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PHILADELPHIA HISTORICAL COMMISION -CONCEPT SUBMISSION

3-12-19

THE GRETZ COMPLEX 1524-1538 GERMANTOWN AVE PHILADELPHIA, PA 19122

EXISTING THIRD FLOOR

DWG. NO. **EX-103**

FOURTH FLOOR - EXISTING PLAN

(EX-104) SCALE: 1/8" = 1'-0"



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3-12-19

THE GRETZ COMPLEX 1524-1538 GERMANTOWN AVE PHILADELPHIA, PA 19122

EXISTING FOURTH FLOOR

DWG. NO. **EX-104**



T+ASSOCIATES INC. ARCHITECTS 525 S. 4TH ST. STE 591 PHILADELPHIA, PA 19147 T: 215.629.6374 ARCHITECTS SEAL:



PHILADELPHIA HISTORICAL COMMISION -CONCEPT SUBMISSION

3-12-19

THE GRETZ COMPLEX 1524-1538 GERMANTOWN AVE PHILADELPHIA, PA 19122

EXISTING FIFTH FLOOR DWG. NO. **EX-105**

1 FIFTH FLOOR - EXISTING FLOOR EX-105) SCALE: 1/8" = 1'-0"



T+ASSOCIATES INC. ARCHITECTS 525 S. 4TH ST, STE 591 PHILADELPHIA, PA 19147 T: 215.629.6374 ARCHITECTS SEAL:



PHILADELPHIA HISTORICAL COMMISION -CONCEPT SUBMISSION

3-12-19

THE GRETZ COMPLEX 1524-1538 GERMANTOWN AVE PHILADELPHIA, PA 19122

EXISTING SIXTH FLOOR

DWG. NO. **EX-106**



T+ASSOCIATES INC. ARCHITECTS 525 S. 4TH ST, STE 591 PHILADELPHIA, PA 19147 T: 215.629.6374 ARCHITECTS SEAL:




PHILADELPHIA HISTORICAL COMMISION -CONCEPT SUBMISSION

3-12-19

THE GRETZ COMPLEX 1524-1538 GERMANTOWN AVE PHILADELPHIA, PA 19122

DWG. NO. **EX-107**

EXISTING ROOF

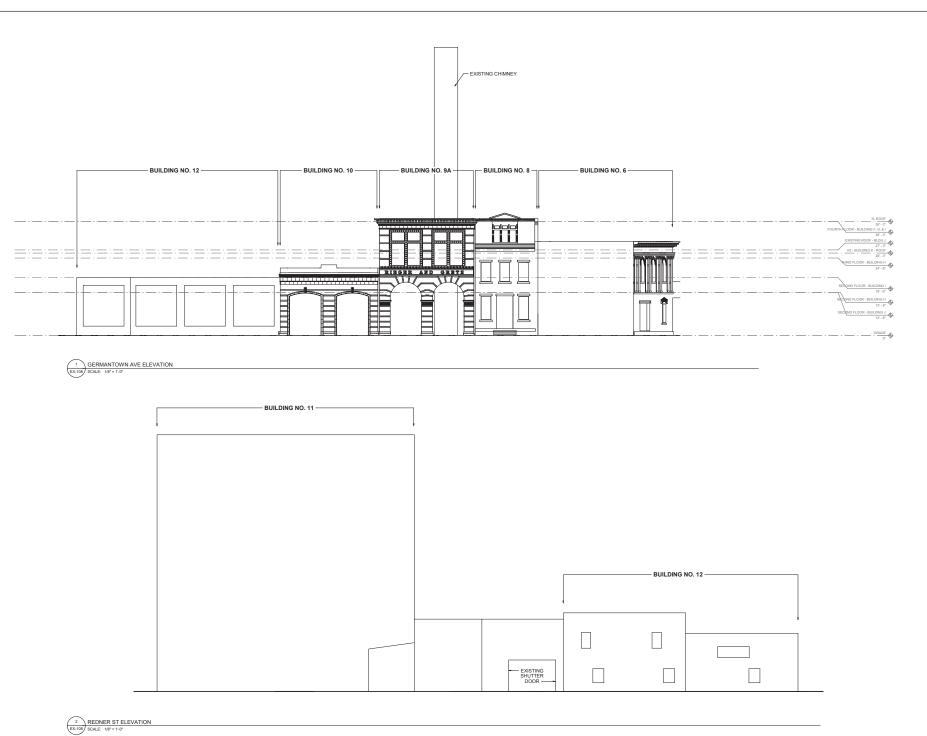

I+ASSOCIATES INC.

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MEP ENGINEER

PHILADELPHIA HISTORICAL COMMISION -CONCEPT SUBMISSION

3-12-19

THE GRETZ COMPLEX 1524-1538 GERMANTOWN AVE PHILADELPHIA, PA 19122

PROVED BY: AT CALE: 1/8" = 1'-0" DB#: 1405-012

EXISTING ELEVATION
DWG. NO.
EX-108

3-12-19


THE GRETZ COMPLEX 1524-1538 GERMANTOWN AVE PHILADELPHIA, PA 19122

EXISTING ELEVATION DWG. NO. **EX-109**



OXFORD ST ELEVATION

EX-109 SCALE: 1/8" = 1'-0"

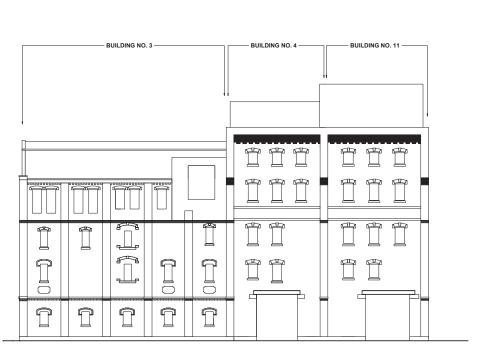





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PHILADELPHIA HISTORICAL COMMISION -CONCEPT SUBMISSION

3-12-19

THE GRETZ COMPLEX 1524-1538 GERMANTOWN AVE PHILADELPHIA, PA 19122

EXISTING ELEVATION DWG. NO. **EX-110** 1 EAST COURTYARD ELEVATION SCALE: 1/8" = 1'.0"



WEST COURTYARD ELEVATION
EX-111) SCALE: 1/8" = 1'-0"



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PHILADELPHIA HISTORICAL COMMISION -CONCEPT SUBMISSION

3-12-19

THE GRETZ COMPLEX 1524-1538 GERMANTOWN AVE PHILADELPHIA, PA 19122

EXISTING ELEVATION DWG. NO. **EX-111**


C

EXISTING FACADE TO BE REMOVED

EXISTING FAÇADE TO BE RESTORED

DEVELOPMENT TO DATE:

We are proposing a development of this site into a mixed-use complex with residential units, offices, studios, retail space and parking. After our initial design studies, we knew that we would need a zoning variance(s) to feasibly develop the site. We have submitted a zoning package seeking a refusal so we could continue to the Zoning Board of Adjustment for zoning variances. At the same time we began meeting with the RCO - South Kensington Community Partners and also submitted a preliminary package for Civic Design Review. We received notification of the Historical Nomination in the late September while these efforts were underway. We have immediately reached out to the PHC staff to share our intentions and discussed possible approaches to the renovation of the existing structures. Our intensions has always been to maintain 9 of 10 remaining structures on the site. See our proposed zoning plan on the following page.

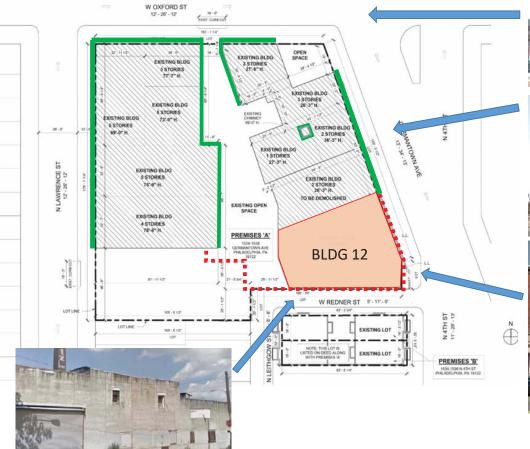







THE RUFO COMPANIES - TR GRETZ LP OWNER/DEVELOPER

EXISTING CONTEXT

GRETZ BUILDING

1.01

Building 12 – Old Bottling House

(built between 1944 – 1950)

Non contributing to historical character of the brewery site.

While our intention is to repair and restore all the remaining historical façade of the former Gretz Brewery buildings, we request that the building 12 - as labeled in the nomination package submitted by the Preservation Alliance for Greater Philadelphia - to be excluded from the historical designation. We believe the building 12 to be a non-contributing element of this historical site, for the following reasons:

- The building was the later addition to the brewery site by 40+ years and contains almost no historical characteristics besides the Germantown Ave. façade is a typical running bond brick wall however it was painted over since, and the original tall factory windows are filled in with CMU blocks and has no mullions remaining.
- 2. The most of the exterior wall along Redner street is CMU block wall and has been covered with stucco for a long time. This wall has a few openings most of which is filled in. The pattern and the sizes of the openings seemed to be done in a strictly functional purposes and shows no design intentions besides being source of ventilation for the bottling house.

There are also practical reasons why we ask building 12 to be excluded.

- The required on site parking garage to be accessed from the building 12 frontage along Germantown Ave. This is the only location to enter the garage without demolishing the more historically significant façade elsewhere on the site.
- The most of proposed multi-unit residential units are to be located over building 12 location. The development and restoration of this entire historical site depends on this portion to contain as much unit as possible.





Building 12

Building 12




Building 12

THE RUFO COMPANIES - TR GRETZ LP OWNER/DEVELOPER

NON-CONTRIBUTING ELEMENT

GRETZ BUILDING

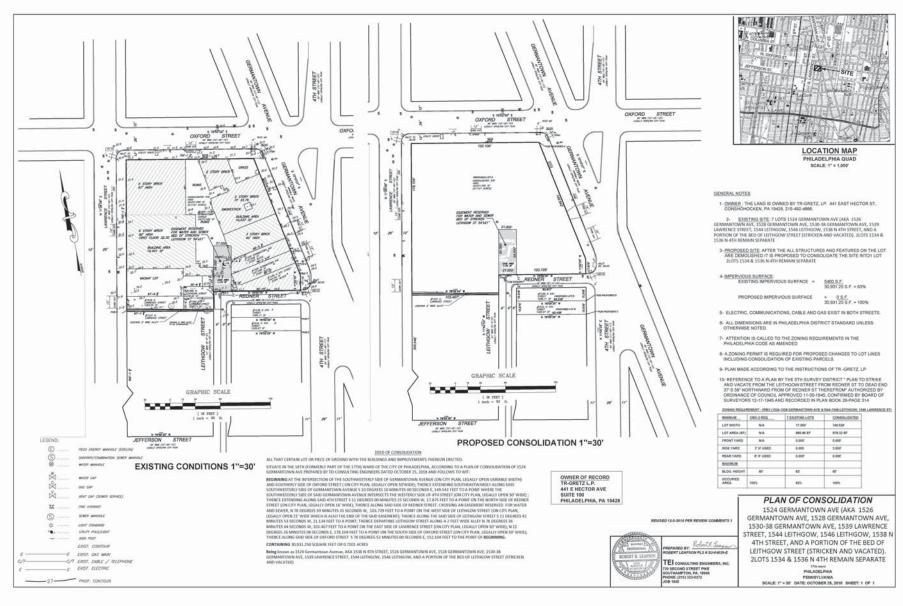

T+ASSOCIATES INC. ARCHITECTS 525 S. 4TH ST, STE 59



MEP ENGINEER

STRUCTURAL ENGINEER:

ZONING

SUBMISSION **REVISION 2** 12-11-18

SURVEYOR'S DWG. NO. C100

TTLE

IMAGE #1: VIEW FROM NE, OXFORD ST & GERMANTOWN AVE INTERSECTION (EXISTING CONDITIONS)



IMAGE #2: VIEW FROM NORTH, OXFORD ST & LAWRENCE ST INTERSECTION (EXISTING CONDITIONS)

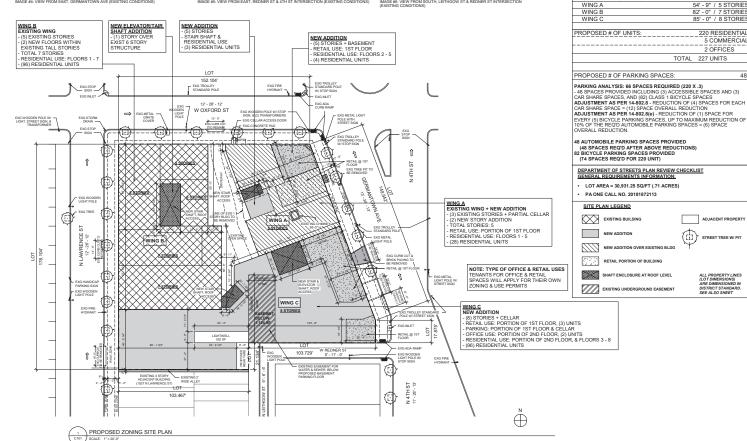


IMAGE #3: VIEW FROM SOLITH LAWRENCE ST (EXISTING CONDITIONS)



AGE #5: VIEW FROM EAST, REDNER ST & 4TH ST INTERSECTION (EXISTING CONDITIONS





VICINITY MAP

ZONING ANALYSIS: 1524-1538 GERMANTOWN AVE

PHILADELPHIA, PA 19122 DISTRICT

EXISTING LOT AREA:

EXISTING OPEN AREA

ALLOWARI E COVERAGE

MAX F.A.R. ALLOWABLE:

PROPOSED FLOOR AREA:

PROPOSED F.A.R.

WING A

WING A

WING B

WING C

WING

WING

ALLOWABLE HEIGHT EXISTING HEIGHT/STORIES

PROPOSED HEIGHT/STORIES

WING B

PROPOSED OPEN AREA (9.2%

MAX FLOOR AREA ALLOWABLE

EXISTING AREA PER BUILDING WING

PROPOSED AREA PER BUILDING WING



23 328 5 SE

(RETAIL/OFFICE = 1.877.3 SF

100,734.4 SF (RETAIL = 1,791.4 SF

(OFFICE = 944 SF

40' - 0" / 3 STORIES

82' - 0" / 5 STORIES 22' - 0" / 2 STORIES

54' - 9" / 5 STORIES

82' - 0" / 7 STORIES

85' - 0" / 8 STORIES

2 OFFICES

TOTAL 227 UNITS

5 COMMERCIAL

ADJACENT PROPERTY

STREET TREE W/ PIT

GERMANTOWN AVENUE FROM NORTH LAWRENCE STREET TO NORTH LEITHGOW STREET

MANDATORY NOTES:

IN WORK TO BE DONE IN ACCORDANCE WITH STANDARD SPECIFICATIONS, APPROVED DRAWINGS, AND REGULATIONS OF THE DEPARTMENT OF STREETS, PHILADELPHIA WATER DEPARTMENT, PHILADELPHIA PARKS & RECREATION DEPARTMENT, AND SPECIAL PROVISIONS OF THE PROPOSAL.

2. PURSUANT TO THE REQUIREMENTS OF PENNSYLVANIA CATE ST (1974), AND AS AMENDED, THE PENNSYLVANIA CATE ST (1974), AND AS AMENDED, THE CALL SYSTEM AT 1-800-242-175, AT LEASTS WORKING DAYS PRIOR TO EXCAVATION, PENNSYLVANIA ONE CALL SYSTEM AT 1-90-242-175, AT LEASTS WORKING DAYS PRIOR TO EXCAVATION, PENNSYLVANIA ONE CALL SYSTEM AT 1-90-242-175. SYSTEM # 20172961247 AND WARD # 39.

NOTE: THIS ITEM, ENGINEERING SERVICES, IS A PRE-DETERMINED AMOUNT TO BE DETERMINED BY THE SURVEYOR & REGULATOR AND TO BE INCLUDED IN THE CONTRACTOR'S BID.

8. THE CITY OF PHILADELPHIA SHALL PROVIDE INSPECTION SERVICES FOR PANING AND RELATED WORK. TO BE PADI HONER ITEM 8 4-104 AT A COST OF 5435 PER DAY, THE CONTRACTOR SHALL CONTACT THE CONSTRUCTION UNIT OF THE DIVISION OF SURVEYS, DESIGN 8. CONSTRUCTION AT (215) 588-5539, AMINIMUM OF 2 WEEKS PRIOR TO THE STRATO FOR WORK. THIS ITEM, INSPECTION SERVICES, SHALL BE

9. STREET LIGHT POLE LOCATIONS ARE NOT FINAL. THE STREETS DEPARTMENT STREET LIGHTING ENGINEER WILL DETERMINE THE EXACT LOCATIONS OF THE STREET LIGHTING ENGINEER AT (215) 688-5817 TO COORDINATE STREET LIGHTING ENGINEER AT (215) 688-5817 TO

10. FOR PROJECTS ON STATE ROUTES, NOTICE IS HEREBY GIVEN THAT THE RECEIPT OF A PERMIT FROM EITHER THE PHILADEL PHIA STREETS. DEPARTMENT, OR THE PENNSYLVANIA DEPARTMENT OF TRANSPORTATION (PENNDOT) DOES NOT IMPLY A PERMIT FROM THE OTHER. ALL PERMITS MUST BE OBTAINED PRIOR TO THE START OF CONSTRUCTION.

WORK LIMITS

SYSTEM # 20172961247 AND WARD# 39.

J UTILITIES SHOWN ARE TAKEN FROM PUBLIC RECORD.
THE CONTRACTOR MUST VERREY THE EXACT LOCATION
AND DEPTH.

4. PGW CONFIRMED EXISTING GAS LINES ARE NOT
LOCATED ON THE PROPERTY.
NEAREST GAS LINES ARE ACROSS ALL (3) ADJOINING
STREETS AND UNDER THE SIDEWALKS.

5. PERMITS FOR BOLLARDS, CURB, & SIDEWALK PAVING WILL BE FURNISHED BY THE [2] HIGHWAY DISTRICT OF THE CITY OF PHILADELPHIA.

6. STREET TREES MUST BE PERMITTED BY THE PHILADELPHIA DEPARTMENT OF PARKS & RECREATION. CONTACT THE STREET TREE MANAGEMENT DIVISION AT (215) 685-4363.

7. HORIZONTAL AND VERTICAL CONTROL, LINE AND GRADE STAKES FOR CURB, PAVING, ETC. WILL BE FURNISHED BY THE 2ND SURVEY DISTRICT OF THE CITY OF PHILADELPHIA BASED ON ITEM #4-1040.

ROW LOG NO.

DEPT. OF STREETS STAMP

PLAN SITE ZONING PROPOSED

C10, NO.

T+ASSOCIATES INC.

PHILADELPHIA PA 19147

ARCHITECTS

ARCHITECT'S SEAL

MEP ENGINEE

STRUCTURAL ENGINEER:

ZONING

SUBMISSION

REVISION 2

12-11-18

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E GRETZ COMPLI 1524-1538 GERMANTOWN AVE PHILADELPHIA, PA 19122

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525 S. 4TH ST, STE 59

RENDERINGS, LANDSCAPE, WINDOWS + MATERIALS DESIGN



Wing 'A':

Situated at the corner of Germantown Ave. and W. Oxford St. The existing façades to be fully restored and new structure to be added to on top and at the rear to create 5 story commercial space and residential units.

Wing 'B':

Situated at the corner of W. Oxford St. and N. Lawrence St.

The existing 5 story structures to be renovated to contain multiple residential units from ground floor to the top floor.

Wing 'C':

The wing C stretches along entire southern boundary of the property, between Germantown Ave. to N. Lawrence St. The only structure on this portion is the old bottling plant at south east corner which is to be demolished, and the adjacent structure on the north side which historical façade to remain and restored. West side of the wing C is currently a vacant lot. A new 7 story structure to be erected on this location that contains 1st floor retail spaces along Germantown Ave., parking on remainder of the 1st floor and basement level, and residential units 2nd floor to 8th floor.

THE RUFO COMPANIES - TR GRETZ LP OWNER/DEVELOPER

MASSING PROPOSAL

T + ASSOCIATES ARCHITECTS GRETZ BUILDING
1524 GERMANTOWN AVENUE, PHILADELPHIA, PA 1912

2.0





Vehicular Entrance / Exit

Secondary Pedestrian

SECOND FLOOR PLAN FIRST FLOOR PLAN

THE RUFO COMPANIES - TR GRETZ LP OWNER/DEVELOPER

FLOOR LAYOUT





REVISION #1

INCREASED SETBACKS AT NEW ADDITION OVER EXISTING BUILDINGS

REVISION #2

COLOR CHANGE ON ADDITIONS.

REVISION #3

COLOR CHANGE ON EXISTING ADDITIONS.

REVISION #4

GERMANTOWN AVE. AND OXFORD CORNER TOWER RECESSED AT UPPER LEVEL, AND DECORATIVE CANOPY ADDED TO RECALL ADJACENT MANSARD ROOF.

REVISION #5

GERMANTOWN AVE. FAÇADE DESIGN AND COLOR CHANGE.

THE RUFO COMPANIES - TR GRETZ LP OWNER/DEVELOPER

VIEW AT CORNER OF GERMANTOWN AVE. AND OXFORD ST.

GRETZ BUILDING
1524 GERMANTOWN AVENUE, PHILADELPHIA, PA 1912



VIEW AT CORNER OF GERMANTOWN AVE

T + ASSOCIATES ARCHITECTS GRETZ BUILDING



VIEW AT CORNER OF REDNER ST. AND GERMANTOWN AVE



VIEW AT CORNER OF OXFORD ST. AND LAWRENCE ST.



VIEW AT LAWRENCE ST.



VIEW AT REDNER ST. FAÇADE FROM GERMANTOWN AVE





OXFORD STREET ELEVATION

GERMANTOWN AVE. ELEVATION




REDNER STREET ELEVATION



LAWRENCE STREET ELEVATION

ELEVATION RENDERINGS

GRETZ BUILDING
1524 GERMANTOWN AVENUE, PHILADELPHIA, PA 1912

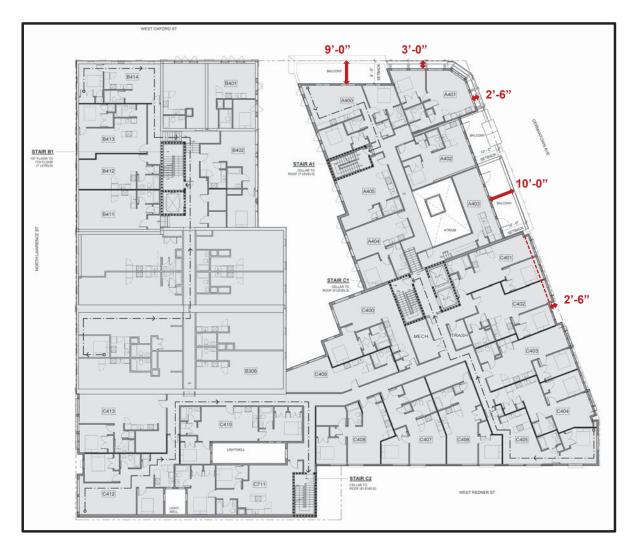


PHC ARCHITECTURAL COMMITTEE
REVIEW - UPDATED PAGES PER PHAC
COMMENTS 3-26-19

THE RUFO COMPANIES - TR GRETZ LP OWNER/DEVELOPER

SETBACKS AT OVERBUILT

GRETZ BUILDING
1524 GERMANTOWN AVENUE, PHILADELPHIA, PA 1912

LANDSCAPE FE	ATURES LEGEND	
Δ	DOOR ENTRANCE TO BUILDING	
-	NEW ADA CURB RAMPS	
	NEW CONCRETE SIDEWALK	
	NEW CONCRETE COURTYARD	
	NEW STAMPED CONCRETE (HEXAGONAL PATT	ERN)
STREET TREE M		200 400 400
LEGEND	SPECIFICATION	QTY.
◎ TR-1	GLEDITSIA TRIACANTHOS VAR. INERMIS - THORNLESS HONEYLOCUST	7
TR-2	PRUNUS SARGENTII "SPIRE" -	4
0	COLUMNAR SARGENT CHERRY	
TR-3	SHRUBS @ COURTYARD TALL GRASSES	8+/-
9	SHRUBS @ COURTYARD	8+/-
TR-3	SHRUBS @ COURTYARD TALL GRASSES SILVER BIRCH	
TR-3	SHRUBS @ COURTYARD TALL ORASSES SIL VER BIRCH (COURTYARD) SP-1 (N) - NEW STORMWATER PLANTER	7

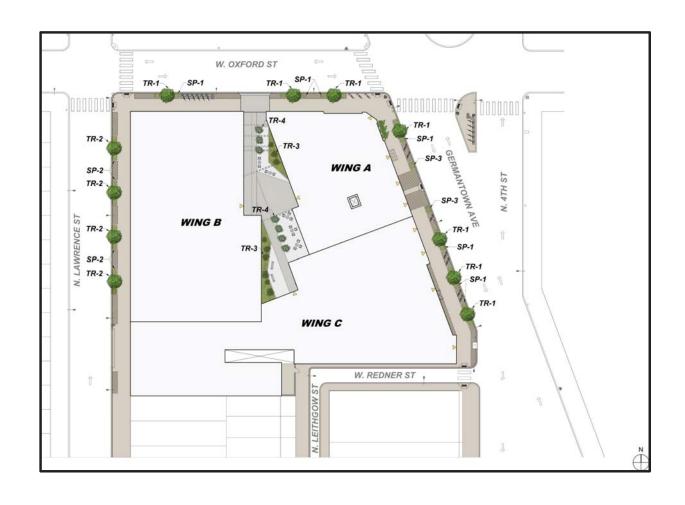

LANDSCAPE PLAN





EXTERIOR DESIGN VIEWS

T + ASSOCIATES ARCHITECTS GRETZ BUILDING


2.09

SUSTAINABLE MEASURES:

TRANSPORTATION

- BIKE SHARE STATIONS TO BE PROVIDED. OPTIONAL LOCATIONS ARE SHOWN IN PLAN.
- SIDEWALK BIKE RACKS TO BE PREOVIDED.
- THREE CAR SHARE PARKING IS PROVIDED ON SITE, SEE 2.07.

LEGEND	SPECIFICATION	QTY.
AR(N)	ACCESSIBLE (CURB) RAMP (NEW)	6
AR(E)	ACCESSIBLE (CURB) RAMP (EXISTING)	3
BS(N)	BIKE SHARE (NEW)	2 LOCATIONS
BR(N)	BIKE RACK (NEW)	10
CW(N)	CROSSWALK (NEW)	SEE PLAN
SL(E)	STREET LAMP (EXISTING)	7
SL(N)	STREET LAMP (NEW)	9
TS(N)	TRAFFIC SIGNAL (NEW)	3

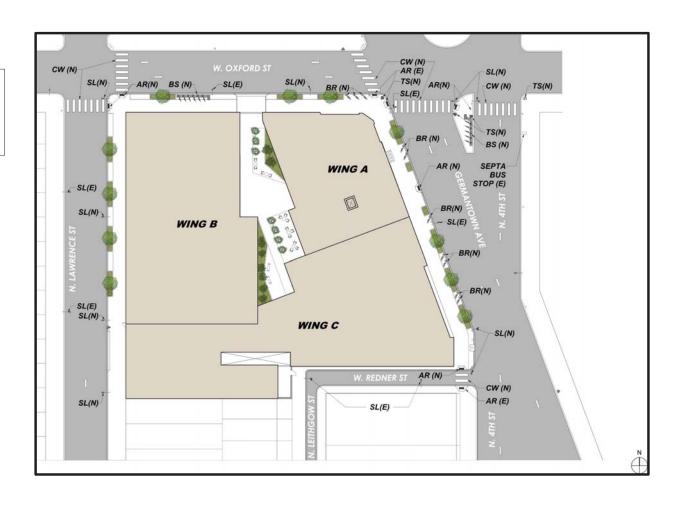

THE RUFO COMPANIES - TR GRETZ LP OWNER/DEVELOPER


SUSTAINABILITY 1-TRANSPORTATION

T + ASSOCIATES ARCHITECTS GRETZ BUILDING
1524 GERMANTOWN AVENUE, PHILADELPHIA, PA 19122

SUSTAINABLE MEASURES:

SUSTAINABLE SITE/BUILDING FEATURE

- ABOUT 40% OF TOTAL ROOF AREA TO BE GREEEN ROOF.
- RAINWATER COLLECTION BARRELS TO BE INSTALLED ON CPURTYARD FOR IRRIGATION OF VEGETATIONS ON SITE.
- STORMWATER MANAGEMENT REQUIREMENT BY PWD TO BE COMPLIED FULLY.
- SIDEWALKS AND COURYARD TO BE PAVED WITH HIGH ALBEDO MATERIALS, SUCH AS CONCRETE AND BRICKS.

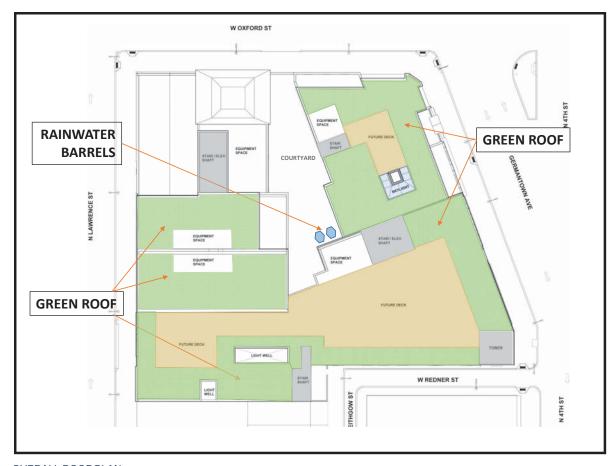

OVERALL ROOF PLAN


THE RUFO COMPANIES - TR GRETZ LP OWNER/DEVELOPER

SUSTAINABILITY 2 - SITE/BUILDING

GRETZ BUILDING
1524 GERMANTOWN AVENUE, PHILADELPHIA, PA 19122



OWNER/DEVELOPER

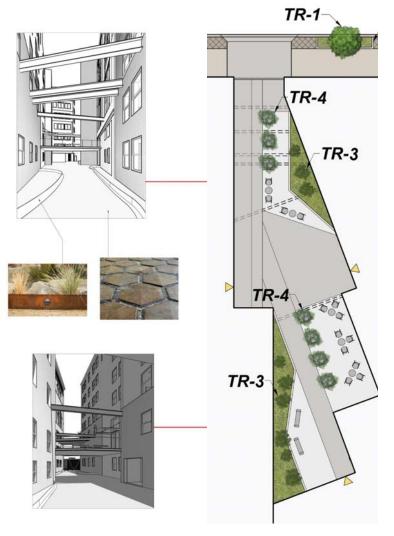

COURTYARD FEATURES:


- Planting areas with seasonal grasses, plants and flowers
- Silver Birch tree groupings in planters
- Seating areas with loose gravel
- Concrete circulation paths
- View of courtyard from Main Lobby and Oxford Street Gate

THE RUFO COMPANIES - TR GRETZ LP OWNER/DEVELOPER

COURTYARD PLAN





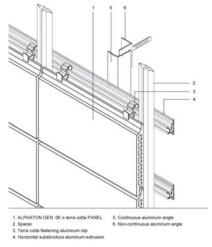


Terracotta Rainscreen Detail





Natural Red Rainscreen

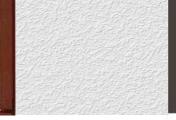

White Stucco



Dark Bronze Fenestration

Charcoal Grey Stucco

FAÇADE MATERIALS & ELEMENTS

100 SERIES WINDOWS & DOORS

DELIVER BEAUTY, PERFORMANCE & DURABILITY.

ATTRACTIVE CORNER SEAMS.

100 Series products feature low-visibility corner seams for a cleaner and more contemporary look.

COLORS THAT LAST.

Durable, factory-finished interiors and exteriors never need painting and won't fade, flake, blister or peel," even in extreme cold or heat.

ATTRACTIVE MATTE INTERIORS.

Premium matte finish isn't shiny like vinyl and is available in white, Sandtone, dark bronze and black."

ENERGY EFFICIENT IN EVERY CLIMATE.

Energy-efficient 100 Series products are available with options that make them ENERGY STAR® certified throughout the U.S., so they can help reduce heating and cooling bills. What's more, Fibrex® composite material blocks thermal transfer nearly 700 times better than aluminum.





DESIGNED FOR PERFORMANCE.

100 Series products are designed to meet or exceed performance requirements in all 50 states! See pages 103-104 for details.



EASY OPERATION FOR YEARS TO COME.

All 100 Series products are tested to the extreme to deliver years* of smooth, reliable operation

SUPERIOR WEATHER RESISTANCE.

Our weather-resistant construction seals out drafts, wind and water so well that your reputation is protected whatever the weather.

QUALITY SO SOLID, THE WARRANTY IS TRANSFERABLE."

Most other window and door warranties end when a home is sold, but our coverage — 20 years on glass, 10 years on non-glass parts — transfers from each homeowner to the next. And, because it's not prorated, the coverage offers full benefits, year after year, owner after owner for real added value.

OWNER2OWNER

FIBREX® MATERIAL

STRONG ON PERFORMANCE. GENTLE ON THE ENVIRONMENT.

Developed by Andersen, Fibrer® material is a revolutionary structural composite material that blends the very best attributes of virily and wood. Fibrer material saves on natural resources because it is composed of 40% reclaimed wood fiber by weight. Special polymen formulations surround and fill each wood fiber, enabling top performance. The result is a material that provides uncommon value and enhances the quality of any project. In use for over two decades in Andersen® products, Fibrer material has proven its strength and durability in all types of climates.

REVOLUTIONARY BUILDING MATERIAL

- Twice as strong as vinyl, so weathertight seals stay weathertight
- Blocks thermal transfer nearly 700 times better than aluminum to help reduce heating and cooling bills
- Retains its stability and rigidity in all climates for exceptional durability
- ... Offers superior scratch resistance compared to painted vinyl*

ENVIRONMENTALLY RESPONSIBLE

- Since Andersen developed the highly sustainable Fibrex material, reuse of waste wood fiber has prevented the harvesting of nearly 90 million board feet of timber
- 100 Series products can help builders earn LEED® points in three key categories.
 Energy & Atmosphere, Materials & Resources and Indoor Environmental Quality
- 100 Series products meet or exceed California Section 01350 Specification, a California indoor emission standard — one of the toughest in the country.
- Like all Andersen products, 100 Series products are designed to last[®] and help reduce future waste streams







See how Andersen created Fibrer material at andersenwindows.com/fibrex

- Vist anderserwindows.com/warranty for details.
 When tested against tive leading competitors' painted viryl window products
- ** When tested against rive leading competitors' painted viryl window products

4

Dark Bronze Fenestration



THE RUFO COMPANIES - TR GRETZ LP OWNER/DEVELOPER

** Units with DBM, GBM CRUZE of valuative transvariant recomments.

Seepuring of ode official for conference requirements in your lates.

11 DDB HS4085 DPUP IG +50,60 (AA MR-WOMA/CSA 101A.S.2/A440 Ob.S. +11), Optional PQSO Performance Uignade is available for most sizes.

WINDOWS AND STOREFRONTS

GRETZ BUILDING
1524 GERMANTOWN AVENUE, PHILADELPHIA, PA 1912

2.15

WINDOW & DOOR TYPES

CASEMENT & AWNING WINDOWS

Casement windows are hinged on the side and open outward to the left or right, while awning windows are hinged at the top and open outward. Both are also available as nonoperating stationary windows.









SINGLE-HUNG WINDOWS

Single-hung windows feature a fixed upper sash with an operable lower sash that slides up and down. For convenience, the hardware locks automatically when the window is closed. An arch single-hung is also available to add architectural interest.








GLIDING WINDOWS

Gliding windows have one stationary sash and one operating sash that glides horizontally. A three-sash configuration, where two sash glide past a fixed center sash, is also available.



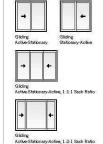

PICTURE, TRANSOM & SPECIALTY WINDOWS

Choose from a variety of shapes to make a signature statement or provide a delicate lighting accent. Shapes include arch, Springline," half circle, quarter circle and rectangular picture or transom windows. Custom shapes are also available including: full circle, triangle, trapezoid, pentagon, octagon and unequal leg arch windows.



GLIDING PATIO DOORS

Patio doors feature one stationary panel and one operating panel that glides smoothly on adjustable rollers. They feature a multi-point locking system for enhanced security and an optional exterior keyed lock for convenience. Sidelights and transoms are also available.





Dark Bronze




THE RUFO COMPANIES - TR GRETZ LP OWNER/DEVELOPER

WINDOWS AND STOREFRONTS

2.16

SINGLE-HUNG WINDOWS

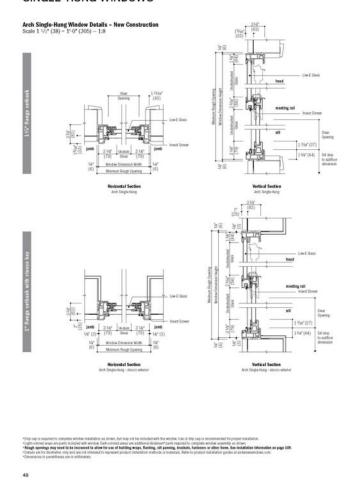





Hardware color matches the window's interior Optional Slim Line Metal Lock Antique Brass | Black | Dark Bronze Sandfone | Satin Nickel | White

Satin Nickel | White

windows which prevents opening the sash more than 4° (102). Available factory-installed or as a kit for field-application. Open/Closed Sensors Wireless open/closed sensors are available in white, Sandtone and dark bronze.

Vent Limiter A vent limiter is available for awning

Hardware

Grilles Grilles are available in a variety of configurations. See page 13 for details.

ACCESSORIES Sold Separately

Window Opening Control Device

A window opening control device is available for casement, single-hung and gliding windows which limits sash travel

to less than 4' (102) when the window is first opened. Available factory installed or as a kit for field-application.

Visit anderserwindows.com/varranty for details. Dimensions in parentheses are in millimeters. Printing limitations prevent exact replication of finishes. See your Andersen supplier for actual finish samples.

Insect Screens

For casement and awning windows, in sect screen frames are color matched

to the product interior. For single-hung and gliding windows, stainless steel springs hold the in sect screen tightly to the window frame and their frames are

available in colors to match the product exteriors. In sect screen's have chancoal gray liberglass screen mesh.

TruS cene® In sect Screen

Exclusive Andersen® TruScene in sect screen's provide over 50% more clarity than our conventional insect screen for a

more fresh air and sun light in, while

doing a better job of keeping out small in sects. Frame color for casement and awning windows matches the product

gliding matches the product exteriors

interiors. Frame color for single-hung and

Dark Bronze Fenestration


17

THE RUFO COMPANIES - TR GRETZ LP OWNER/DEVELOPER

WINDOWS AND STOREFRONTS



GLIDING PATIO DOORS

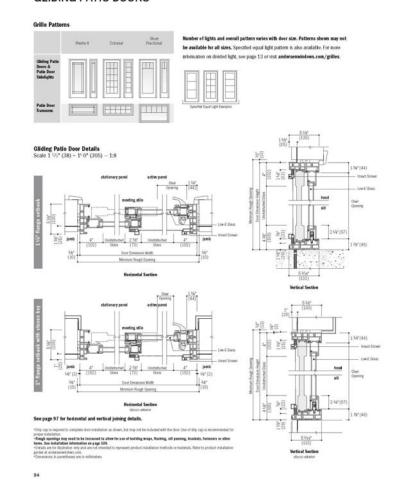


Dark Bronze Fenestration

THE RUFO COMPANIES - TR GRETZ LP OWNER/DEVELOPER

WINDOWS AND STOREFRONTS

GRETZ BUILDING
1524 GERMANTOWN AVENUE, PHILADELPHIA, PA 191

2.18

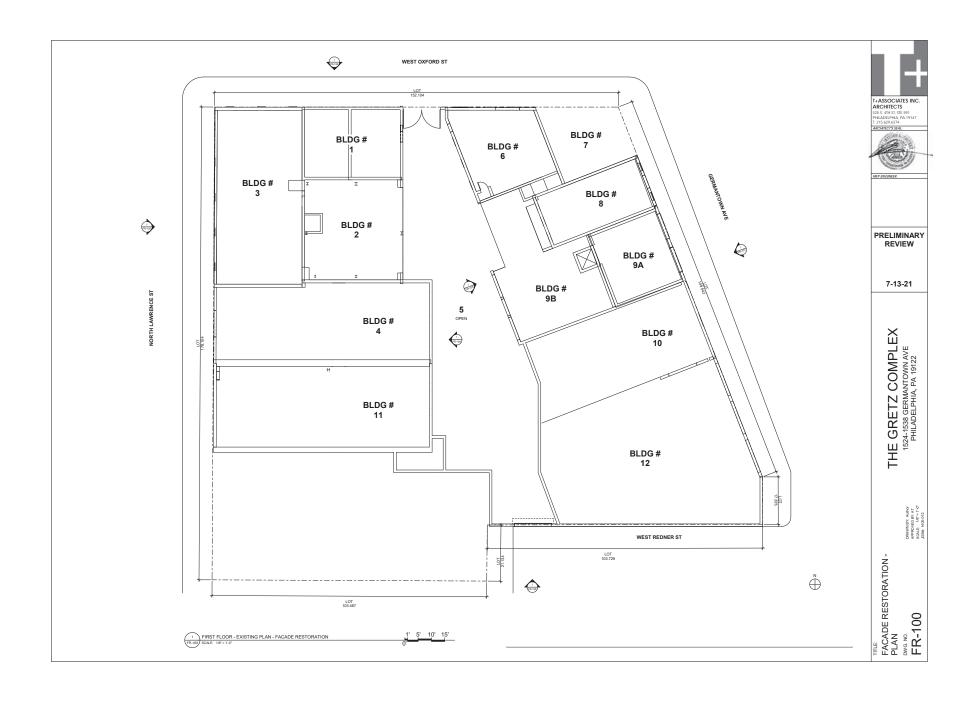

BUILDING 9A ENGINE HOUSE

EXISTING BUILDING VIEWS

TERRA COTTA DETAIL

0

0

BUILDING 10 BOTTLING HOUSE 2 EXISTING BUILDING VIEWS



EAST FACADE - 2018



TERRA COTTA DETAIL



TERRA COTTA DETAIL



EXISTING SMOKESTACK - 2018

EXISTING TERRA COTTA CORNICE



EAST FACADE - 2018

NEW METAL CAP ON CHIMNEY







EXISTING TERRA COTTA DETAILS







PRELIMINARY REVIEW

7-13-21

THE GRETZ COMPLEX 1524-1538 GERMANTOWN AVE PHILADELPHIA, PA 19122

FACADE RESTORATION - ELEVATION
DWG. NO.
FR-101

NOTE TAGS - FACADE RESTORATION PATCH EXISTING MASONRY, POINT AS REQ., TYP
 EXISTING BRICK TO BE POINTED W/FOLLOWING GRI
 (1) PART CEMENT, (2 1/2) PART LIME, (6/12) PART SAME
 TO MATCH ORIGINAL COLOR WALLS WITH GRAFFITI
 REMOVE PAINT
 CLEAN 3 * RESET & POINT EXISTING BRICK CORBELLING AS REQ., TYP * EXISTING MASONRY OPENINGS TO BE INFILLED
 * INFILL W/ SALVAGED MATCHING BRICK TOOTHING REMOVE AREA OF MISMATCHED BRICK
 RECONSTRUCT WITH SALVAGED BRICK TO
REMAINDER OF WALL
 RETAIN WINDOW LOCATIONS (2) EXISTING METAL CORNICE
- BONDO ANY HOLES, SAND, & PAINT ® REMOVE INFILL FROM ORIGINAL OPENINGS

EXISTING NORTH FACADE LEGEND - FACADE RESTORATION

WALLS TO BE DEMOLISHED


 CLEAN EXISTING STEEL HEADER, TYP
 HAND SCRAPE RUST OFF CLEAN EXISTING LINTEL & SILL, TYP
 BROWNSTONE, SPECIFY HOW TO CLEAN
 MARBLE, SPECIFY HOW TO CLEAN


(2) REPLACE OR PATCH & CLEAN EXISTING ROOF SHINGLES

(3) PATCH & CLEAN EXISTING STONE BAND, TYP 1. REMOVE PAINT 2. CLEAN

(4) EXISTING METAL COLUMN CAPITAL - BONDO ANY HOLES, SAND, & PAINT NEW OPENING TO BE PART OF SEPARATE P.H.C COMMIC COMMISSION REVIEW SET

NOTE: MASONRY RESTORATION
- SPOT POINT MASONRY W/ LESS THAN 30% DAMAGE
- RE-POINT MASONRY W/ MORE THAN 50% DAMAGE * PHC TO REVIEW SAMPLE FOR APPROVA

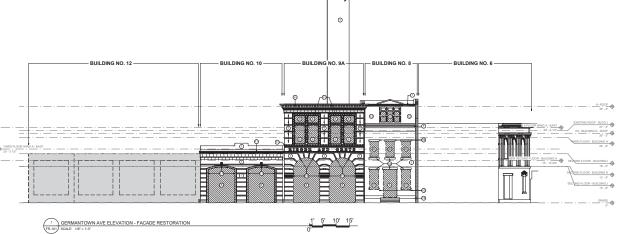

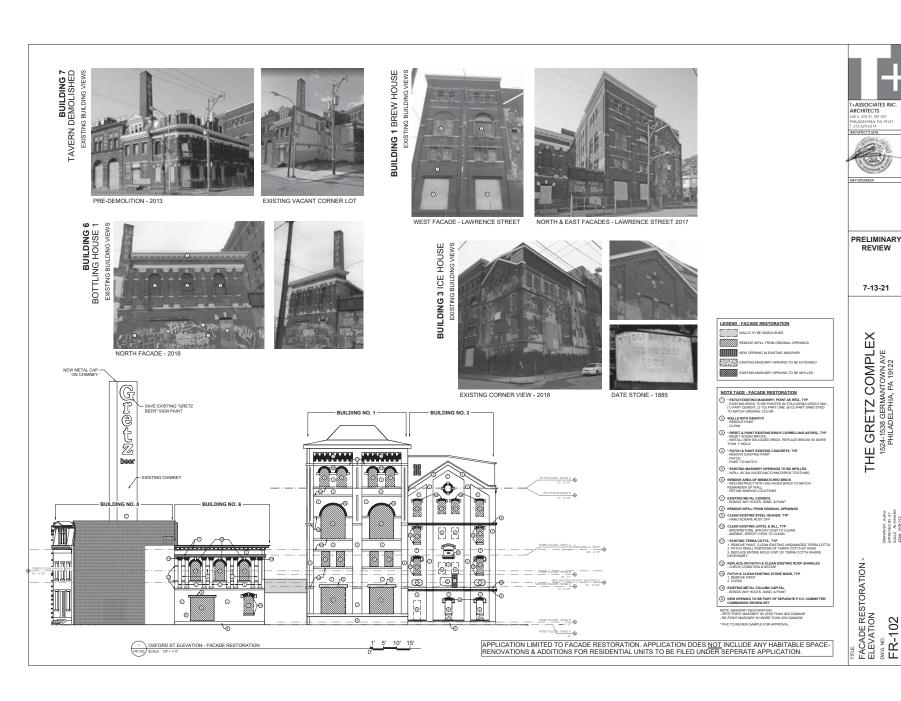

BUILDING 3 ICE HOUSE EXISTING BUILDING VIEWS



WEST FACADE - LAWRENCE STREET



BUILDING 4 BEER CELLAR 1

EXISTING BUILDING VIEWS

WEST FACADE - LAWRENCE STREET





BUILDING 11 BEER CELLAR 2

EXISTING BUILDING VIEWS

WEST & SOUTH FACADES - 2018



PRELIMINARY REVIEW

7-13-21

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FACADE RESTORATION -ELEVATION DWG. NO. FR-103



WEST FACADE - LAWRENCE STREET





WEST FACADE - LAWRENCE STREET



WEST FACADE - LAWRENCE STREET



* PATCH EXISTING MASONRY, POINT AS REQ., TYP
 - EXISTING BRICK TO BE POINTED W/ FOLLOWING GRO
 (1) PART CEMENT, (2 1/2) PART LIME, (6/12) PART SANC
 TO MATCH ORIGINAL COLOR



5 * EXISTING MASONRY OPENINGS TO BE INFILLED - INFILL W/ SALVAGED MATCHING BRICK TOOTHING

(8) REMOVE INFILL FROM ORIGINAL OPENINGS CLEAN EXISTING STEEL HEADER, TYP
 HAND SCRAPE RUST OFF

CLEAN EXISTING LINTEL & SILL, TYP
 BROWNSTONE, SPECIFY HOW TO CLEAN
 MARBLE, SPECIFY HOW TO CLEAN

*EXISTING TERRA COTTA , TYP
 . REMOVE PAINT, CLEAN EXISTING UNDAMAGED TERRA C 2. PATCH SMALL PORTIONS OF TERRA COTTA BY HAND
 3. REPLACE ENTIRE MOLD/UNIT OF TERRA COTTA WHERE NECESSARY

(2) REPLACE OR PATCH & CLEAN EXISTING ROOF S - CHECK CONDITION & DECIDE (3) PATCH & CLEAN EXISTING STONE BAND, TYP 1. REMOVE PAINT 2. CLEAN


(4) EXISTING METAL COLUMN CAPITAL - BONDO ANY HOLES, SAND, & PAINT


NOTE: MASONRY RESTORATION
- SPOT POINT MASONRY W/ LESS THAN 30% DAMAGE
- RE-POINT MASONRY W/ MORE THAN 50% DAMAGE * PHC TO REVIEW SAMPLE FOR APPROVAL



WEST FACADE - LAWRENCE STREET

WEST FACADE - LAWRENCE STREET

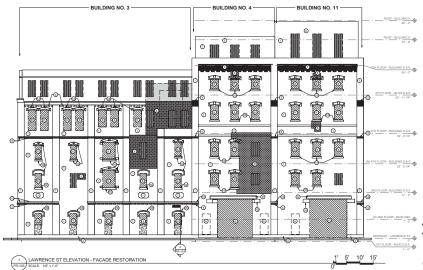

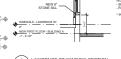

2 LAWRENCE ST WINDOW SECTION FR-103 SCALE: 1/4" = 1'-0"

LEGEND - FACADE RESTORATION WALLS TO BE DEMOLISHED EXISTING MASONRY OPENING TO BE INFILLED

NOTE TAGS - FACADE RESTORATION

- PATCH EXISTING MASONRY, POINT AS REQ., TYP
 EXISTING BRICK TO BE POINTED W/ FOLLOWING GROUT MIX
 (1) PART CEMENT, (2 1/2) PART LIME, (6/12) PART SAND DYED
 TO MATCH ORIGINAL COLOR
- ② WALLS WITH GRAFFITI
 REMOVE PAINT
 CLEAN
- * RESET & POINT EXISTING BRICK CORBELLING AS REQ., TYP
 RESET SOUND BRICKS
 INSTALL NEW SALVAGED BRICK, REPLACE BRICKS W/ MORE
 THAN 1" MOLD
- PATCH & PAINT EXISTING CONCRETE, TYP
 REMOVE EXISTING PAINT - PATCH - PAINT TO MATCH
- REMOVE AREA OF MISMATCHED BRICK
 RECONSTRUCT WITH SALVAGED BRICK T
 REMAINDER OF WALL
 RETAIN WINDOW LOCATIONS
- TENSING METAL CORNICE BONDO ANY HOLES, SAND, & PAINT
- (8) REMOVE INFILL FROM ORIGINAL OPENINGS
- CLEAN EXISTING STEEL HEADER, TYP
 HAND SCRAPE RUST OFF
- * EXISTING TERRA COTTA , TYP
 1. REMOVE PAINT, CLEAN EXISTING UNDAMAGED TERR
 2. PATCH SMALL PORTIONS OF TERRA COTTA BY HAND
 3. REPLACE ENTIRE MOLD/UNIT OF TERRA COTTA WHE
 NFFSRBYY
- (2) REPLACE OR PATCH & CLEAN EXISTING ROOF SHINGLES CHECK CONDITION & DECIDE
- PATCH & CLEAN EXISTING STONE BAND, TYP
 REMOVE PAINT
 CLEAN
- (4) EXISTING METAL COLUMN CAPITAL BONDO ANY HOLES, SAND, & PAINT
- (A) NEW OPENING TO BE PART OF SEPARATE P.H.C COMMITTEE/ COMMISSION REVIEW SET

* PHC TO REVIEW SAMPLE FOR APPROVAL

BUILDING 2 MILL HOUSE EXISTING BUILDING VIEWS



WEST FACADE (REAR)



WEST FACADE WINDOW (REAR)

BUILDING 4 BEER CELLAR 1

EXISTING BUILDING VIEWS



WEST FACADE



T+ASSOCIATES INC. ARCHITECTS

7-13-21

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THE GRETZ COMPLE 1524-1538 GERMANTOWN AVE PHILADELPHIA, PA 19122

ARCHITECT'S SEAL:

WEST FACADE (REAR)

PRELIMINARY **BUILDING 11 BEER CELLAR 2** REVIEW

EXISTING BUILDING VIEWS



WEST FACADE (REAR)






WEST FACADE (REAR)

BUILDING 1 BREW HOUSE (EAST FACADE)

EXISTING BUILDING VIEWS

WEST FACADE (REAR)

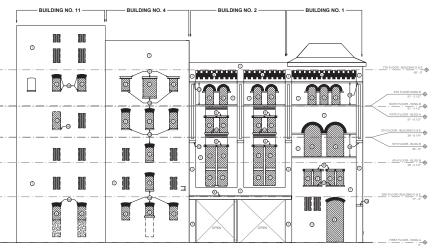

WEST FACADE WINDOW (REAR)

WEST FACADE (REAR)





WEST FACADE (REAR)



WEST FACADE WINDOW (REAR)



2 WEST COURTYARD ELEVATION - FACADE RESTORATION FR.104 SCALE: 18" = 1.0"



FACADE RESTORATION -ELEVATION DWG. NO. FR-104

BUILDING 6 BOTTLING HOUSE

EXISTING BUILDING VIEWS




BUILDING 8 OFFICE BUILDING

EXISTING BUILDING VIEWS

EAST FACADE (REAR)





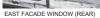

BUILDING 9B ENGINE ROOM EXISTING BUILDING VIEWS







EAST FACADE (REAR)

KS-BUILDING K-ROOF





EAST FACADE (REAR)

THE GRETZ COMPLEX 1524-1538 GERMANTOWN AVE PHILADELPHIA, PA 19122

T+ASSOCIATES INC. ARCHITECTS

525 S. 4TH ST, STE 591
PHILADELPHIA, PA 19147
T: 215.629.6374
ARCHITECTS SEAL:

PRELIMINARY

REVIEW

7-13-21

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REPLACE OR PATCH & CLEAN EXISTING ROOF SHIN - CHECK CONDITION & DECIDE

PATCH & CLEAN EXISTING STONE BAND, TYP
 REMOVE PAINT
 CLEAN



LEGEND - FACADE RESTORATION

NOTE TAGS - FACADE RESTORATION

*PATCH EXISTING MASONRY, POINT AS REQ., TYP
 -EXISTING BRICK TO BE POINTED W FOLLOWING GROUT MIX.
 (1) PART CEMENT, (2) PART LIME, (8/12) PART SAND DYED
 TO MATCH ORIGINAL COLOR

② WALLS WITH GRAFFITI
- REMOVE PAINT
- CLEAN

*RESET & POINT EXISTING BRICK CORBELLING AS REQ., TYP.
RESET SOUND BRICKS
- INSTALL NEW SALVAGED BRICK, REPLACE BRICKS W/ MORE THAN 1" MOLD

 PATCH & PAINT EXISTING CONCRETE, TYP
 REMOVE EXISTING PAINT - PATCH - PAINT TO MATCH

INFILL WI SALVAGED MATCHING BRUCK TO MATCH
 REMOVE AREA OF MISMATCHED BRICK TO MATCH
 RECONSTRUCT WITH SALVAGED BRICK TO MATCH
 REMAINDER OF WALL
 RETAIN WINDOW LOCATIONS

EXISTING METAL CORNICE
- BONDO ANY HOLES, SAND, & PAINT

® REMOVE INFILL FROM ORIGINAL OPENINGS CLEAN EXISTING STEEL HEADER, TYP
 HAND SCRAPE RUST OFF

(i) CLEAN EXISTING LINTEL & SILL, TYP
- BROWNSTONE, SPECIFY HOW TO CLEAN
- MARBLE, SPECIFY HOW TO CLEAN

NEW OPENING TO BE PART OF SEPARATE P.H
 COMMISSION REVIEW SET

1 EAST COURTYARD ELEVATION - FACADE RESTORATION FR.105 SCALE: 1/8" = 1'-0"

BUILDING NO. 6 -

- BUILDING NO. 8 -



- EXISTING CHIMNEY

BUILDING NO. 10 -


- BUILDING NO. 9B -

EAST FACADE (REAR) BUILDING NO. 12 -

COND FLOOR - BUILDING J

NOTE: MASONRY RESTORATION
- SPOT POINT MASONRY WILESS THAN 30% DAMAGE
- RE-POINT MASONRY WI MORE THAN 50% DAMAGE * PHC TO REVIEW SAMPLE FOR APPROVAL

FACADE RESTORATION -ELEVATION DWG. NO. FR-105

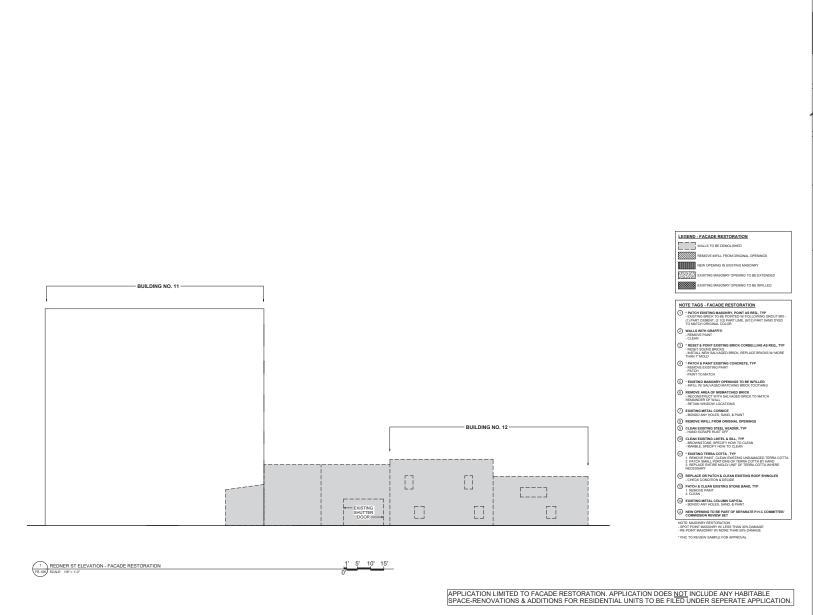

T+ASSOCIATES INC. ARCHITECTS 525 S. 4TH ST, STE 591 PHILADELPHIA, PA 19147 T: 215.629.6374 ARCHITECTS SEAL:

PRELIMINARY REVIEW

7-13-21

THE GRETZ COMPLEX 1524-1538 GERMANTOWN AVE PHILADELPHIA, PA 19122

FACADE RESTORATION - ELEVATION DWG.NG. FR-106

GRETZ BUILDING

1524 -1538 GERMANTOWN AVE. PHILADELPHIA, PA 19122



T+ASSOCIATES
ARCHITECTS
525 SOUTH 4TH ST, STE 591
PHILADELPHIA, PA 19147

		PHIA. 1:215	.ADELPHIA, PA 19147 15.629.6374
GENERAL PROJECT NOTES	ISSUE DATES PROJECT NO.1405-012	DRAWING LIST	HITECT'S SEAL:
	ISSUE FOR ZONING PERMIT 11/09/18		2
NORE SMAL CONFORM TO THE CONTRACT DOCUMENTS WISCHISCHED THE OWNERST-CONTRACT AGENTS AND THE COMBAN AND SHITMANDARM CONTROLS. AUTOMOT SHITMANDARM CONTROLS. TO SHITMANDARM CONTROLS	PHC CONCEPT DESIGN 3/12/19		
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REPORTED PROMPTLY. 19. AT SUBSTANTIAL COMPLETION OF THE WORK, THE COMPRACTOR SHALL INDIFFUSE OWNER, AND THE ARCHITECT			
AND PAY FEST FOR BUILDING DEPARTMENT AND OTHER ACREMY. PAPROVALS. FERMIS BINESS PREVIOUS FEED FOR BY OWNER, AND REFECTIONS, CORPS OF BANSACTIONS AND TO SEE FOR SERVICE AND EXPERTMENT AND AND EXPENSES. TO THE CONVERTIEND AT THE CONVERTION OF WORK.			
ALL CODE REQUIRED BYIS, ENT LIGHT, EMERGENCY CONCIDIOR INCLUDING, BUT NOT MAINTED INC. CONCIDIOR INCLUDING, BUT NOT MIMITED IO, LIGHT, ALABAS, SPRINLES F ANY, ETC. SHALL SE MANATURED IN OPERABLE CONCIDION INFORMOTHE AND OVERBLE CONCIDIONON.	FIRE PROTECTION NOTES: 1. AN AUTOMATIC SPRINKLER SYSTEM INSTALLED IN	STRUCTU	TURAL ENGINEER:
BE CORRECTIOS PAUL CONDINNET ALL WORK. SECULDADIS, REPORTANCE, REGULATION AND DESCRIPTION AND DESCRIP	ACCORDANCE WITH SECTION 903.3 IS REQUIRED THROUGHOUT AND SHALLB EIN ACCORDANCE WITH NFPA 13 FOR FLOORS 2, 3 & 4.		
6. THE CONTRACT AREA SHALL REMAIN SECURE 23. ALL WORK PERFORMED AND MATERIALS DURING CONSTRUCTION. SHALL MET THE HORIEST BADE STANDARDS.	SMOKE ALARMS SHALL BE INSTALLED IN OCCUPANCIES AS REQUIRED IN SECTIONS 907.2.9.1 AND 907.2.9.2.		
The GREAK CORRECTOR SHALL YERY ALL SEE CORRECTOR SHOWN AND SHALL YERY ALL SEE CORRECTOR SHOWN AND SHALL YER ALL SEE CORRECTOR SHOWN AND SHALL YER ALL YER ALL SHALL YER ALL SHALL YER ALL YER A	3. A MANUAL FIRE ALARM SYSTEM THAT ACTIVATES THE OCCUPANT NOTIFICATION SYSTEM IN ACCORDANCE WITH STATEMENT OF THE OCCUPANT OF THE OCCUPANCE SWIFEE ANY DWELLING UNIT OR SLEEPING UNIT IS LOCATED THREE OR MORE STORIES ABOVE THE LOWEST LEVEL OF EXT DISCHARGE.	PR	BUILDING RELIMINARY
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PROOF DE SIMMITTIÉS DA EL DIE CORRACCIOS BOAL VISIT EL COSTI MODI DE CONTRACTOR BOAL CONSIDERA AFFECTION DE PROFESSOR POLICIA. CONSIDERA AFFECT			5/15/19
10. CONTINUCED PARLY VIEW FOR STEEL DECORPOOR AND THE STEEL	PROJECT DATA		
11. INCOME THE ADMITS EXPENSES OF A PENTALAN PROCESS OF THE ADMITS AND ADMITS OF THE A	I. FROJECT I MANE: He GREIZ COMPLEX PROJECT I DOCATION: 1324 -1358 GESMANTOWN AVE., PREJOEEPHA PA 19122		.EX AVE
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13. CONTRACTOR SHALL REVIEW SHOP POWERING SECREE SIMMINGS OF HAN TO BE ARRESTED. THE ACCURATE NOTED. SHALL HOT REVIEW ANY SHAMITER, WISHOUL BE CONTRACTOR'S SECREE REVIEW STANSWEIT. 3. CLEANUP AND SAFETY KEEP PROJECT AREA.	NFPA 70-2017 , NATIONAL ELECTRIC CODE (PER 2018 IBC) INTERNATIONAL ENERGY CONSERVATION CODE 2018		O Fa
	INTERNATIONAL EXISTING BUILDING CODE 2018 INTERNATIONAL RES CODE 2009 INTERNATIONAL RES CODE 2018		0 ₹₹
IA SHO* BANNED SEMIN SHALL BE CORTISCUL RIBINEL. LEC COMPACTOR SHALL BE SEPECHBEL FOR MINEL. DIAMSOCIAC, CONDISMALON WITH ORDER TRACES, AND PROFISIT OF HIS OWNER, ETC., LANG REMORE AND A VACCIOUS AND BESTONES. MANUAL STATES AND A VACCIOUS AND BESTONES. REMORE THE AND A VACCIOUS AND BESTONES.	INTERNATIONAL PERCHANICAL CODE 2018 INTERNATIONAL PERCHANICAL CODE 2018 INTERNATIONAL PERCHANICAL CODE 7078 BUILDINGS AND FACILITIES 2018		二 照点
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PROJECT COMPLETION OR TO FORCE SUBSTITUTIONS.			1524-18 PHII
ABBREVIATIONS SYMBOLS	LOCATION MAP		F
	© Statement Control		
AFF ABOVE FINSHED FLOOR ISL LASEL 101	Processing Strategic Strat		
	Demonstrating Q Production that went the Research Colored Q E Best States AVI. D		thor AT 1-0"
	State Contract Contra		DRAWN BY: Author APPROVED BY: AT SCALE: 12" = 1:0" JOBB: 1405-012
CUR CLEAR OPG OPENING	and the second second second		AWN B PROVE ALE:
CONC. CONCINCE AND PARAMEL CONF. CONTROLOGY PAR. PARAMEL PARAM	Anaby Michael Common Co		E 6 8 8
DR DOOR P PADES	A. FIRITON SULLING		
EXIST EXISTING REV REVISION DETAIL INDICATION (II)	1 1 1 1 1 1 1 1 1 1 1 1 1 1 1 1 1 1 1		
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CIP CIPSUM WALL BOARD SID STANDARD DOOR SYMBOL	Administration from the second		Z
HVAC HEATING/VENTILLATION TELE TELEPHONE (00)			\exists
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JI JORE UR URNAL DETAILAREA NDICATION NOTE DIMENSIONS ARE TO NOCCOUL VEEL VERICAL VEEL VEEL VEEL VEEL VEEL VEEL VEEL VE	NEW PROPERTY OF THE PARTY OF TH		<u> </u>
	Parties of the state of the sta		က်င္ခဲ့သို
WC WATER CLOSE (A300) WW WISH WOOD DRWWING TITLE REVISION DELTA	The state of the s		PROJECT INFORMATION DWG NO. CS-1
1	Bodins High Stobal Sir Q		

- 1. WALL OPENINGS ALL WALL OPENINGS ARE IN COMPLIANCE WITH TABLE 705.8 OF 2009 IBC NOTE: NIPPA 13 SPRINKLER SYSTEM LISED THROUGHOUT BUILDING 2. ROOF COVERING ROOF COVERING CLASSIFICATION AS PER SECTION 1504 PF 2009 IBC: CLASS C (IIB CONSTRUCTION TYPE) 3. ROOF COVERING COVER CONSTRUCTION OF SPACE ON LOW SLOPE ROOF SHALL BE ENERGY STAR RATED AS HIGHLY REPLECTIVE AS PERP PHILADELPHIA BUILDING CODE B-1504.

 4. JOINT AND PENETRATION FIRE SYSTEM ALL JOINTS AND PENETRATIONS THROUGH OR IN-SECURITY WALLS, FLOORS AND FLOOR CEILING THROUGH OR IN-SECURITY WALLS, FLOORS AND FLOOR CEILING STRUCK OF THE STATION STANDARD WALL SHALL COMPLY WITH THE PERFORMANCE REQUIREMENTS OF ANALYDMA/CSA101/IS 2/440 PER 2009 IBC SECTION 1405.13 AND 1715.51. GC TO SUBMIT SPECIFICATIONS SHEET WHICH SHOW COMPLIANCE.

 6. MOKE ALARMS MULTIPLE STATION SMOKE ALARMS SHALL BE INSTALLED AND MAINTAINED. WHEN MORE THAN ONE SMOKE ALARMS SHALL BE INSTALLED WITHIN A MAINTAINED. WHEN MORE THAN ONE SMOKE ALARMS SHALL BE INSTALLED WITHIN A .
- SMOVE ALLANDS MOLLIFLE STATION SMOLE ALASMIS SHALLE DISTRICLED WITHIN A MAINTAINED, WHEN MORE THAN ONE SMOKE ALASM IS INSTALLED WITHIN A DWELLING UNIT THEY SHALL BE INTERCONNECTED IN SUCH A MANNER THAT THE ACTIVATION OF ONE ALASMI WILL ACTIVATE ALL THE ALASMIS IN THAT INDIVIDUAL UNIT. SMOKE ALASMIS SHALL BE INSTALLED IN ACCORDANCE WITH 2010 CITY OF
- UNIT, SMORE ALEMIS SHALL BE INSTALLED IN ACCORDANCE WITH 2010 CITY OF PHILADED PIATE FREE CODE FOR 27.12 12 AND BATHROOMS THAT DO NOT HAVE A WINDOW SHALL BE EQUIPPED WITH A MECHANICAL VENTILATION SYSTEM (EXHAUST FAM) WHICH ELHAUSTS AIR FROM THE TOLLETIZATHOOM WITHIN A DWELLING UNIT TO THE EXTERIOR WITHOUT RE-CIRCULATION TO ANY SPACE AS SPET THE PHILADELPHIA PROPERTY MAINTENANCE CODE SECTION PHI-403.2

OPEN PARKING GARAGE NOTES:

THERE WILL BE UNIFORMLY DISTRIBUTED OPENINGS ON (2) SIDES. OPENINGS MUST BE 20% OF TOTAL PERIMETER WALL.

ACCESSIBILITY NOTES:

- TOTAL NO. OF ACCESSIBLE UNITS:
 2% REQUIRED = (4) UNITS TO BE TYPE 'A'
 ALL OTHER UNITS ARE TYPE 'B', EXCEPT ONES ON FLOOR(S) OF EXISTING BUILDING(S) THAT ARE NOT SERVICED BY AN ELEVATOR DUE TO FLOOR LEVEL.
- SEE DWG SHEETS A-000, A-000 & A-000 FOR LOCATIONS
- 2. TOTAL NO. OF ACCESSIBLE PARKING SPACES = (3) REQUIRED, (3) PROVIDED SEE SHEET A-000 FOR LOCATIONS

ACCESSIBLITY

- TOTAL NO. OF TYPE A UNITS AS PER:
- I. IBC 1107 6.2: 2% OF 207 UNITS = (4) TYPE 'A' UNITS.
 TOTAL NO. OF ACCESSIBLE PARKING SPACES AS PER IBC 1106: (3)

MEANS OF EGRESS

- 1. STAIRWAYS SERVE OCCUPANT LOAD GREATER THAN 50 OCCUPANTS AND MUST BE 44" MIN. WIDTH.

 BE 44" MIN. WIDTH.

 STAIRWAYS MUST OF REQUIRED IN BILLIONISM (8) STORIES OR MORE PROVIDED IN BILLIONISM (8) STORIES OR MORE PROVIDED IN BILLIONISM (8) STORIES OR MORE PROVIDED IN BILLIONISM WING C A MALL NEW STAIRS TO HAVE (9) HOUR FIRE SEPARATION ENCLOSURE

 5. AREA OF REFUGE NOT REQUIRED AS PER 1007.3 EXCEPTION 5

 SECTION 1007.2 I ELEVA TO RECORDING.

 SERVING THE STAIR STAILLED IN ACCORDANCE
 WITH SECTION 903.3.1 IN FAPR -31). THE ELEVATOR SHALL NOT BE REQUIRED ON FLOORS PROVIDED WITH A HORIZONTAL EXIT AND LOCATED AT OR ABOVE THE LEVELS OF EATH DISCHARGE.

GRETZ BUILDING CODE ANALYSIS:

CONDITIONS:	DATA:		NOTES:		REFERENCE:
ZONING:	IRMX				CITY OF PHILADELPHIA
PROPOSED USE GROUP:	R-2 (MAIN OCCUPA	NCY)	CELLAR & FIRST FL PARKING LEVEL AS ACCESSORY TO R-2		IBC 2018 SECTION 310.2 RESIDENTIAL GROUP R-2
CONSTRUCTION TYPE:	TYPE III B		- NONCOMBUSTIBLI EXTERIOR WALL PERMITTED MAT INTERIOR BUILD - UNPROTECTED (B)	S; ANY CODE- ERIALS FOR ING ELEMENTS (III)	IBC2018 TABLE 601
ALLOWABLE HEIGHT/ STORIES	HEIGHT = 75' -0" STORIES = 5		AUTOMATIC SPRINE THROUGHOUT	(LER SYSTEM	IBC 2018 TABLE 504.3 IBC 2018 TABLE 504.4
PROPOSED HEIGHT/STORIES	HEIGHT = 74' - 10" STORIES = 7		AUTOMATIC SPRINE THROUGHOUT	LER SYSTEM	
ALLOWABLE AREA PER STORY	64,000 SF		AUTOMATIC SPRINE THROUGHOUT	LER SYSTEM	IBC 2018 TABLE 506.2
MAXIMUM PROPOSED AREA (PER STORY):	27,744 SF [EACH FLOOR AREA / ALLOWABLE AREA) 151 FLOOR - 0.43 150 FLOOR - 0.43 150 FLOOR - 0.43 151 FLOOR - 0.45 151 FLOOR - 0.55 151 FLOOR - 0.57 151 FLOOR - 0.27		SEE OCCUPANCY S	ECTION BELOW	IBC 2018 SECTION 506
	SUM OF EACH FACTOR	= 2.62 < 3			
FIRE-RESISTANCE RATING	S (HOURS):				
	BUILDING WING A:	BUILDING WING B:	BUILDING WING C:		
CONSTRUCTION TYPE:	III B	III B	III B		
PRIMARY STRUCTURAL FRAME:	0	0	0		IBC2018 TABLE 601
BEARING WALLS:					
EXTERIOR:	2	2	2		
INTERIOR:					IBC2018 TABLE 601
NONBEARING WALLS & PARTITIONS:	-				
EXTERIOR:	1	1	1		IBC2018 TABLE 602
	AT COURTYARD. FIRE SEPARATION DISTANCE LESS THAN 30' FOR OCCUPANCY R:	AT COURTYARD. FIRE SEPARATION DISTANCE LESS THAN 30 FOR OCCUPANCY R:	AT REDNER ST. FIRE SEPARATION DISTANCE LESS THAN 30 FOR OCCUPANCY R:		IBCZUTO TABLE 002
INTERIOR (UNITS & HALL):	0.5	0.5	0.5		IBC2018 SECTION 708.3 EXCEPTION 2
INTERIOR (OTHER):	0	0	0		
FLOOR CONSTRUCTION SEPARATING DWELLING UNITS FROM PARKING & COMMERCIAL	1	1	1		IBC2018 TABLE 508.4
FLOOR CONSTRUCTION SEPARATING DWELLING UNITS	0.5	0.5	0.5		IBC2018 SECTION 711.2.4.3
ROOF CONSTRUCTION & SECONDARY MEMBERS:	0	0	0		
OCCUPANCY					
BUILDING WING NO.	A	В	С		OCCUPANT LOAD PER FLOOR
CELLAR FLOOR AREA:	950.0	0.0	13,148 (parking)		14,098 / 200 = 70.49 OR 71
FIRST FLOOR AREA:	5,365.5	10,080.5	12,298.0		27,744 / 200 = 138.7 OR 139
SECOND FLOOR AREA:	4,174.7	7,387.3	11,966.0		23,528 / 200 = 117.6 OR 118
THIRD FLOOR AREA:	4,541.0	8,007.0	12,006.5		24,554.5 / 200 = 122.7 OR 123
FOURTH FLOOR AREA:	4,008.0	10,082.0	12,062.5		26,152.5 / 200 = 130.76 OR 131
FIFTH FLOOR AREA:	4,008.0	10,082.0	12,062.5		26,152.5 / 200 = 130.76 OR 131
SIXTH FLOOR AREA:		10,082.0	12,062.5		22,144.5 / 200 = 110.72 OR 111
SEVENTH FLOOR AREA:		5,487.0	11,987.3		17,474.3 / 200 = 87.37 OR 88
					OCCUPANCY TOTAL = 912
TOTAL AREA PER BUILDING:	23,047.2 SF	61,207.8 SF	97,593.3 SF		181,848.9 TOTAL BUILDING SF
MEANS OF EGRESS:					•
TRAVEL DISTANCE:	250' - 0" (F	ULLY SPRINKLED)			IBC2018 TABLE 1017.2
# OF EXITS PER FLOOR:		MINIMUM		IBC2018 SECTION 1006	
EGRESS WIDTH PER OCCUPA	NT SERVED:				
STAIRWAYS @ 0.3" PER OCC	-				
REQUIRED - 131 (max. oc PROPOSED - 44" (Require	cupant on a floor) X 0.3				IBC2018 SECTION 1005 IBC2018 SECTION 1011.2
OTHER EGRESS COMPONENT REQUIRED - 912 (occupar PROPOSED - 12 (egress d	S (EGRESS DOORS) @	0.2" PER OCCUPAN			IBC2018 SECTION 1005
		und floor) X 36" (door	width) = 432"		IBC2018 SECTION 1005

- NOTES:


 1. DEMISING WALL BETWEEN UNITS MUST BE 1HR FIRE-RATED (2 HR PROVIDED)

 2. DEMISING WALL BETWEEN CORRIDOR AND UNIT MUST BE 1HR FIRE-RATED

 3. ALL EXTERIOR WALLS MUST BE OF NON-COMBUSTIBLE MATERIAL REGARDLESS OF FIRE-RATING: ALL WOOD MUST BE FIRE-REATINE AS PER ASTINE 48 WI MAN AT LAME SPREAD DE 2.5, FIRE-RETARDANT TREATED WOOD FRAMING COMPLYING WITH SECTION 2003.2 SHALL BE PERMITTED WITHIN EXTERDIOR WALL ASSEMBLIES OF A 2-HOUR RATING OR LESS—PIRE 2004 CODE SECTION 402.3 FOR TYPE III CONSTRUCTION)

 SEE PARTITION TYPE XX ON SHEET A-XXX.

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DOOR TYPES & FRAMES

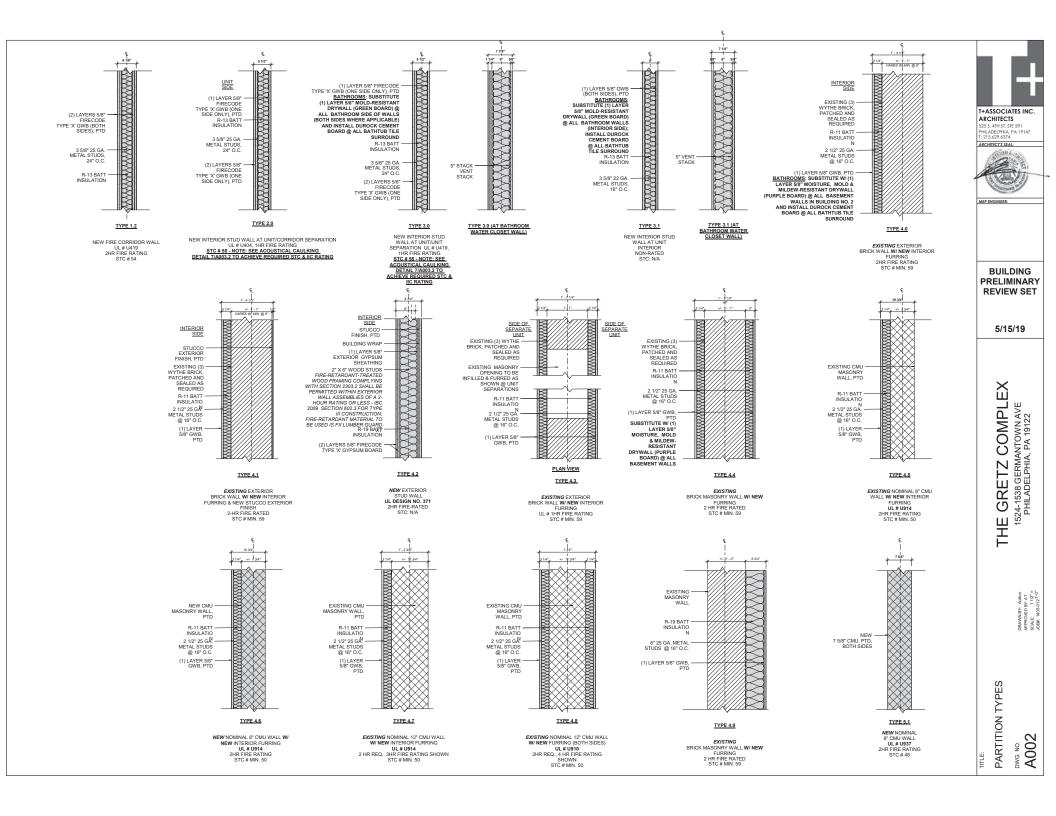SCALE: 3/8" = 1'-0"



DOOR TYPE 1 90 MIN-RATED (B-LABEL)

HOLLOW METAL (HM) FLUSH PAINT FINISH (PTD)

FRAME TYPE A-1

90 MIN-RATED KNOCKED-DOWN

HARDWARE SET (BRUSHED US26 FINISH)

DOOR CLOSER LOCKSET EXIT PANIC BAR



UNIT ENTRANCE DOORS (INTERIOR FIRE-RATED) DOOR TYPE 2

20 MIN-RATED SINGLE FLUSH HOLLOW METAL (HM) FLUSH PAINT FINISH (PTD)

FRAME TYPE B

20 MIN-RATED KNOCKED-DOWN HOLLOW METAL (KDHM) FLUSH PAINT FINISH (PTD)

HARDWARE SET (BRUSHED US26 FINISH) HINGE WALL STOP DEADBOLT LOCK LEVER HANDLE



UNIT ENTRANCE DOORS (EXTERIOR FIRE-RATED) DOOR TYPE 2.1

20 MIN-RATED SINGLE FLUSH GALVANIZED INSULATED STEEL (GALV STL) FLUSH PAINT FINISH (PTD)

FRAME TYPE B-1

20 MIN-RATED
GALVANIZED KNOCKED-DOWN
HOLLOW METAL (KDHM)
FLUSH PAINT FINISH (PTD)

HARDWARE SET (BRUSHED US26 FINISH)

GASKETED THRESHOLD SPRING HINGES HINGE WALL STOP DEADBOLT LOCK LEVER HANDLE



ENTRANCE DOORS (EXTERIOR FIRE-RATED) BLDGS 2 & 3W

DOOR TYPE 3 90 MIN-RATED (B-LABEL)

SINGLE FLUSH GALVANIZED INSULATED STEEL (GALV STL) FLUSH PAINT FINISH (PTD)

FRAME TYPE A-2

90 MIN-RATED GALVANIZED KNOCKED-DOWN HOLLOW METAL (KDHM) FLUSH PAINT FINISH (PTD)

HARDWARE SET (BRUSHED US26 FINISH)

GASKETED THRESHOLD SPRING HINGES HINGE WALL STOP DEADBOLT LOCK LEVER HANDLE



COMMON-AREA DOORS (INTERIOR NON-RATED)

DOOR TYPE 4

NON-RATED SINGLE FLUSH HOLLOW METAL (HM) FLUSH PAINT FINISH (PTD)

FRAME TYPE C-1

NON-RATED KNOCKED-DOWN HOLLOW METAL (KDHM) FLAT PAINT FINISH (PTD)

HARDWARE SET (BRUSHED US26 FINISH

SPRING HINGES LOCKSET/DEAD BOLT LEVER HANDLE



DOOR TYPE 4.1

NON-RATED BI-SWING FLUSH HOLLOW METAL (HM) FLUSH PAINT FINISH (PTD)

FRAME TYPE C-2

NON-RATED

HARDWARE SET (BRUSHED US26 FINISH)

SPRING HINGES LOCKSET LEVER HANDLE



DOOR TYPE 5

NON-RATED SINGLE FLUSH SOLID-CORE WOOD (WD) PAINT FINISH (PTD)

FRAME TYPE C-1

NON-RATED HOLLOW METAL (KDHM) FLAT PAINT FINISH (PTD)

HARDWARE SET (BRUSHED US26 FINISH)

HINGE WALL STOP BEDROOM & BATHROOM PRIVACY LOCKS LEVER HANDLE



UNIT-INTERIOR DOORS

DOOR TYPE 5.1


NON-RATED BI-SWING FLUSH SOLID-CORE WOOD (WD) PAINT FINISH (PTD)

FRAME TYPE C-2

NON-RATED KNOCKED-DOWN HOLLOW METAL (KDHM) FLAT PAINT FINISH (PTD)

HARDWARE SET (BRUSHED US26 FINISH)

HINGE WALL STOP DUMMY/INACTIVE LEVER HANDLE MAGNET LATCHES

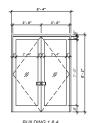

ENTRANCE/VESTIBULE DOORS

DOOR TYPE 6

NON-RATED NON-RATED DOUBLE BRONZE/ALUM & GLASS (BRNZ AL/GL) ANODIZED FINISH (ANOD) W/ 1/4" TEMPERED GLASS

FRAME TYPE E

BRONZE/ALLIM (BRNZ AL/GL) (BRONZE-ANODIZED FINISH (BR-ANOD))

HARDWARE SET (BRONZE OR SIMILAR FINISH)

CLOSER W/ HOLD OPEN ARM SILENCER SILENCER
FLUSHBOLTS
SPECIAL LITE HINGES
LOCKSET
EXIT PADDLE DEADLATCH
WALL BUMPER
SPECIAL LITE HANDLE BOTH SIDES



BUILDING 1 SIDE ENTRY DOOR @ RAMP

DOOR TYPE 6.1

NON-RATED SINGLE BRONZE/ALUM & GLASS (BRNZ AL/GL) BRONZE-ANODIZED FINISH (BR-ANOD) W/ 1/4" TEMPERED GLASS

HARDWARE SET (BRONZE OR SIMILAR FINISH)

CLOSER W/ HOLD OPEN ARM

SILENCER
SPECIAL LITE HINGES
LOCKSET
EXIT PADDLE DEADLATCH

WALL BUMPER SPECIAL LITE HANDLE BOTH SIDES

FRAME TYPE E-1

RRONZE/ALLIM (BRNZ AL/GL)

(BRONZE-ANODIZED FINISH (BR-ANOD))

HARDWARE SET (BRUSHED US26 FINISH)

SPRING HINGES HINGE WALL STOP DEADBOLT LOCK LEVER HANDLE

BLIII DING 1

GYM DOORS

DOOR TYPE 7

NON-RATED

SOLID-CORE WOOD & SINGLE-LITE GLASS FRENCH DOORS (WD/GL)

FRAME TYPE C-1

NON-RATED

KNOCKED-DOWN HOLLOW METAL (KDHM)

FLAT PAINT FINISH (PTD)

20 MIN. RATING FOR DOORS ON FLOORS



BUILDING 1 BALCONY DOORS

DOOR TYPE 7.2

NON-RATED HOLLOW METAL & SINGLE-LITE INSULATED GLASS FRENCH DOOR

FRAME TYPE C-1

20 MIN RATED KNOCKED-DOWN HOLLOW METAL (KDHM)

HARDWARE SET (BRUSHED US26 FINISH)

GASKETED THRESHOLD SPRING HINGES HINGE WALL STOP DEADBOLT LOCK LEVER HANDLE

BUILDING 1 COMMON/MEDIA ROOM DOORS

DOOR TYPE 7


NON-RATED SOLID-CORE WOOD & SINGLE-LITE GLASS FRENCH DOORS (WD/GL)

FRAME TYPE C2

NON-RATED KNOCKED-DOWN HOLLOW METAL (KDHM) FLAT PAINT FINISH (PTD)

HARDWARE SET

PATCH HINGES (US26 FINISH) ADA COMPLIANT WIRE PULL

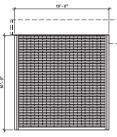

OPEN PARKING GARAGE DOORS

DOOR TYPE 8

NON-RATED EXTERIOR GARAGE GALVANIZED STEEL DOOR

FRAME TYPE F

NON-RATED GALVANIZED STEEL

HARDWARE SET

MOTORIZED CLOSER WITH MANUAL CHAIN

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MEP ENGINEER:

BUILDING

PRELIMINARY

REVIEW SET

5/15/19

FRAME ∞ಶ TYPES DOOR 1

A004

DOOR TYPES & FRAMES

SCALE: 3/8" = 1'-0"



DOOR TYPE 1 90 MIN-RATED (B-LABEL)

HOLLOW METAL (HM) FLUSH PAINT FINISH (PTD)

FRAME TYPE A-1

90 MIN-RATED KNOCKED-DOWN

HARDWARE SET (BRUSHED US26 FINISH)

DOOR CLOSER LOCKSET EXIT PANIC BAR



UNIT ENTRANCE DOORS (INTERIOR FIRE-RATED) DOOR TYPE 2

20 MIN-RATED SINGLE FLUSH HOLLOW METAL (HM) FLUSH PAINT FINISH (PTD)

FRAME TYPE B

20 MIN-RATED KNOCKED-DOWN HOLLOW METAL (KDHM) FLUSH PAINT FINISH (PTD)

HARDWARE SET (BRUSHED US26 FINISH) HINGE WALL STOP DEADBOLT LOCK LEVER HANDLE



UNIT ENTRANCE DOORS (EXTERIOR FIRE-RATED) DOOR TYPE 2.1

20 MIN-RATED SINGLE FLUSH GALVANIZED INSULATED STEEL (GALV STL) FLUSH PAINT FINISH (PTD)

FRAME TYPE B-1

20 MIN-RATED
GALVANIZED KNOCKED-DOWN
HOLLOW METAL (KDHM)
FLUSH PAINT FINISH (PTD)

HARDWARE SET (BRUSHED US26 FINISH)

GASKETED THRESHOLD SPRING HINGES HINGE WALL STOP DEADBOLT LOCK LEVER HANDLE



ENTRANCE DOORS (EXTERIOR FIRE-RATED) BLDGS 2 & 3W

DOOR TYPE 3 90 MIN-RATED (B-LABEL)

SINGLE FLUSH GALVANIZED INSULATED STEEL (GALV STL) FLUSH PAINT FINISH (PTD)

FRAME TYPE A-2

90 MIN-RATED GALVANIZED KNOCKED-DOWN HOLLOW METAL (KDHM) FLUSH PAINT FINISH (PTD)

HARDWARE SET (BRUSHED US26 FINISH)

GASKETED THRESHOLD SPRING HINGES HINGE WALL STOP DEADBOLT LOCK LEVER HANDLE



COMMON-AREA DOORS (INTERIOR NON-RATED)

DOOR TYPE 4

NON-RATED SINGLE FLUSH HOLLOW METAL (HM) FLUSH PAINT FINISH (PTD)

FRAME TYPE C-1

NON-RATED KNOCKED-DOWN HOLLOW METAL (KDHM) FLAT PAINT FINISH (PTD)

HARDWARE SET (BRUSHED US26 FINISH

SPRING HINGES LOCKSET/DEAD BOLT LEVER HANDLE



DOOR TYPE 4.1

NON-RATED BI-SWING FLUSH HOLLOW METAL (HM) FLUSH PAINT FINISH (PTD)

FRAME TYPE C-2

NON-RATED

HARDWARE SET (BRUSHED US26 FINISH)

SPRING HINGES LOCKSET LEVER HANDLE



DOOR TYPE 5

NON-RATED SINGLE FLUSH SOLID-CORE WOOD (WD) PAINT FINISH (PTD)

FRAME TYPE C-1

NON-RATED HOLLOW METAL (KDHM) FLAT PAINT FINISH (PTD)

HARDWARE SET (BRUSHED US26 FINISH)

HINGE WALL STOP BEDROOM & BATHROOM PRIVACY LOCKS LEVER HANDLE



UNIT-INTERIOR DOORS

DOOR TYPE 5.1


NON-RATED BI-SWING FLUSH SOLID-CORE WOOD (WD) PAINT FINISH (PTD)

FRAME TYPE C-2

NON-RATED KNOCKED-DOWN HOLLOW METAL (KDHM) FLAT PAINT FINISH (PTD)

HARDWARE SET (BRUSHED US26 FINISH)

HINGE WALL STOP DUMMY/INACTIVE LEVER HANDLE MAGNET LATCHES

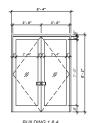

ENTRANCE/VESTIBULE DOORS

DOOR TYPE 6

NON-RATED NON-RATED DOUBLE BRONZE/ALUM & GLASS (BRNZ AL/GL) ANODIZED FINISH (ANOD) W/ 1/4" TEMPERED GLASS

FRAME TYPE E

BRONZE/ALLIM (BRNZ AL/GL) (BRONZE-ANODIZED FINISH (BR-ANOD))

HARDWARE SET (BRONZE OR SIMILAR FINISH)

CLOSER W/ HOLD OPEN ARM SILENCER SILENCER
FLUSHBOLTS
SPECIAL LITE HINGES
LOCKSET
EXIT PADDLE DEADLATCH
WALL BUMPER
SPECIAL LITE HANDLE BOTH SIDES



BUILDING 1 SIDE ENTRY DOOR @ RAMP

DOOR TYPE 6.1

NON-RATED SINGLE BRONZE/ALUM & GLASS (BRNZ AL/GL) BRONZE-ANODIZED FINISH (BR-ANOD) W/ 1/4" TEMPERED GLASS

HARDWARE SET (BRONZE OR SIMILAR FINISH)

CLOSER W/ HOLD OPEN ARM

SILENCER
SPECIAL LITE HINGES
LOCKSET
EXIT PADDLE DEADLATCH

WALL BUMPER SPECIAL LITE HANDLE BOTH SIDES

FRAME TYPE E-1

RRONZE/ALLIM (BRNZ AL/GL)

(BRONZE-ANODIZED FINISH (BR-ANOD))

HARDWARE SET (BRUSHED US26 FINISH)

SPRING HINGES HINGE WALL STOP DEADBOLT LOCK LEVER HANDLE

BLIII DING 1

GYM DOORS

DOOR TYPE 7

NON-RATED

SOLID-CORE WOOD & SINGLE-LITE GLASS FRENCH DOORS (WD/GL)

FRAME TYPE C-1

NON-RATED

KNOCKED-DOWN HOLLOW METAL (KDHM)

FLAT PAINT FINISH (PTD)

20 MIN. RATING FOR DOORS ON FLOORS



BUILDING 1 BALCONY DOORS

DOOR TYPE 7.2

NON-RATED HOLLOW METAL & SINGLE-LITE INSULATED GLASS FRENCH DOOR

FRAME TYPE C-1

20 MIN RATED KNOCKED-DOWN HOLLOW METAL (KDHM)

HARDWARE SET (BRUSHED US26 FINISH)

GASKETED THRESHOLD SPRING HINGES HINGE WALL STOP DEADBOLT LOCK LEVER HANDLE

BUILDING 1 COMMON/MEDIA ROOM DOORS

DOOR TYPE 7


NON-RATED SOLID-CORE WOOD & SINGLE-LITE GLASS FRENCH DOORS (WD/GL)

FRAME TYPE C2

NON-RATED KNOCKED-DOWN HOLLOW METAL (KDHM) FLAT PAINT FINISH (PTD)

HARDWARE SET

PATCH HINGES (US26 FINISH) ADA COMPLIANT WIRE PULL

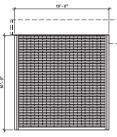

OPEN PARKING GARAGE DOORS

DOOR TYPE 8

NON-RATED EXTERIOR GARAGE GALVANIZED STEEL DOOR

FRAME TYPE F

NON-RATED GALVANIZED STEEL

HARDWARE SET

MOTORIZED CLOSER WITH MANUAL CHAIN

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MEP ENGINEER:

BUILDING

PRELIMINARY

REVIEW SET

5/15/19

FRAME ∞ಶ TYPES DOOR 1

A004

		MATERIAL				
ROOM	FLOOR	BASE	WAL	LS	CEILING	REMARKS
ENTRY/ HALL	FL-1	WB-1	P-	1	P-1	
CLOSET	FL-1	WB-1	P-	1	P-1	
KITCHEN	FL-1	WB-1	P-	1	P-1	
LIVING	FL-1	WB-1	P-	1	P-1	
BATHROOM	FL-1 V	WB-1	@ WALLS @ TUB		WT-2 ONLY @ WALLS SURROUNDING TUB, SEE TYPICAL INTERIOR	
			P-2	WT-2	P-2	BATHROOM ELEVATIONS ON SHEET A-000 FOR LOCATION
BEDROOM	FL-1	WB-1	P-	1	P-1	

TYPICAL LIST OF INTERIOR FINISHES - COMMON AREA							
TAG/NO.	MATERIAL/ DESCRIPTION	FINISH	MANUFACTURER	NO.	COLOR	LOCATIONS/COMMENTS	
P-3	WALL PAINT	TBD	TBD	TBD	WHITE		
P-4	WALL PAINT	TBD	TBD	TBD	WHITE		
WB-1	MDF WALL BASE	PRIMED, PAINT	TBD	TBD	WHITE		
FL-2	CARPET TILE	PRE-FINISHED	MOHAWK	TBD	TBD		

MATERIAL								
LOCATION	FLOOR	BASE	WALLS	CEILING	REMARKS			
PARKING GARAGE	EXG. CONCRETE	N/A	PAINT	PAINT				
PARKING GARAGE	EXG. CONCRETE	N/A	PAINT	PAINT				
BLDG WING								
CORRIDOR	FL-1	WB-1	P-3	P-3				
CORRIDOR	FL-1	WB-1	P-3	P-3				
CORRIDOR	FL-1	WB-1	P-3	P-3				
CORRIDOR	FL-1	WB-1	P-3	P-3				
BLDG WING								
CORRIDOR	FL-1	WB-1	P-3	P-3				
EXIT PASSAGE	FL-1	WB-1	P-3	P-3				
CORRIDOR	FL-1	WB-1	P-3	P-3				
EXIT PASSAGE	FL-1	WB-1	P-3	P-3				
CORRIDOR	FL-1	WB-1	P-3	P-3				
BLDG WING								
CORRIDOR	FL-1	WB-1	P-3	P-3				
EXIT PASSAGE	FL-1	WB-1	P-3	P-3				
EXIT PASSAGE	FL-1	WB-1	P-3	P-3				
EXIT PASSAGE	FL-1	WB-1	P-3	P-3				
EXIT PASSAGE	FL-1	WB-1	P-3	P-3				
BLDG WING								
ELEV. LOBBY CORRIDOR	FL-1	WB-1	P-3	P-3				
ELEV. LOBBY CORRIDOR	FL-1	WB-1	P-3	P-3				
EXIT PASSAGE	FL-1	WB-1	P-3	P-3				
ELEV. LOBBY CORRIDOR	FL-1	WB-1	P-3	P-3				
EXIT PASSAGE	FL-1	WB-1	P-3	P-3				
ELEV. LOBBY CORRIDOR	FL-1	WB-1	P-3	P-3				
EXIT PASSAGE	FL-1	WB-1	P-3	P-3				
ELEV. LOBBY CORRIDOR	FL-1	WB-1	P-3	P-3				
EXIT PASSAGE	FL-1	WB-1	P-3	P-3				
UTILITY ROOMS	FL-1	WB-1	P-3	P-3				
MAINTENANCE ROOMS	FL-1	WB-1	P-3	P-3				

CEILING NOTE #2: BLDG ____ EXPOSED EXISTING STRUCTURE PAINTED W/ P-1

CEILING NOTE #3: BLDG ______ EXPOSED EXISTING STRUCTURE PTD (EXCEPT BATHROOMS)

CEILING NOTE #3: BLDG ____ EXPOSED EXISTING STRUCTURE PTD

ASSOCIATES INC

T+ASSOCIATES INC. ARCHITECTS 525 S. 4TH ST, STE 591 PHILADELPHIA, PA 19147 T: 215.629.6374



AED ENGINEED


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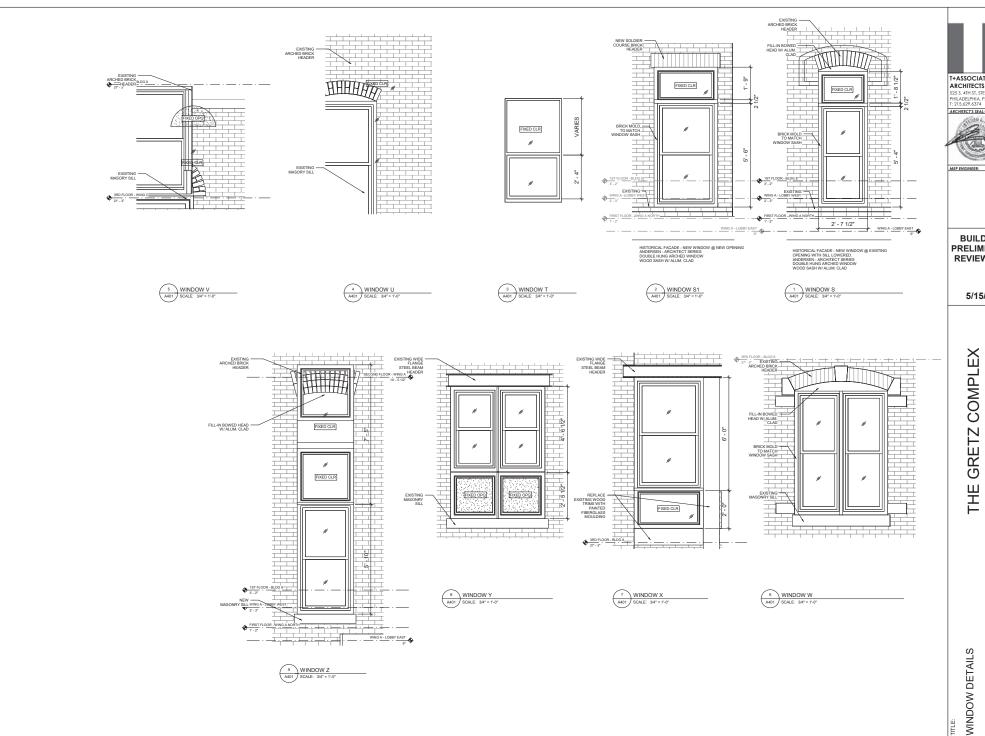
5/15/19

THE GRETZ COMPLEX 1524-1538 GERMANTOWN AVE PHILADELPHIA, PA 19122

PROVED BY: Author PROVED BY: AT ICALE: 1/4" = 1'-0"

FINISHES SCHEDULE
DOWG.NO.
A005



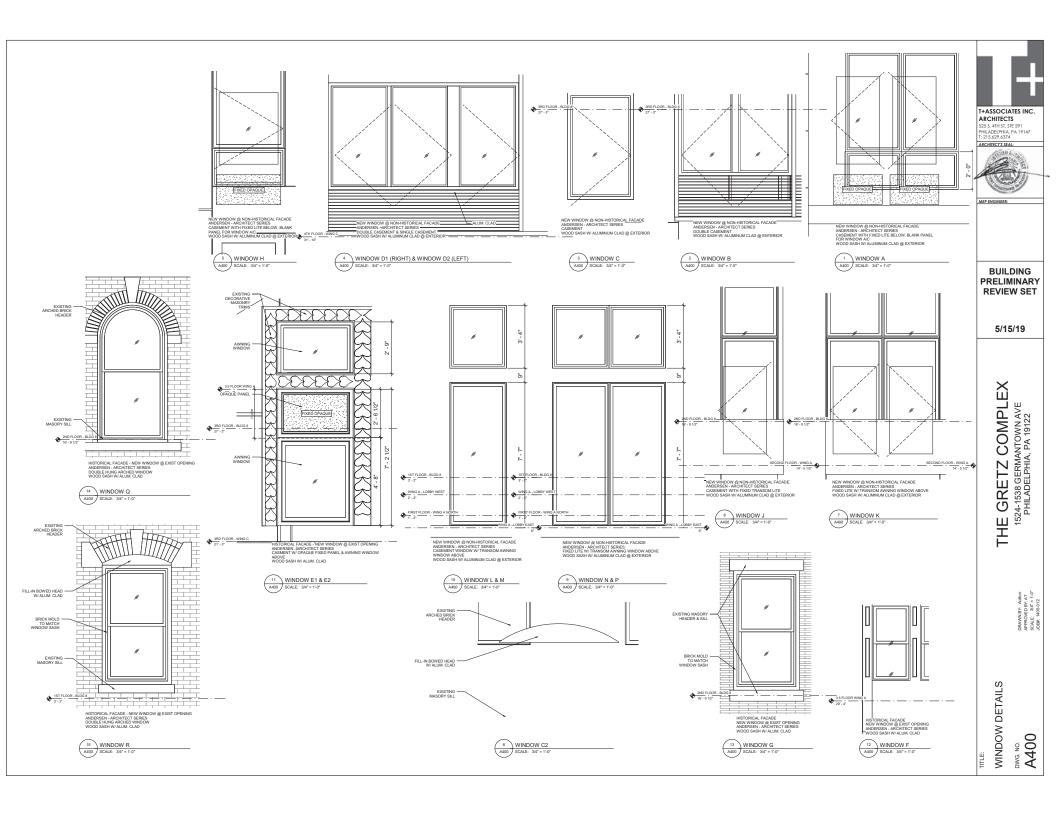

T+ASSOCIATES INC.


ARCHITECTS
525 S. 4TH ST, STE 591
PHILADELPHIA, PA 19147
T: 215.629.6374

BUILDING PRELIMINARY REVIEW SET


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THE GRETZ COMPLEX 1524-1538 GERMANTOWN AVE PHILADELPHIA, PA 19122

DWG. NO. **A401**



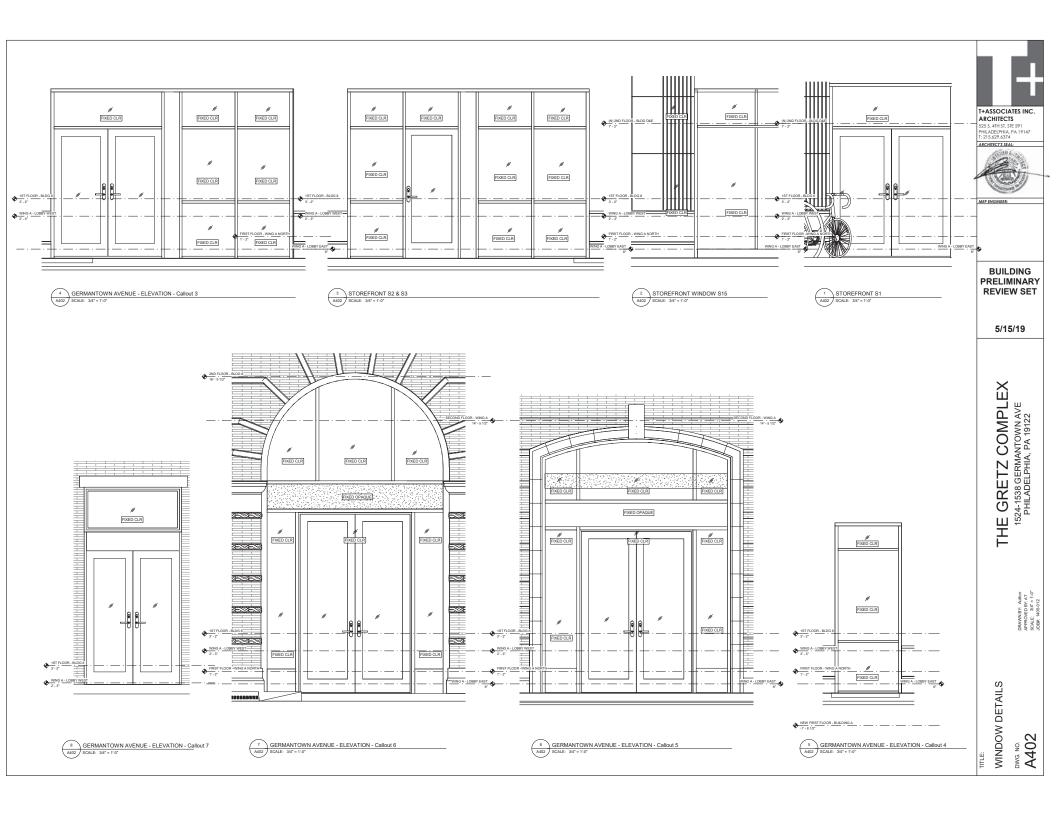

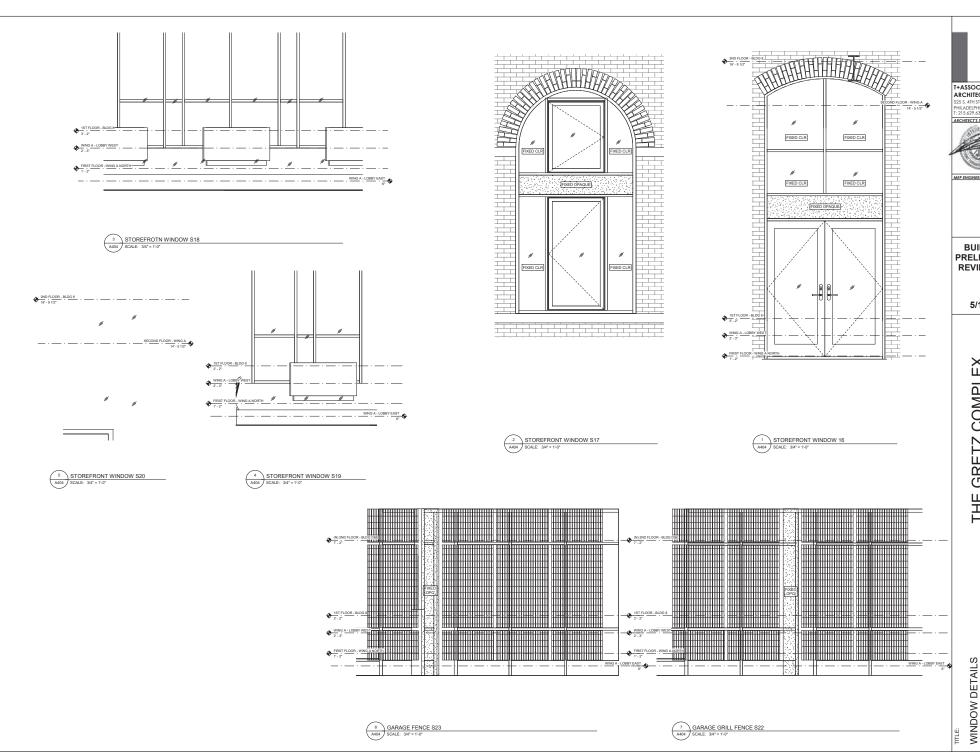


T+ASSOCIATES INC. ARCHITECTS
525 S. 4TH ST, STE 591
PHILADELPHIA, PA 19147
T: 215.629.6374


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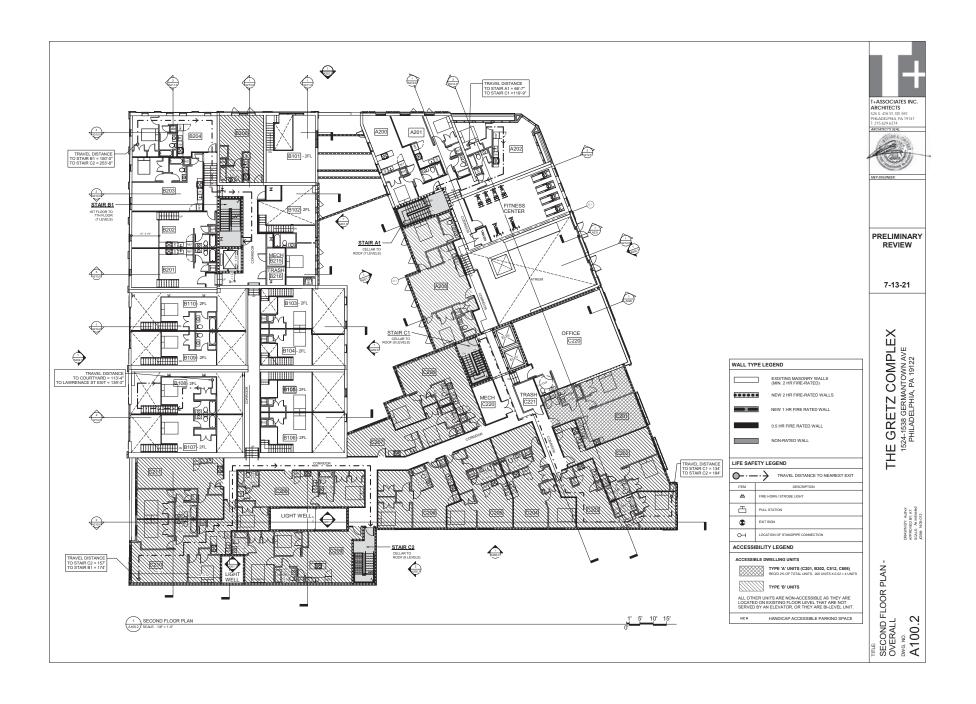
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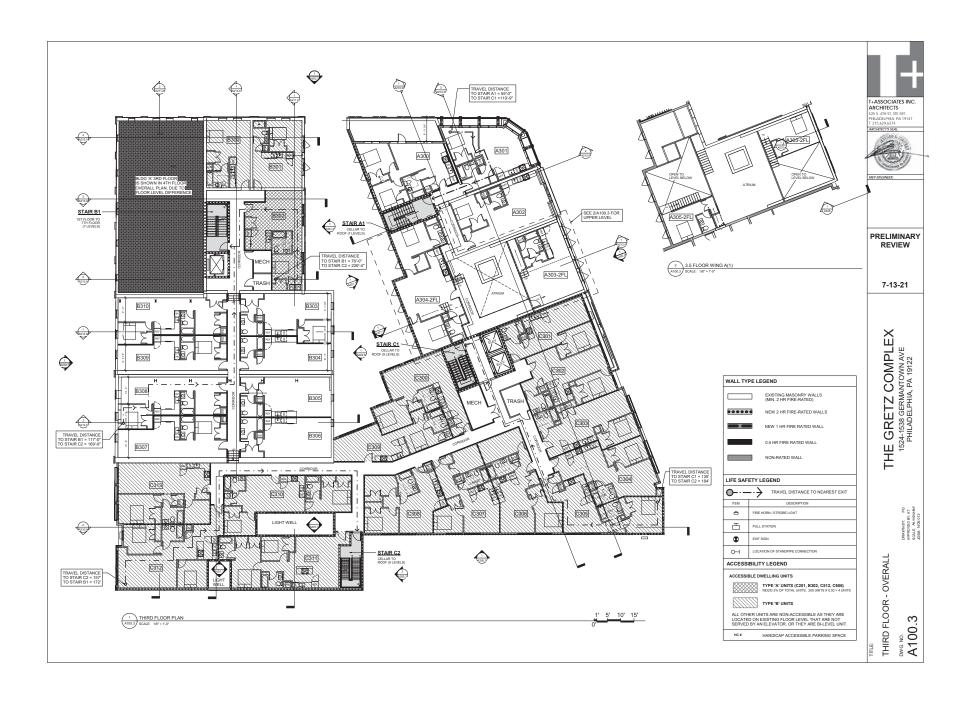
THE GRETZ COMPLEX 1524-1538 GERMANTOWN AVE PHILADELPHIA, PA 19122


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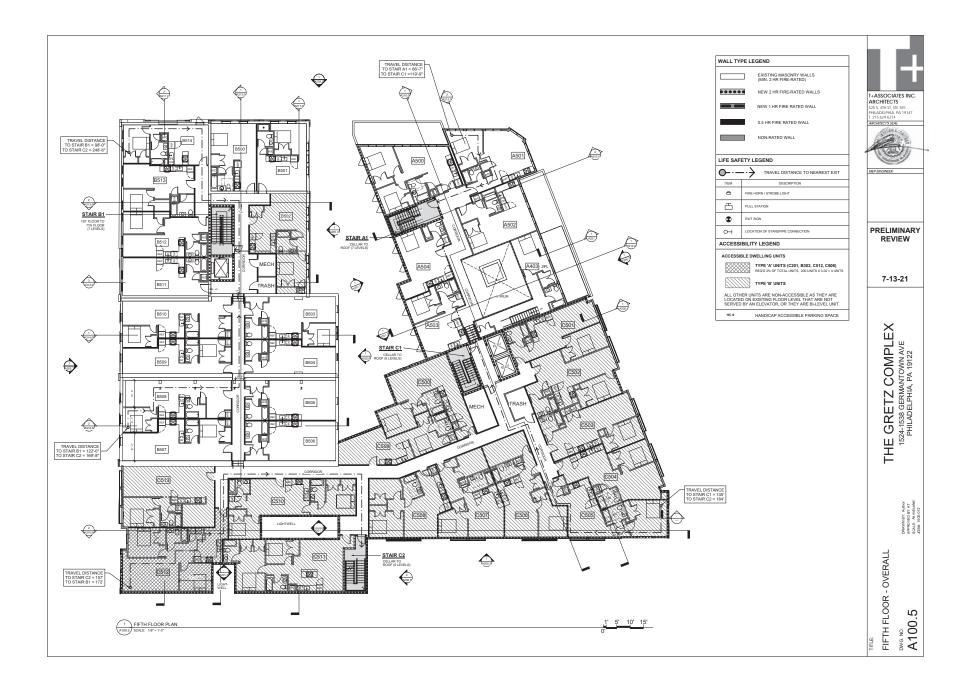








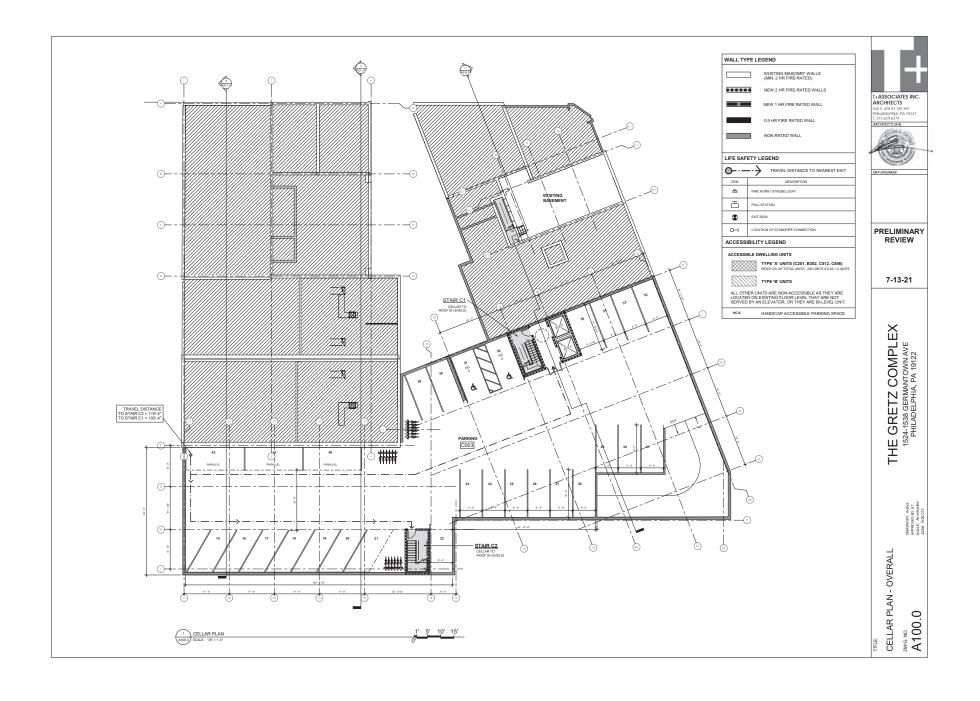


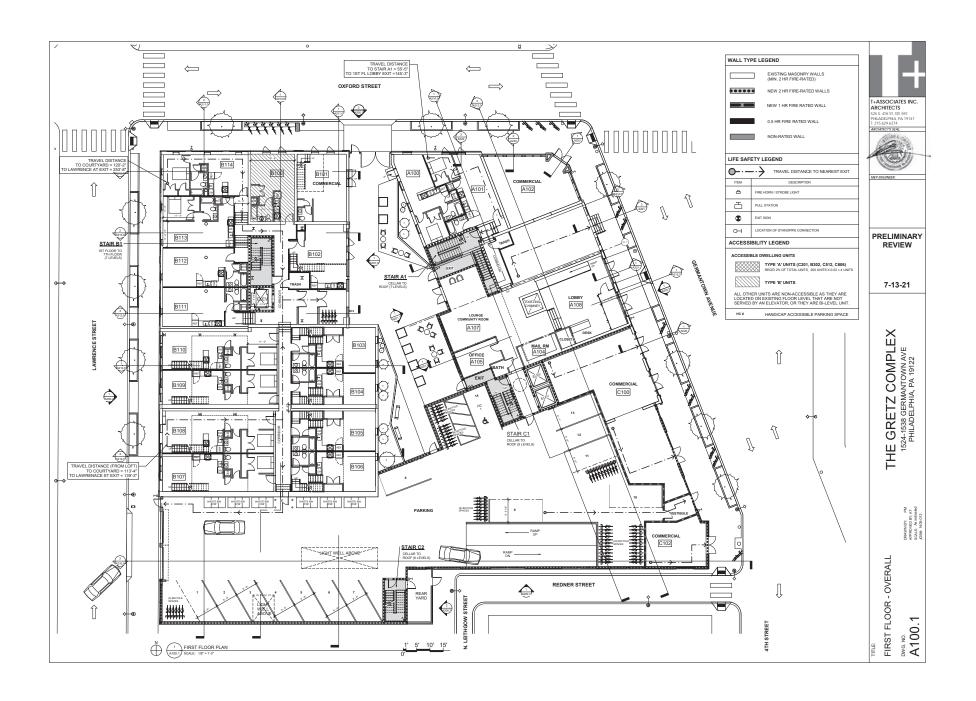

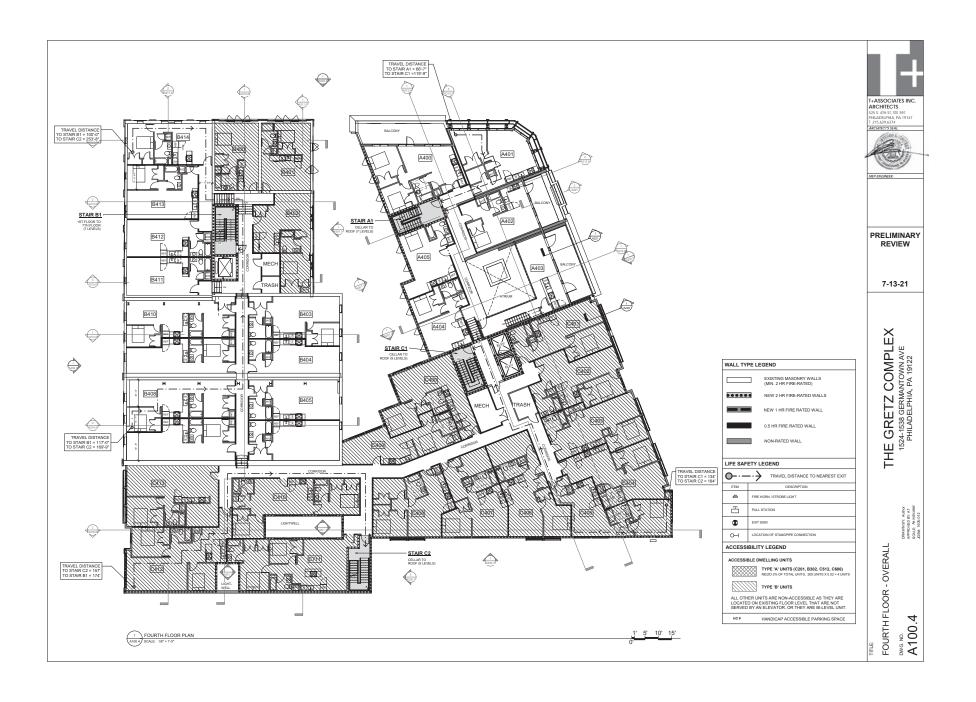


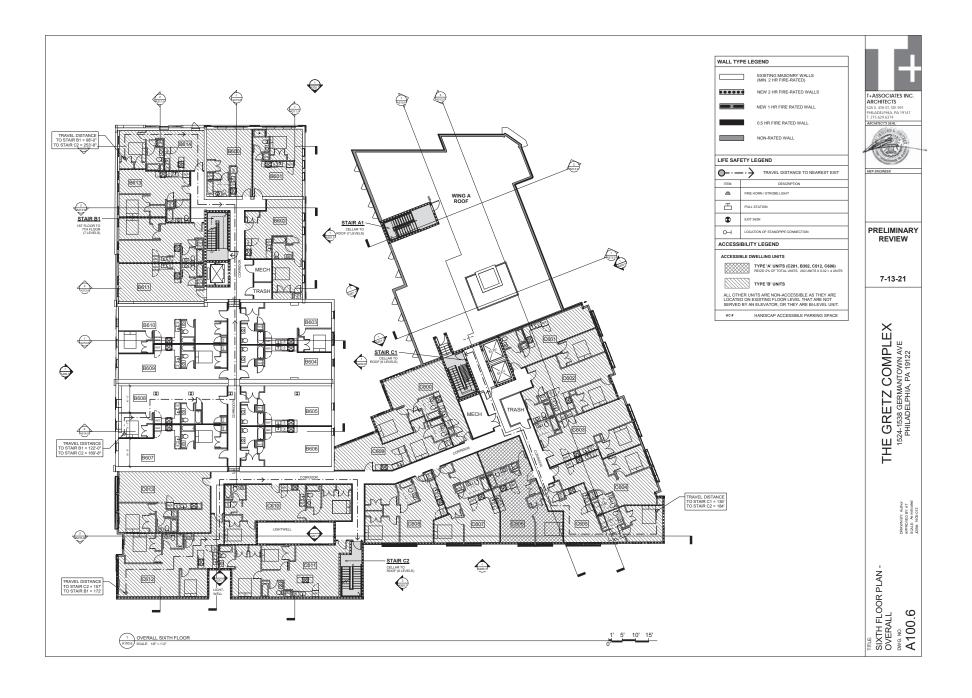

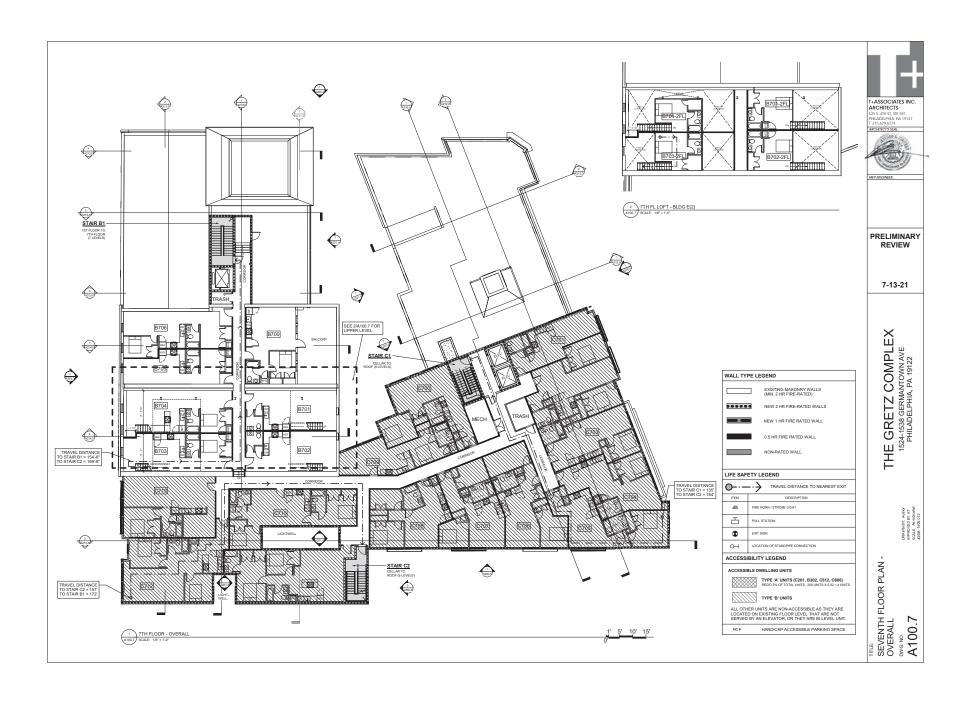

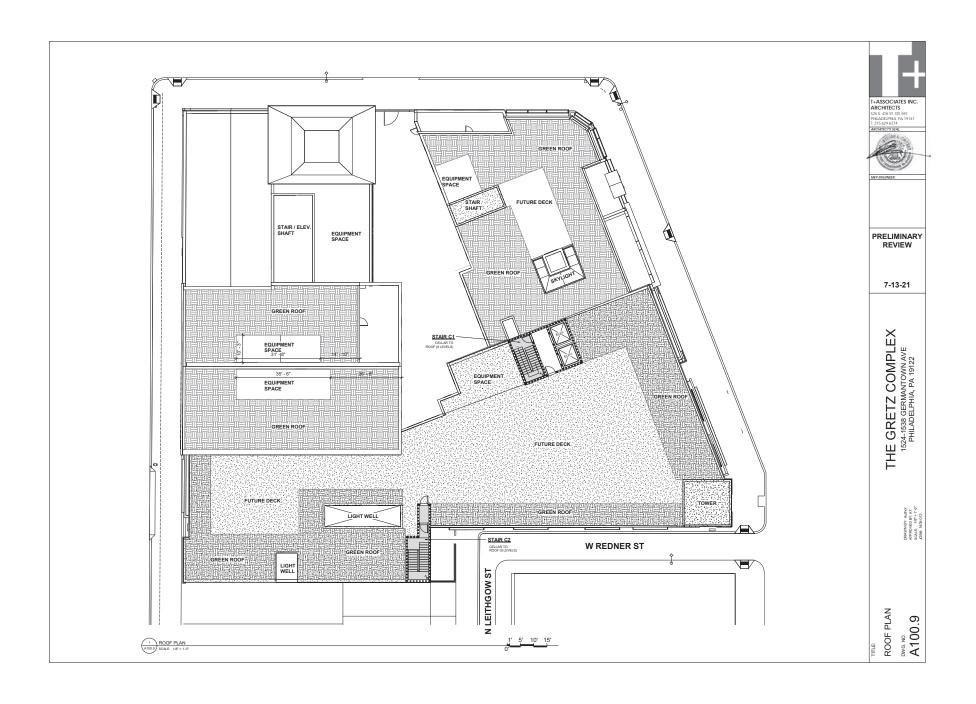




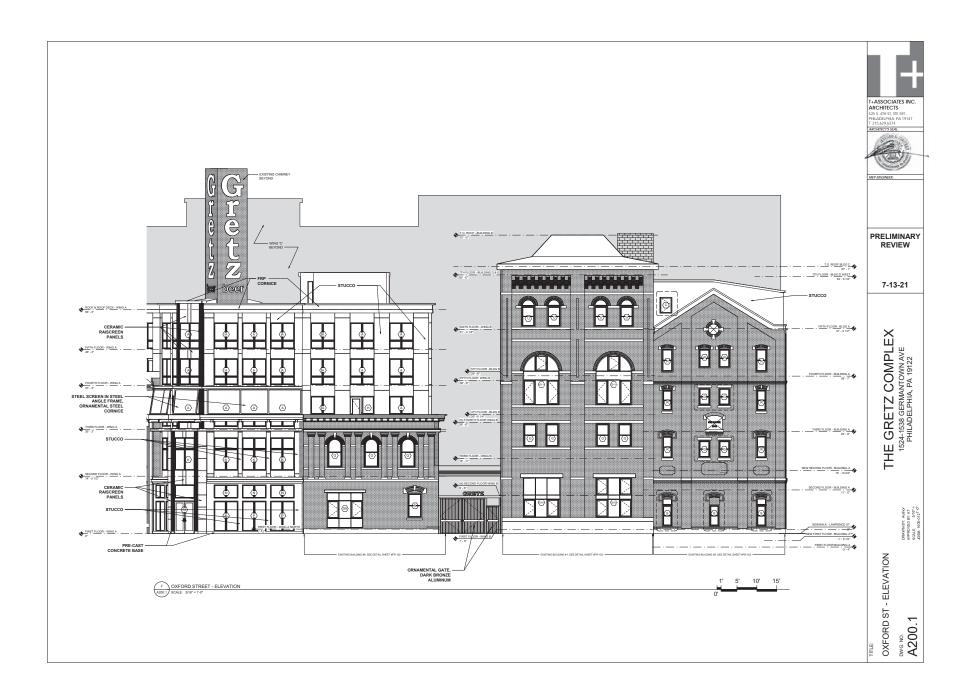





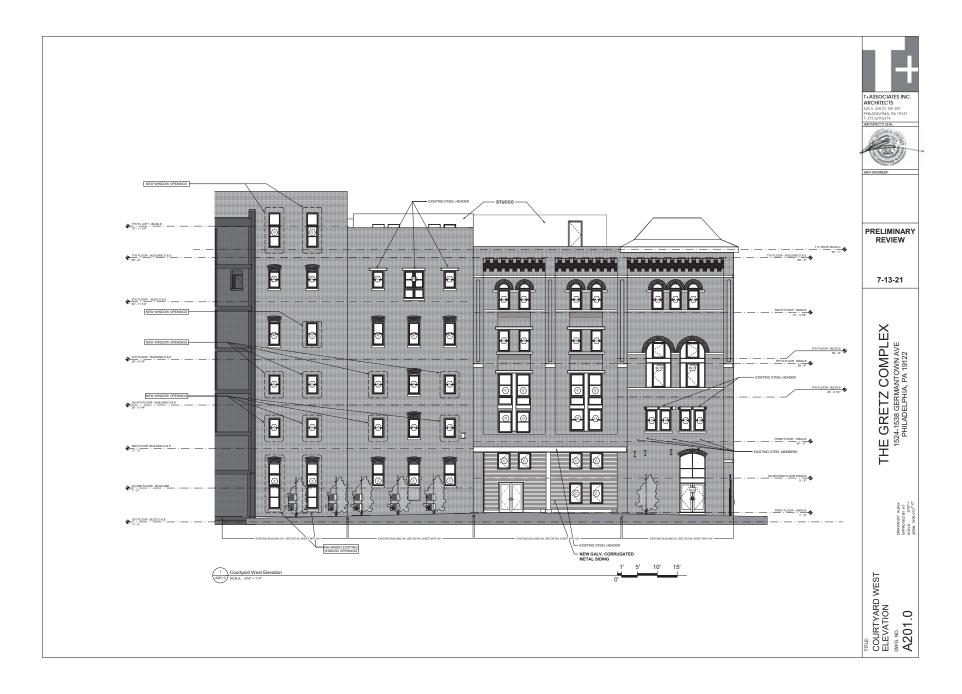



PRELIMINARY REVIEW

7-13-21


T+ASSOCIATES INC. ARCHITECTS 525 S. 4TH ST, STE 591 PHILADELPHIA, PA 19147 T: 215.629.6374 ARCHITECTS SEAL:


THE GRETZ COMPLEX 1524-1538 GERMANTOWN AVE PHILADELPHIA, PA 19122

DRAWN BY: Author
APPROVED BY: AT
SCALE 3/16"=
JOB#: 1405-0121"-0"


COURTYARD EAST ELEVATION DWG.NO.


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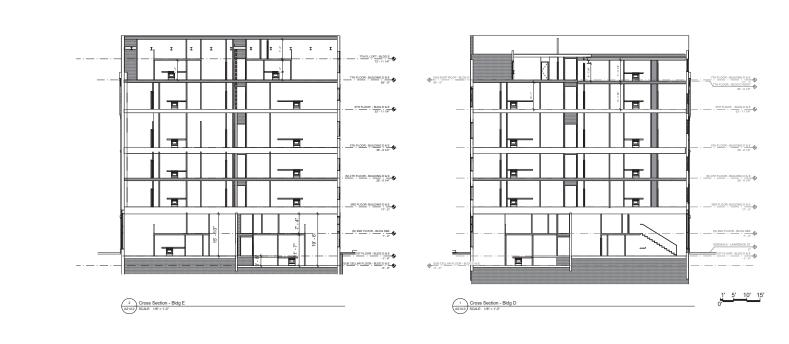


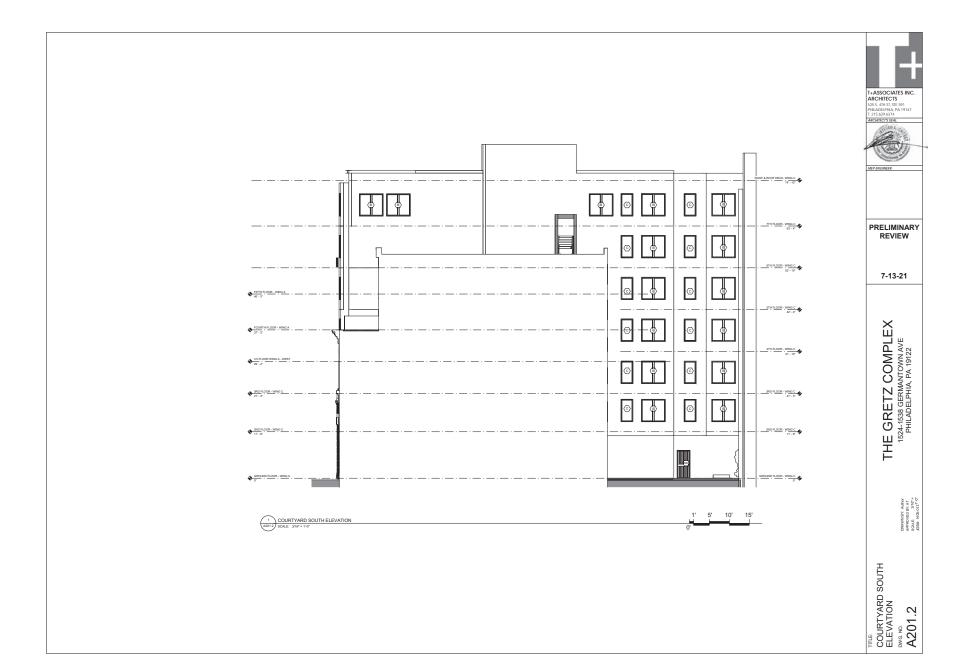

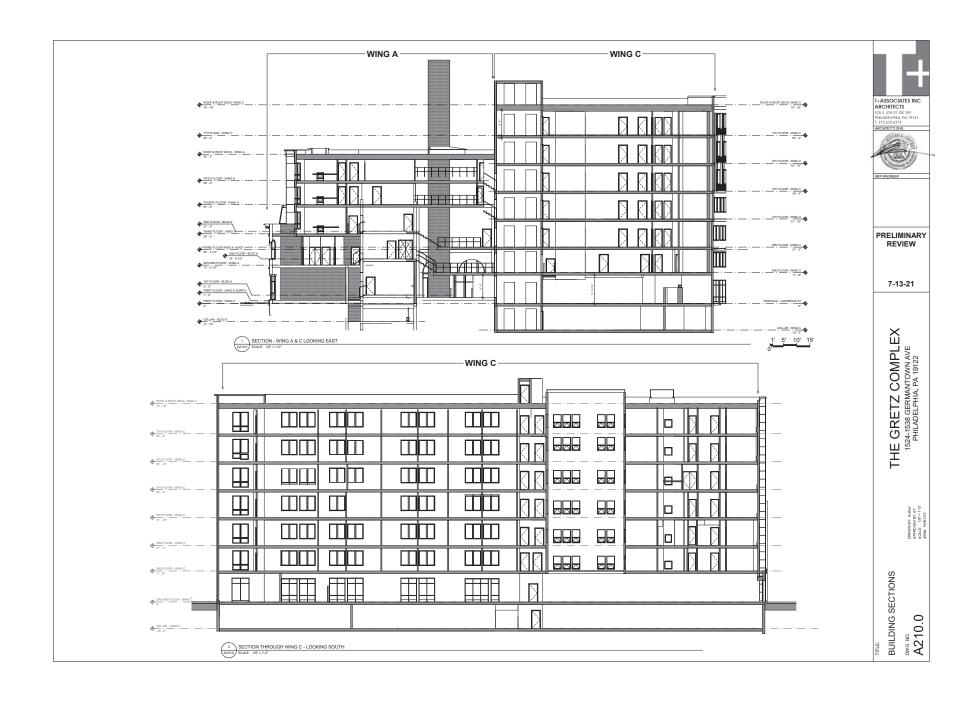



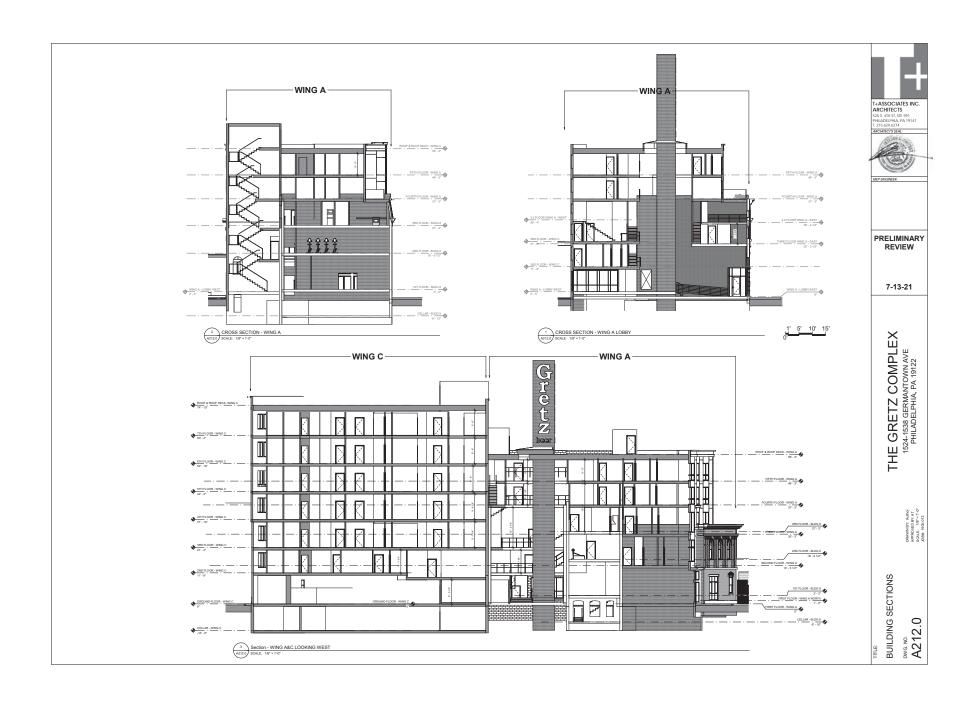

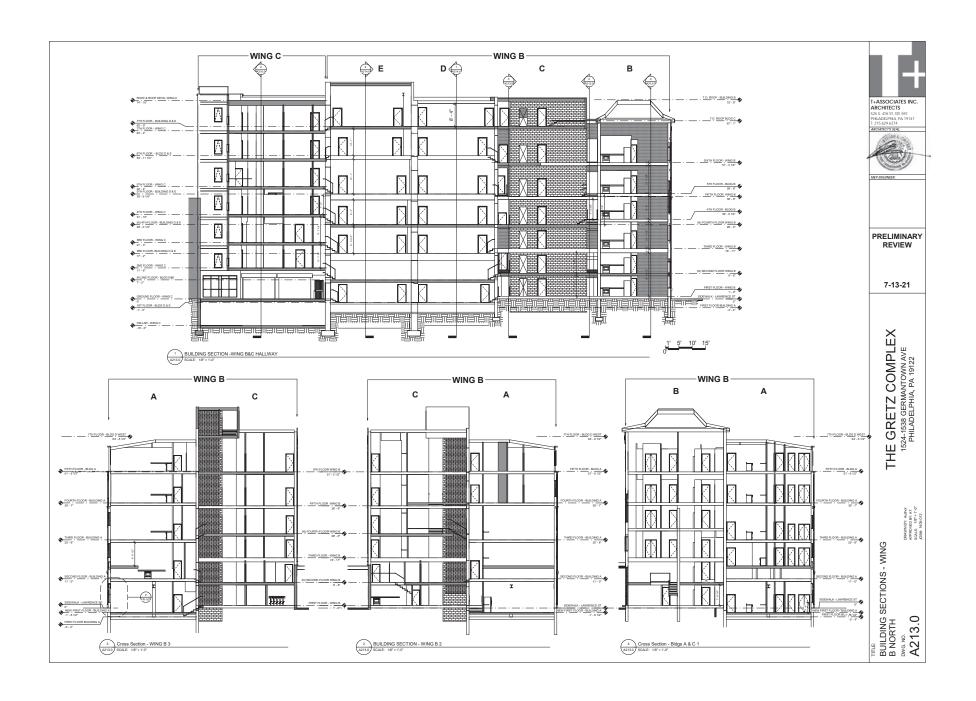

DRAWN BY: Author APPROVED BY: AT SCALE: 1/6" = 1'-0" JOB#: 1405-012 MILEDING SECTIONS - WING B SOUTH BYG NO.

T+ASSOCIATES INC.
ARCHITECTS
525 S. 40151. SIE 591
PHARDEIPHAR PA 19147
1 2 15.20 6 2374
ARCHITECTS SEAL.

PRELIMINARY REVIEW

7-13-21

THE GRETZ COMPLEX 1524-1538 GERMANTOWN AVE PHILADELPHIA, PA 19122

