

Eric Madsen
Permit Philly LLC
License No: 051233
docs@permitphilly.com
267.744.4200

March 15th, 2021

Philadelphia Art Commission
ATTN: Sign Committee
1515 Arch St., 13th Floor
Philadelphia, PA 19102

RE: New signage at Vibrant Coffee Roasters, 222 W. Rittenhouse Square, Rear

To the Sign Committee of the Art Commission:

Please find attached renderings of a proposed sign, previously-approved site and elevation plans, and photos of existing site conditions in application for new signage for Vibrant Coffee Roasters at 222 W. Rittenhouse Square, Rear, Philadelphia, PA 19103.

This is the *second* submission to the Sign Committee.

The proposed signage will be, in total, 10-12 square feet, depending on the size of the bracket used. Two bracket designs are attached for review. The signage will consist of:

- One (1) projecting, circular, non-illuminated sign projecting just under 4' from the facade above the door at a height 10'2" above grade. This sign to say "Cafe, Bakery," be constructed of metal and plexiglass, and contain the logo of the coffee shop itself.




The Commission's Decision and all communication should come to me, Eric Madsen, at the email and phone number above.

Thank you,

A handwritten signature in black ink, appearing to read "E. Madsen", with a stylized flourish extending to the right.

Eric Madsen
Owner, Permit Philly LLC

REVISIONS			
REV.	DESCRIPTION	DATE	CB
A	ORIGINAL DRAWING	5/2018	JB

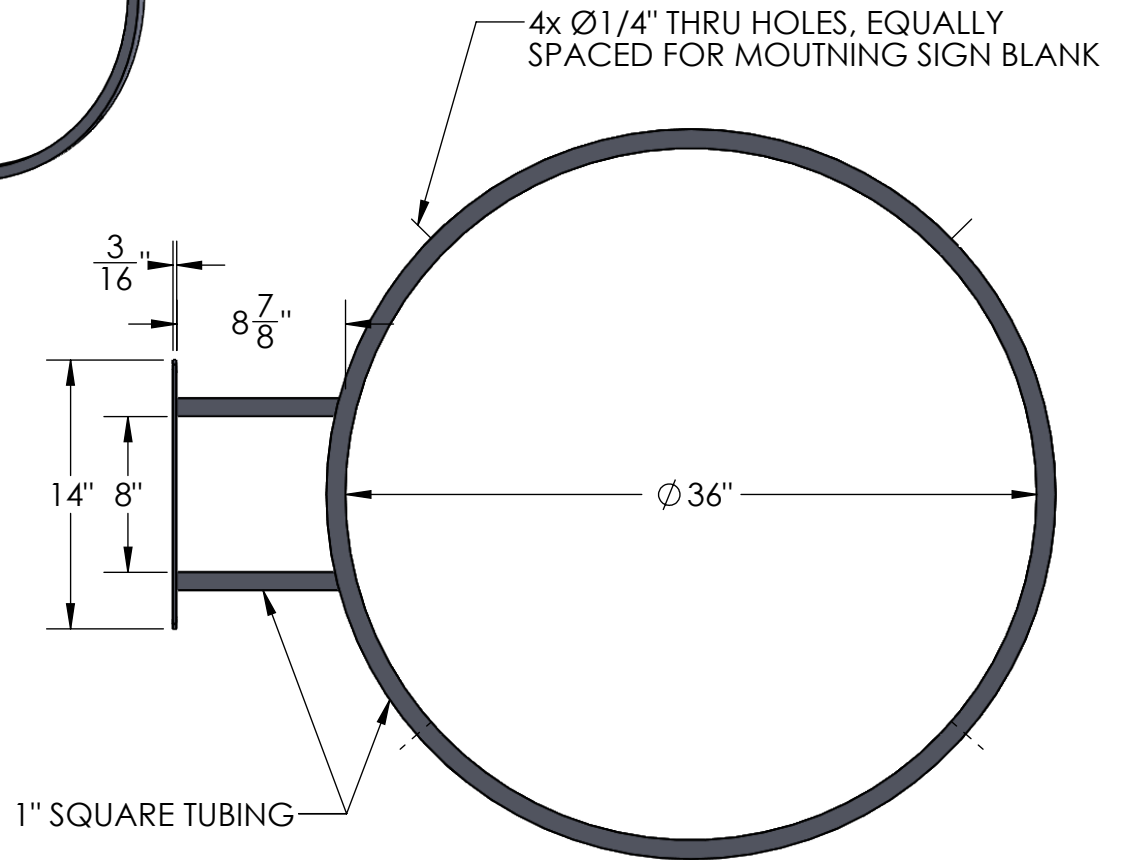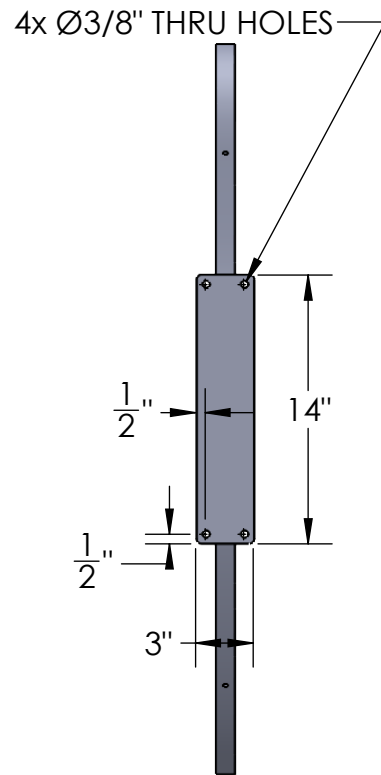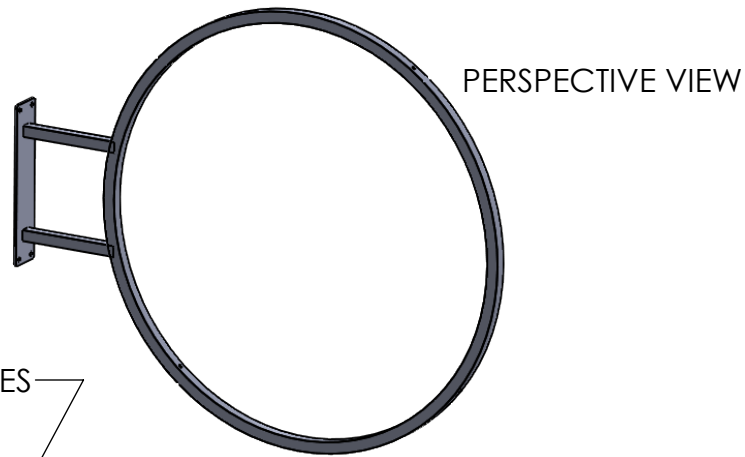

Material:
Steel

Scale: NTS
DB:JB
Rev: A
Sheet: 1 of 1

Content: 36" Cerchio Bracket
PN: 387B-RDO-36
Color/Finish:
Customer Approval: _____

Design by Sign Bracket Store. All visual representations and designs are the intellectual property of Sign Bracket Store and protected under copyright law. Any duplication of this design is in direct violation of the law and will result in legal action.
© Copyright 2008-2016



SIGN BRACKET STORE

T: 888-919-7446

F: 760-603-0812



Dry storage above

10' 3 8"

FIRE WATER



10' 3/8"

FIRE WATER



Stainless

Dry storage above

10' 3/8"

3' 4 1/4"

9' 9"

3' 1 15/16"



36"



24"

36 DOORS

6' 3/8"

FIRE WATER



The Vibrant Coffee entrance at 222 W. Rittenhouse Sq. (Rear) – site of proposed signage

Please note: This entrance is on Locust Street, just off the intersection of Locust and W. Rittenhouse Square



Site to the right of Vibrant Coffee (on Locust Street)



Site to the left of Vibrant Coffee (on Locust Street)



Approach to Vibrant Coffee looking east (towards Rittenhouse Square along Locust Street)



Approach to Vibrant Coffee looking west along Locust Street



Looking west at the 222 W. Rittenhouse Square building from Rittenhouse Square itself at the intersection of Locust and W. Rittenhouse Square.



Looking east down Locust Street from across 20th Street – Vibrant Coffee on the right side of the street



View across the street (Locust) from the entrance of Vibrant Coffee

ARCHITECTURAL ABBREVIATIONS:


ABV	ABOVE	IN	INCHES
A/C	AIR-CONDITIONING	INS	INSULATION
ACC	ACCESSIBLE		
ACP	ACOUSTICAL CEILING PANEL	JC	JANITOR CLOSET
ACT	ACOUSTICAL CEILING TILE	JT	JOINT
ADJ	ADJUSTABLE, ADJACENT		
AFF	ABOVE FINISHED FLOOR	LBS	POUNDS
AHJ	AUTHORITY HAVING JURISDICTION	LIN	LINOLEUM FLOORING
AHU	AIR HANDLER UNIT	LAM	LIQUID APPLIED MEMBRANE
ALT	ALTERNATE		
ALUM	ALUMINUM	MAX	MAXIMUM
AMP	AMPERE(S)	MECH	MECHANICAL
ARCH	ARCHITECT / ARCHITECTURAL	MEP	MECHANICAL, ELECTRICAL & PLUMBING
AW	ARCHITECTURAL WOODWORK	MFR	MANUFACTURER
AWP	ACOUSTICAL WALL PANEL	MIN	MINIMUM
		MO	MASONRY OPENING
		MTD	MOUNTED
		MTL	METAL
BAL	BALANCE	NA	NOT APPLICABLE
BKG	BACKING	NIC	NOT IN CONTRACT
BLKG	BLOCKING	NO	NUMBER
B.O.	BOTTOM OF	NOM	NOMINAL
BOC	BOTTOM OF CEILING	NTS	NOT TO SCALE
BOD	BASIS-OF-DESIGN		
BOF	BOTTOM OF FRAMING	OC	ON CENTER
BOM	BOTTOM OF MASONRY	OD	OUTSIDE DIAMETER
BOS	BOTTOM OF STEEL	OH	OVERHEAD
BOT	BOTTOM	OPG	OPENING
BRKT	BRACKET	OPH	OPPOSITE HAND
BUILD	BUILDING	OTS	OPEN TO STRUCTURE
CAB	CABINET	PH	PHASE
CANT	CANT STRIP	PLUMB	PLUMBING
CERT	CERTIFICATION	PLYWD	PLYWOOD
CJ	CONTROL JOINT	PTD	PAINTED
CF/CI	CONTRACTOR FURNISHED / CONTRACTOR INSTALLED	PTN	PARTITION
CF/TI	CONTRACTOR FURNISHED / TENANT INSTALLED		
CL	CENTER LINE	QTY	QUANTITY
CLG	CEILING		
CLOS	CLOSET		
CLR	CLEAR		
CMU	CONCRETE MASONRY UNIT	RAD	RADIUS
COL	COLUMN	RCP	REFLECTED CEILING PLAN
CONC	CONCRETE	REC	RECESSED
COND	CONDENSER	RECS	RECOMMENDATIONS
CPT	COMMON PATH OF TRAVEL	REC'D	RECEIVED
CTR	COUNTER	REQ'D	REQUIRED
CW	COLD WATER	REF	REFRIGERATOR
		REV	REVISION
D	DEPTH	RM	ROOM
DEG	DEGREE	RO	ROUGH OPENING
DET	DETAIL	RV	ROOF VENT
DIA	DIAMETER	RWC	RAIN WATER CONDUCTOR
DIM	DIMENSION		
DN	DOWN	SAFB	SOUND ATTENUATING FIRE BLANKETS
DS	DOWN SPOUT	SCHED	SCHEDULE(D)
DR	DOOR	SD	STORM DRAIN
DW	DISHWASHER	SH	SPRINKLER HEAD
DWG	DRAWING(S)	SIM	SIMILAR
		SF	SQUARE FEET
EA	EACH	SQ FT	SQUARE FEET
EJ	EXPANSION	SST	STAINLESS STEEL
ELEC	ELECTRIC / ELECTRICAL	STL	STEEL
ELEV	ELEVATION	STOR	STORAGE
ENG	ENGINEER	STRUC	STRUCTURE / STRUCTURAL
EP	ELECTRICAL PANEL (SEE ELECTRICAL DWGS)		
EQUIP	EQUIPMENT	TEMP	TEMPERATURE
ETR	EXISTING TO REMAIN	TF/CI	TENANT FURNISHED / CONTRACTOR INSTALLED
EXIST	EXISTING	TF/TI	TENANT FURNISHED / TENANT INSTALLED
(E)	EXISTING	THK	THICKNESS
EXP	EXPANSION JOINT	THRU	THROUGH
EXT	EXTERIOR	T.O.	TOP OF
		TOF	TOP OF FRAMING
FAP	FIRE ALARM PULL	TOM	TOP OF MASONRY
FC	FINISHED CEILING	TOS	TOP OF STEEL
FD	FLOOR DRAIN (SEE PLUMBING DWGS)	TTS	TIGHT TO STRUCTURE
FE	FIRE EXTINGUISHER	TYP	TYPICAL
FEC	FIRE EXTINGUISHER CABINET		
FIN	FINISHED	UC	UNDER COUNTER
FF	FINISHED FLOOR	UNO	UNLESS NOTED OTHERWISE
FLR	FLOOR		
FO	FINISHED OPENING	V	VOLT(S)
		VEST	VESTIBULE
GA	GAUGE	VIF	VERIFY IN FIELD
GALV	GALVANIZED		
GM	GAS METER	W	WIDTH
GWB	GYPSUM WALL BOARD	W/	WITH
		WD	WOOD
H	HEIGHT	WM	WATER METER
HB	HOSE BIB	W/O	WITHOUT
HD	HAND DRYER	WP	WATER PROOF
HM	HOLLOW METAL	WRB	WATER-RESISTIVE BARRIER
HORIZ	HORIZONTAL	WT	WEIGHT
HT	HEIGHT		
HVAC	HEATING VENTILATION AND COOLING		
HW	HOT WATER (HARD-WIRED, WHERE NOTED)		
HZ	HERTZ		

VIBRANT COFFEE ROASTERS & BAKERY

COMMERCIAL TENANT FIT-OUT | TAKE-OUT RESTAURANT
222 W. RITTENHOUSE SQUARE, GROUND FLOOR REAR

ISSUE FOR PERMIT
AUGUST 12, 2020

LOCATION MAP:

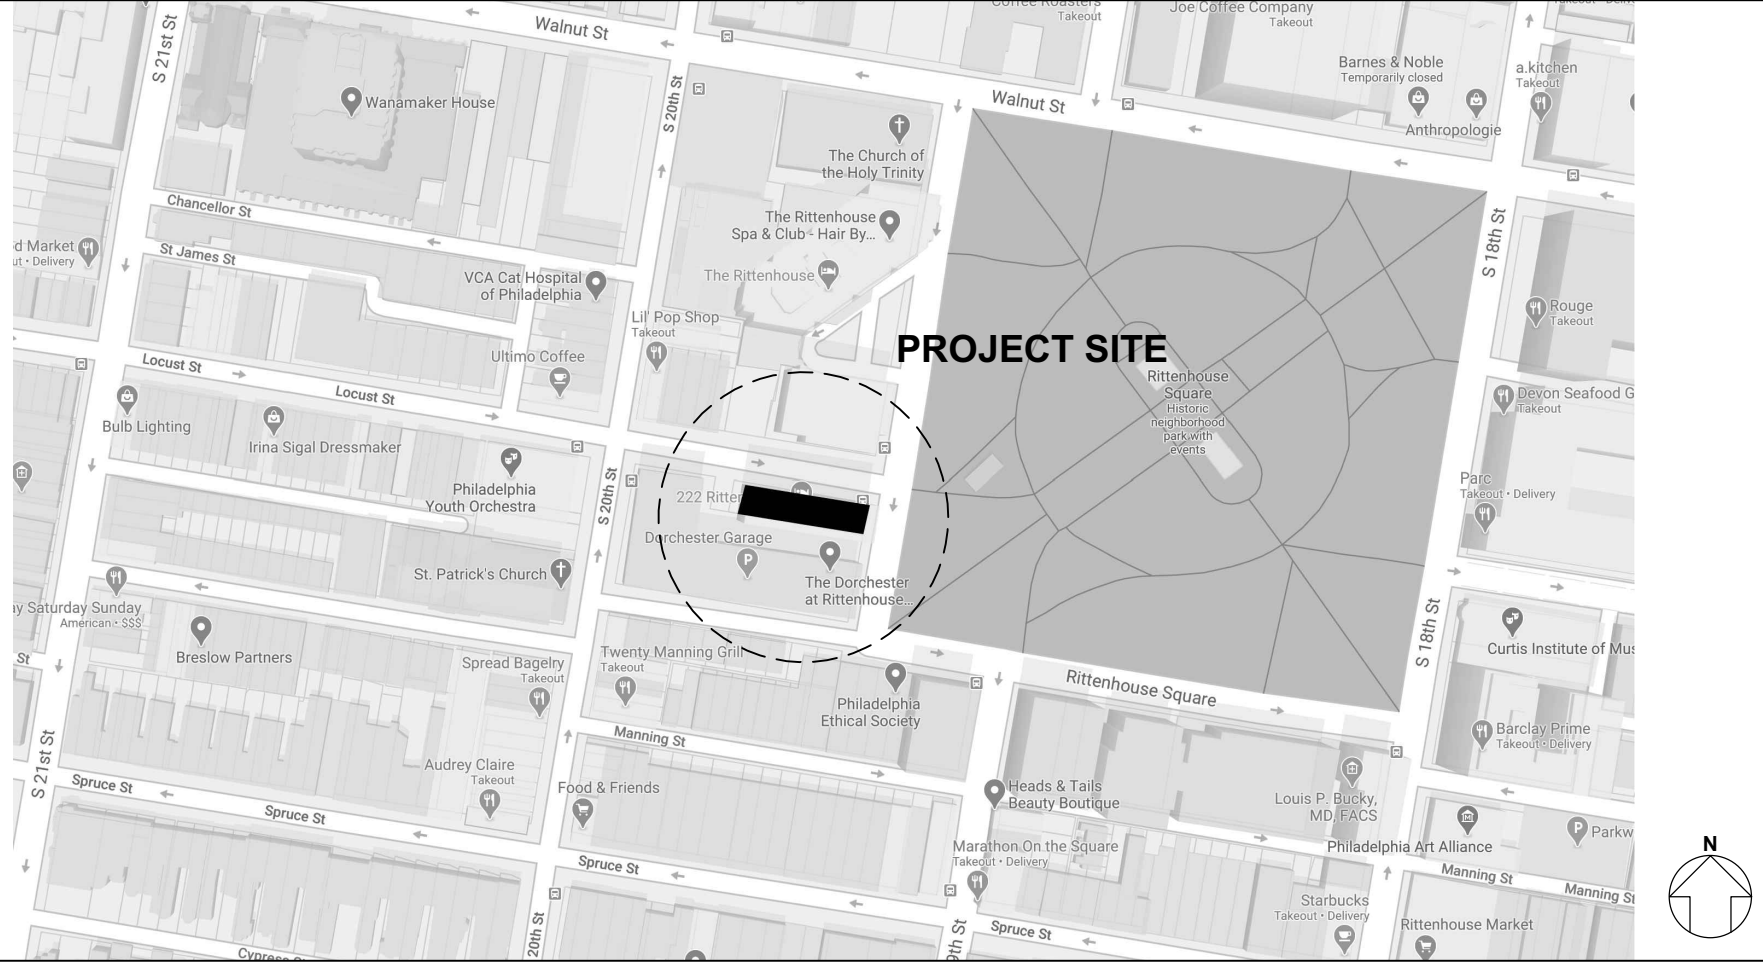

ARCHITECTURAL REFERENCE SYMBOLS LEGEND:

	NORTH ARROW		PARTITION TYPE SEE PLAN AND PARTITION SCHEDULE
	DETAIL INDICATOR		WINDOW TYPE SEE PLAN AND WINDOW SCHEDULE
	SECTION INDICATOR		DOOR NUMBER SEE PLAN AND DOOR SCHEDULE
	ELEVATION INDICATOR		EQUIPMENT TAG SEE EQUIPMENT PLAN AND SCHEDULE
	BENCHMARK DATUM		REVISION TAG SEE DRAWING REVISION NOTES
			ROOM NAME AND NUMBER
			CENTERLINE
			NOTE TAG SEE KEYED NOTES LOCATED ON SHEET

ARCHITECTURAL PLAN SYMBOLS LEGEND:

	EXISTING DOOR TO BE DEMOLISHED		EXISTING PARTITION TO BE DEMOLISHED
	EXISTING DOOR TO REMAIN		EXISTING PARTITION TO REMAIN
	NEW DOOR		NEW PARTITION
			DASH - EXISTING, TO BE DEMOLISHED
			SCREENED - EXISTING
			CONTINUOUS - NEW WORK
			SMALL DASH - HIDDEN (ABOVE OR BELOW), MOVEABLE OR TENANT-FURNISHED EQUIPMENT
			CENTERLINE
			AREA OF WORK OUTLINE
			LIMITED AREA OF WORK: AREA IS NOT IN CONTRACT BUT MAY INCLUDE SOME MEP WORK TO SUPPORT THE AREA OF WORK
			NOT IN CONTRACT (NIC)

PROJECT GENERAL NOTES & COORDINATION NOTES:

- NO ADDITIONS, ALTERATIONS OR CHANGES SHALL BE MADE ON THIS PROJECT UNLESS APPROVED IN WRITING BY THE ARCHITECT.
- THE DESIGN-BUILDER SHALL REVIEW ALL DRAWINGS. THE DESIGN BUILDER SHALL PROMPTLY NOTIFY THE ARCHITECT OF ANY FAULT OR DEFECT IN THE PROJECT, INCLUDING ERRORS, OMISSIONS OR INCONSISTENCIES IN THESE DOCUMENTS.
- THE DESIGN BUILDER SHALL BE RESPONSIBLE FOR INTERPRETING THESE DOCUMENTS AND OBSERVING THE CONSTRUCTION WORK TO DISCOVER, CORRECT, OR MITIGATE ERRORS, INCONSISTENCIES OR OMISSIONS.
- NO SUBSTITUTIONS OF ANY KIND FOR MATERIALS SPECIFIED IN THESE DOCUMENTS IS ALLOWED UNLESS APPROVED IN WRITING BY THE ARCHITECT.
- WORK INDICATED SHALL BE EXECUTED IN ACCORDANCE WITH THE LATEST EDITIONS OF ALL APPLICABLE CODES.
- THE GENERAL CONTRACTOR SHALL CONFORM TO BUILDING OWNER'S CONSTRUCTION REQUIREMENTS AND BUILDING STANDARDS, UNLESS NOTED OTHERWISE. MECHANICAL, ELECTRICAL AND PLUMBING WORK LOCATED WITHIN THE "LIMITED AREA OF WORK" OR BEYOND THE "AREA OF WORK" SHALL BE COORDINATED WITH THE BUILDING OWNER.
- COORDINATE WORK WITH EXISTING FIRE PROTECTION SYSTEMS. PROTECT EXISTING FIRE SPRINKLERS, FIRE ALARMS, EXIT SIGNS, FIRE EXTINGUISHERS AND EMERGENCY EQUIPMENT DURING CONSTRUCTION.
- THE GENERAL CONTRACTOR SHALL BE RESPONSIBLE FOR ADEQUATE BRACING AS REQUIRED TO SECURE WORK TO EXISTING STRUCTURE.
- WHERE MEP WORK INDICATED REQUIRES CUTTING HOLES IN EXISTING FLOORS, THE GENERAL CONTRACTOR SHALL BE RESPONSIBLE FOR CONFIRMING STRUCTURAL REQUIREMENTS, SUBMITTING ENGINEERING CALCULATIONS WHERE REQUIRED AND OBTAINING APPROVAL PRIOR TO CUTTING.
- THE GENERAL CONTRACTOR SHALL BE RESPONSIBLE FOR THE COORDINATION OF WALL/PARTITION AND/OR FLOOR/CEILING THROUGH PENETRATIONS IN FIRE-RATED ASSEMBLIES AND SHALL COORDINATE REQUIRED INSPECTIONS OF THROUGH-PENETRATIONS. SEE ARCHITECTURAL GENERAL NOTES.
- THE FOLLOWING ARE STRICTLY PROHIBITED WORK AND PRACTICES:
 - ANY COMBUSTIBLE MATERIALS ABOVE FINISHED CEILINGS OR IN A NON-SPRINKLERED LOCATION.
 - ANY STRUCTURAL LOAD, TEMPORARY OR PERMANENT, ON ANY PART OF THE BUILDING OWNER'S WORK OR STRUCTURE WITHOUT PRIOR WRITTEN APPROVAL.
 - CUTTING ANY HOLES IN EXISTING FLOOR SLABS, WALLS, OR ROOF WITHOUT PROPER APPROVALS.
- THE CONTRACTOR FOR THE PORTION OF WORK INDICATED ON THE PLANS SHALL BE RESPONSIBLE FOR COORDINATION OF THEIR WORK WITH ALL OTHER TRADES.
- DO NOT SCALE DRAWINGS. USE DIMENSIONS. DIMENSIONS NOTED "AS REQUIRED," "VERIFY IN FIELD," "VERIFY," "MATCH EXISTING," OR OTHER SIMILAR TERMS ARE TO BE VERIFIED BY THE CONTRACTOR. NOTIFY ARCHITECT OF DISCREPANCIES AND OBTAIN CLARIFICATION BEFORE PROCEEDING.
- EXISTING CONDITIONS SHOWN ARE APPROXIMATE BASED ON INFORMATION FURNISHED. FIELD VERIFY BEFORE COMMENCEMENT OF ANY WORK. NOTIFY ARCHITECT OF DISCREPANCIES AND OBTAIN CLARIFICATION BEFORE PROCEEDING.
- INTERIOR DIMENSIONS SHOWN ARE FROM FACE OF FINISHED SURFACE OR FACE OF EXISTING, UNLESS NOTED OTHERWISE.

DRAWING INDEX:

GENERAL / ARCHITECTURAL

G-000	COVER SHEET
G-001	LIFE SAFETY
A-101	FLOOR PLAN AND RCP
A-201	ELEVATIONS AND DETAILS
A-601	EQUIPMENT PLAN AND SCHEDULE

MECHANICAL

M100	SYMBOL LIST, ABBREVIATION AND GENERAL NOTES
M300	FLOOR PLAN HVAC
M700	SCHEDULES HVAC
M800	DETAILS HVAC
M900	SPECIFICATION HVAC
M901	SPECIFICATION HVAC

ELECTRICAL

E100	SYMBOL LIST, ABBREVIATIONS AND GENERAL NOTES
E300	FLOOR PLANS LIGHTING AND POWER
E500	SINGLE LINE DIAGRAM AND SCHEDULES
E900	ELECTRICAL SPECIFICATIONS

PLUMBING

P100	SYMBOL LIST, ABBREVIATION AND GENERAL NOTES
P300	FLOOR PLAN - SANITARY, DOMESTIC WATER
P500	SANITARY, DOMESTIC WATER RISER DIAGRAMS
P700	SCHEDULES AND DETAILS
P900	SPECIFICATION



222 WEST RITTENHOUSE
SQUARE

PMC PROPERTY GROUP
1608 WALNUT ST, SUITE 1400
PHILADELPHIA, PA 19103

OWNER

VIBRANT COFFEE ROASTERS

ROSS NICKERSON & MEGAN MCCUSKER
1001 S 10TH ST
PHILADELPHIA, PA 19147
503-572-3128
nickerson.ross@gmail.com
mf.mccusker@gmail.com

TENANT

KOLE MADE, LLC

NIKO DYSHNIKU
3060 W. JEFFERSON STREET
PHILADELPHIA, PA 19121
215.740.7182
niko@kolemade.com

DESIGN-BUILDER / CM

ALLISON M. EDMONDS, AIA

2001 HAMILTON STREET, APT 1519
PHILADELPHIA, PA 19130
724-816-3753
allison.e.architect@gmail.com

ARCHITECT OF RECORD

GnP DESIGN GROUP

TALI CHICHILNITSKI
2793 BRISTOL PIKE, STE A
BENSALEM, PA 19020
215-447-3160
talichi@gnpdesigngroup.com

MEP ENGINEERS



SEAL

REVISIONS

1	08/12/2020	ISSUE FOR PERMIT

FOR CONSTRUCTION

VIBRANT COFFEE ROASTERS & BAKERY

222 W. RITTENHOUSE SQ., REAR
PHILADELPHIA, PA 19103

PROJECT

COVER SHEET

SHEET TITLE

DATE: 8/11/20

SHEET No.

SCALE: NTS

DRAWN BY: AME

CHECKED BY: AME

PROJECT NO.: 102

PLOT DATE: 8/11/20

G-000



Applied Electronically by L&I User:


PMC PROPERTY GROUP
1608 WALNUT ST, SUITE 1400
PHILADELPHIA, PA 19103

VIBRANT COFFEE ROASTERS

NANT

Surf

G-001

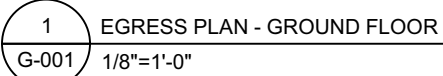

4 EXISTING CONDITIONS - NORTH ELEVATION
G-001 NTS



222 WEST RITTENHOUSE
SQUARE

PMC PROPERTY GROUP
1608 WALNUT ST, SUITE 1400
PHILADELPHIA, PA 19103

OWNER

VIBRANT COFFEE ROASTERS

ROSS NICKERSON & MEGAN MCCUSKER
1001 S 10TH ST
PHILADELPHIA, PA 19147
503-572-3128
nickerson.ross@gmail.com
mf.mccusker@gmail.com

TENANT

KOLE MADE, LLC

NIKO DYSHNIKU
3060 W. JEFFERSON STREET
PHILADELPHIA, PA 19121
215.740.7182
niko@kolemade.com

DESIGN-BUILDER / CM

ALLISON M. EDMONDS, AIA

2001 HAMILTON STREET, APT 1519
PHILADELPHIA, PA 19130
724-816-3753
allison.e.architect@gmail.com

ARCHITECT OF RECORD

GnP DESIGN GROUP

TALI CHICHILNITSKI
2793 BRISTOL PIKE, STE A
BENSALEM, PA 19020
215-447-3160
talichi@gnpdesigngroup.com

MEP ENGINEERS



SEAL

REVISIONS

1	08/12/2020	ISSUE FOR PERMIT
2	09/11/2020	PERMIT SET REVISIONS
3	10/05/2020	PERMIT SET REVISIONS

FOR CONSTRUCTION

VIBRANT COFFEE
ROASTERS &
BAKERY

222 W. RITTENHOUSE SQ., REAR
PHILADELPHIA, PA 19103

PROJECT

FLOOR PLAN
AND RCP

SHEET TITLE

DATE: 8/11/20

SHEET No.

SCALE: AS NOTED


DRAWN BY: AME

CHECKED BY: AME

PROJECT NO.: 102

PLOT DATE: 8/11/2020

A-101

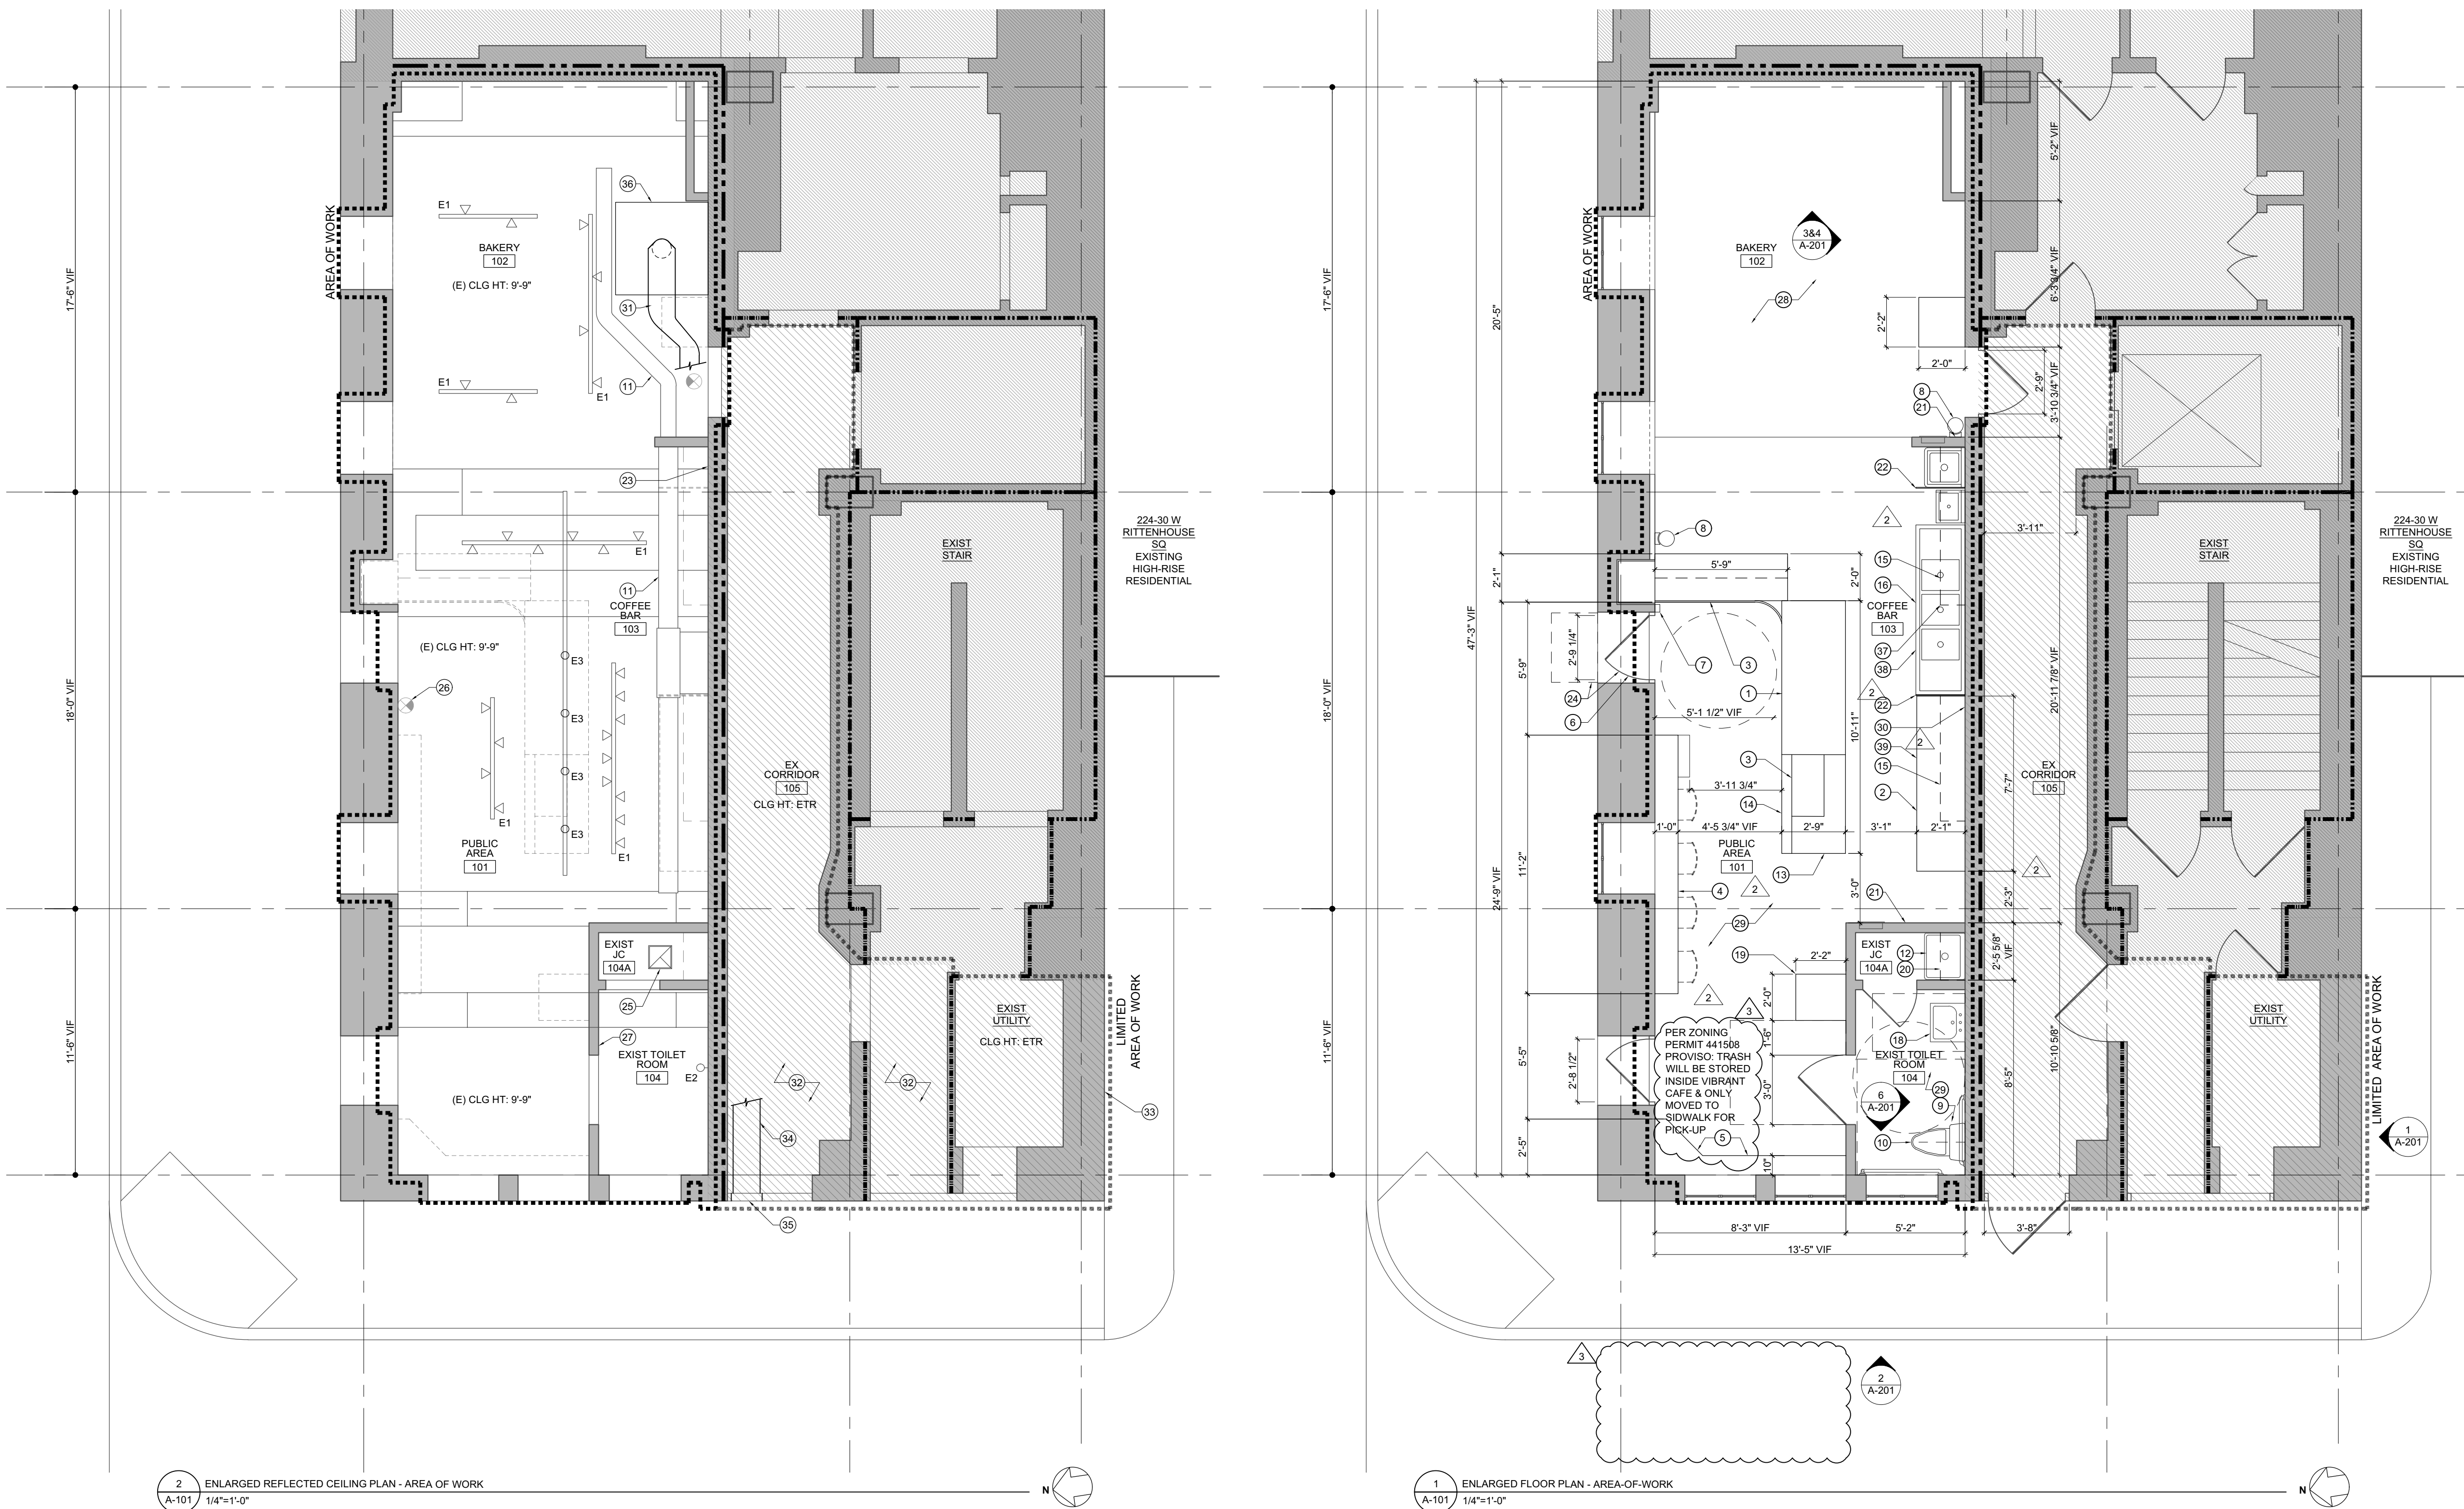

KEYED NOTES

- FRONT COFFEE BAR W/ STORAGE CABINETS BELOW.
- REAR COFFEE BAR W/ STORAGE CABINETS BELOW.
- GLASS-ENCLOSED BAKERY DISPLAY CASE.
- ESPRESSO BAR W/ TENANT-FURNISHED SEATING.
- TRASH & RECYCLING CONTAINER STORAGE.
- REPAIR BROKEN LATCH AT EXISTING DOOR.
- RELOCATE EXISTING FIRE ALARM PULL. MOUNT W/ T.O. PULL BOX AT 48" AFF MAX.
- PROVIDE 2A:10B:C FIRE EXTINGUISHER AND WALL-MOUNTING BRACKET. INSTALL PER MFR RECS.
- EXISTING FIXTURES & ACCESSORIES TO REMAIN, UNO.
- REPLACE EXISTING TOILET IN KIND.
- EXISTING SUPPLY DUCTWORK TO REMAIN. MODIFY AS REQ'D TO COORD. W/ NEW HOOD.
- EXISTING MOP SINK.
- 36" HIGH POINT OF SALE (POS) COUNTER.
- UNDER-COUNTER PACKAGED FOODS DISPLAY CASE.
- OPEN STORAGE WALL SHELVING ABOVE. PROVIDE BLOCKING/STRAPPING IN FURRED PARTITION AS REQUIRED TO SECURE SHELVING.
- UNDER-SINK ENCLOSED W/ WASHABLE SCREEN.
- PREP COUNTER W/ STORAGE CABINETS BELOW.
- PROVIDE ADA-COMPLIANT UNDER-SINK PIPE PROTECTOR.
- TALL CABINET FOR STORAGE OF EMPLOYEE ITEMS. SECURE CABINET TO EXISTING WALL FRAMING.

- STORAGE WALL SHELVING ABOVE FOR STORAGE OF CLEANING SUPPLIES. SECURE SHELVING TO EXISTING WALL FRAMING.
- WALL-MOUNTED FIRST AID KIT.
- PROVIDE SST OR ACRYLIC SHEET SPLASH GUARD. EXTEND FULL DEPTH OF SINK W/ TOP OF GUARD AT 54" AFF.
- REMOVE EXISTING EMERGENCY LIGHT FIXTURE.
- TENANT-FURNISHED PORTABLE ACCESSIBLE THRESHOLD RAMP & WIRELESS DOORBELL.
- EXISTING EXHAUST FAN WITH W/ EXISTING WALL TRANSFER GRILLE TO TOILET ROOM.
- PROVIDE NEW WALL-MOUNTED COMBINATION INTERNALLY-ILLUMINATED EXIT SIGN/EMERGENCY LIGHT FIXTURE AT LOCATION OF EXISTING EXIT SIGN. COORDINATE WITH ELEC.
- PROVIDE NEW WALL-MOUNTED EMERGENCY LIGHT. COORDINATE W/ ELEC.
- EXISTING FLOOR FINISH TO REMAIN.
- PROVIDE NEW TILE FLOORING; INSTALL PER MFR RECS.
- PROVIDE NEW TILE BACKSPLASH; INSTALL PER MFR RECS.
- EXHAUST DUCT; SEE MECH. DUCT TO BE EXPOSED WITHIN AREA-OF-WORK. RUN TIGHT TO UNDERSIDE OF EXISTING STRUCTURE.
- PROVIDE GWB SOFFIT TO ENCLOSE DUCT AT EXISTING CORRIDOR, AS REQ'D. B.O. SOFFIT TO BE 6'-8" AFF MIN. COORD. W/ MECH. SEE 5/A-201 FOR SOFFIT DETAIL.
- EXHAUST OUTLET; SEE MECH. OUTLET FINISH TO MATCH ADJACENT BRICK; COLOR TO BE APPROVED BY ARCHITECT. FLASH & SEAL AROUND OPENING. PROVIDE STEEL LINTEL; REFER TO LINTEL TABLE ON A-201. COORD. LOCATION OF OPENING W/ OTHER EXISTING EXHAUST OPENINGS, PER CODE REQUIREMENTS.

- MAKE-UP AIR DUCT; SEE MECH. DUCT TO BE CONCEALED WITHIN EXISTING CORRIDOR CEILING/SOFFIT. INSTALL DUCT AS HIGH AS POSSIBLE TO COORDINATE WITH OTHER ABOVE-CEILING EQUIPMENT AND EXISTING STRUCTURE.
 - MAKE-UP AIR INTAKE AT EXISTING STUCCO TRANSOM; SEE MECH. FLASH & SEAL AROUND OPENING. GRILLE FINISH TO MATCH ADJACENT STUCCO; COLOR TO BE APPROVED BY ARCHITECT. ALIGN T.O. INTAKE GRILLE W/ T.O. EXIST. TRANSOM. ADJUST LOCATION OF EXISTING LIGHT FIXTURE AS REQ'D.
 - TYPE 2 EXHAUST HOOD; SEE MECH. INSTALL PER MFR RECS. SECURE HOOD TO EXISTING ADJACENT PARTITION AND TO UNDERSIDE OF EXISTING FLOOR SLAB ABOVE. PROVIDE SST HOOD FILLER PANEL BETWEEN HOOD & FIN CLG.
 - TENANT-FURNISHED UTENSIL DRYING RACK ON SHELF ABOVE SINK.
 - TENANT-FURNISHED SOILED LINEN STORAGE CONTAINER UNDER SINK.
 - CLEAN LINEN STORAGE IN CABINET UNDER COUNTER.
- ARCHITECTURAL GENERAL NOTES
- PATCH AND REPAIR EXISTING CONSTRUCTION IN KIND, AS REQUIRED.
 - WHERE REQUIRED AT FIRE-RATED VERTICAL OR HORIZONTAL ASSEMBLIES, WALL/PARTITION AND/OR FLOOR/CEILING THROUGH-PENETRATIONS SHALL BE PROTECTED BY AN APPROVED THROUGH-PENETRATION FIRESTOP SYSTEM INSTALLED AND TESTED IN ACCORDANCE WITH ASTM E814 OR UL 1479, AND SHALL HAVE AN F-RATING OF NOT LESS THAN THE REQUIRED FIRE-RESISTANCE RATING OF THE WALL/PARTITION AND/OR FLOOR/CEILING PENETRATED. SEE FIRE-RESISTANCE RATING OF BUILDING ELEMENTS ON LIFE SAFETY DWG. COORDINATE WITH MEP.
 - PROVIDE ACCESS PANELS FOR PLUMBING, ELECTRICAL AND MECHANICAL LOCATIONS THAT REQUIRE ACCESS. LOCATION, TYPE AND SHOP DRAWINGS SHALL BE SUBMITTED TO ARCHITECT FOR APPROVAL. PROVIDE FIRE-RATED PANELS AS REQUIRED.
 - SEE EQUIPMENT PLAN & SCHEDULE FOR ALL EQUIPMENT DESCRIPTIONS & LOCATIONS. SEE MEP DRAWINGS FOR EQUIPMENT UTILITY CONNECTIONS.

- EQUIPMENT UTILITY CONNECTIONS SHALL BE CONCEALED WITHIN, UNDER OR BEHIND CABINETS AND/OR EQUIPMENT. PROVIDE ESCUTCHEONS AT UTILITY PENETRATIONS THROUGH ARCHITECTURAL MILLWORK. COORDINATE W/ MEP.
 - DOORS & WINDOWS ARE EXISTING TO REMAIN, UNLESS NOTED OTHERWISE. EXISTING DOORS ARE PROVIDED WITH CLOSERS. EXISTING WINDOWS TO BE FITTED WITH INTERIOR TENANT-FURNISHED WINDOW SCREENS.
 - EXISTING FIRE-SPRINKLER SYSTEM TO REMAIN. MODIFY HEAD LOCATIONS AS REQ'D BY NEW LAYOUT.
 - EXISTING FIRE ALARM SYSTEM TO REMAIN. FOR SYSTEM MODIFICATIONS, SEE ELEC DWGS.
 - PROVIDE PAINTED FINISH AT ALL GWB/PLASTER WALLS AND CEILING.
 - WHERE SINKS MEET THE WALL, SEAL WITH SILICON SEALANT.
 - SEAL AROUND BUILT-IN COUNTER TOP EQUIPMENT WITH SILICON SEALANT.
 - WITHIN LIMITED AREA-OF-WORK, EXISTING GWB CEILING TO REMAIN; PATCH & REPAIR AS REQ'D.
 - WITHIN LIMITED AREA-OF-WORK, EXISTING PLASTER CEILING TO REMAIN; PATCH & REPAIR AS REQ'D.
 - WITHIN LIMITED AREA-OF-WORK, EXISTING GWB CEILING TO REMAIN; PATCH & REPAIR AS REQ'D.
- LIGHT FIXTURE LEGEND:
- EXISTING TRACK LIGHTS TO REMAIN. REPLACE EXISTING LAMPS WITH SHATTER-PROOF LEDS.
 - EXISTING WALL SCONCE TO REMAIN.
 - NEW TFCI PENDANT LIGHT FIXTURES AT EXISTING FIXTURE LOCATIONS. PROVIDE WITH SHATTER-PROOF LED LAMPS.

PLANS APPROVED

AS NOTED FOR COMPLIANCE WITH PA UCC
10/22/20

CITY OF PHILADELPHIA
DEPARTMENT OF LICENSES & INSPECTIONS

Callin Mest
PA UCC CERT # 005211

Applied Electronically by L&I User:

APPROVED

October 20, 2020

PHILADELPHIA
HISTORICAL COMMISSION

ALLYSON MEHLEY

ALLYSON MEHLEY

222 WEST RITTENHOUSE
SQUARE

PMC PROPERTY GROUP
1608 WALNUT ST, SUITE 1400
PHILADELPHIA, PA 19103

OWNER

VIBRANT COFFEE ROASTERS

ROSS NICKERSON & MEGAN MCCUSKER
1001 S 10TH ST
PHILADELPHIA, PA 19147
503-572-3128
nickerson.ross@gmail.com
mf.mccusker@gmail.com

TENANT

KOLE MADE, LLC

NIKO DYSHNIKU
3060 W. JEFFERSON STREET
PHILADELPHIA, PA 19121
215.740.7182
niko@kolemade.com

DESIGN-BUILDER / CM

ALLISON M. EDMONDS, AIA

2001 HAMILTON STREET, APT 1519
PHILADELPHIA, PA 19130
724-816-3753
allisone.architect@gmail.com

ARCHITECT OF RECORD

GnP DESIGN GROUP

TALI CHICHILNITSKI
2793 BRISTOL PIKE, STE A
BENSALEM, PA 19020
215-447-3160
talichi@gnpdesigngroup.com

MEP ENGINEERS



SEAL

REVISIONS

1	08/12/2020	ISSUE FOR PERMIT

FOR CONSTRUCTION


VIBRANT COFFEE
ROASTERS &
BAKERY

222 W. RITTENHOUSE SQ., REAR
PHILADELPHIA, PA 19103

PROJECT

ELEVATIONS AND
DETAILS


SHEET TITLE	
DATE: 8/11/20	SHEET No.
SCALE: AS NOTED	A-201
DRAWN BY: AME	
CHECKED BY: AME	
PROJECT NO.: 102	
PLOT DATE: 8/11/20	

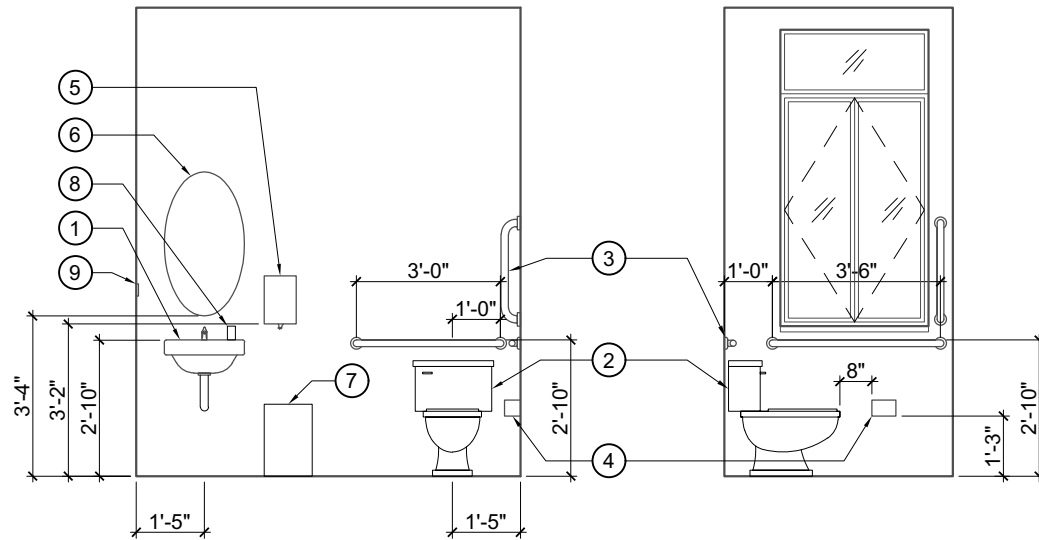


TOILET ROOM ELEVATION KEYED NOTES

- EXISTING SINK. PROVIDE ADA-COMPLIANT UNDER-SINK PIPE PROTECTOR.
- REPLACE EXISTING ACCESSIBLE TOILET IN KIND.
- EXISTING GRAB BARS.
- EXISTING TOILET TISSUE DISPENSER.
- EXISTING TOWEL DISPENSER.
- EXISTING MIRROR.
- TENANT-FURNISHED WASTE RECEPTACLE.
- TENANT FURNISHED SOAP DISPENSER.
- EXISTING SIGN: "EMPLOYEES MUST WASH HANDS BEFORE RETURNING TO WORK."

6
A-201 1/4"=1'-0"

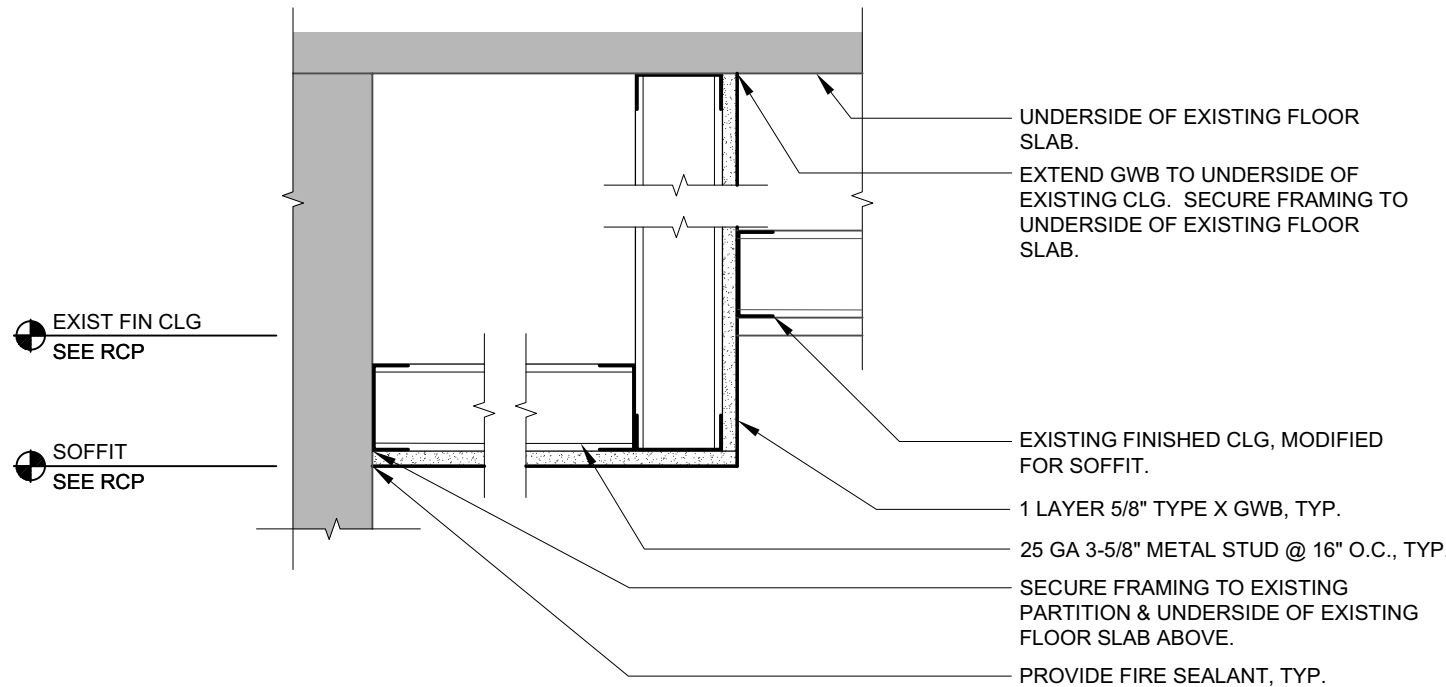


5
A-201 SCALE: 1 1/2"=1'-0"

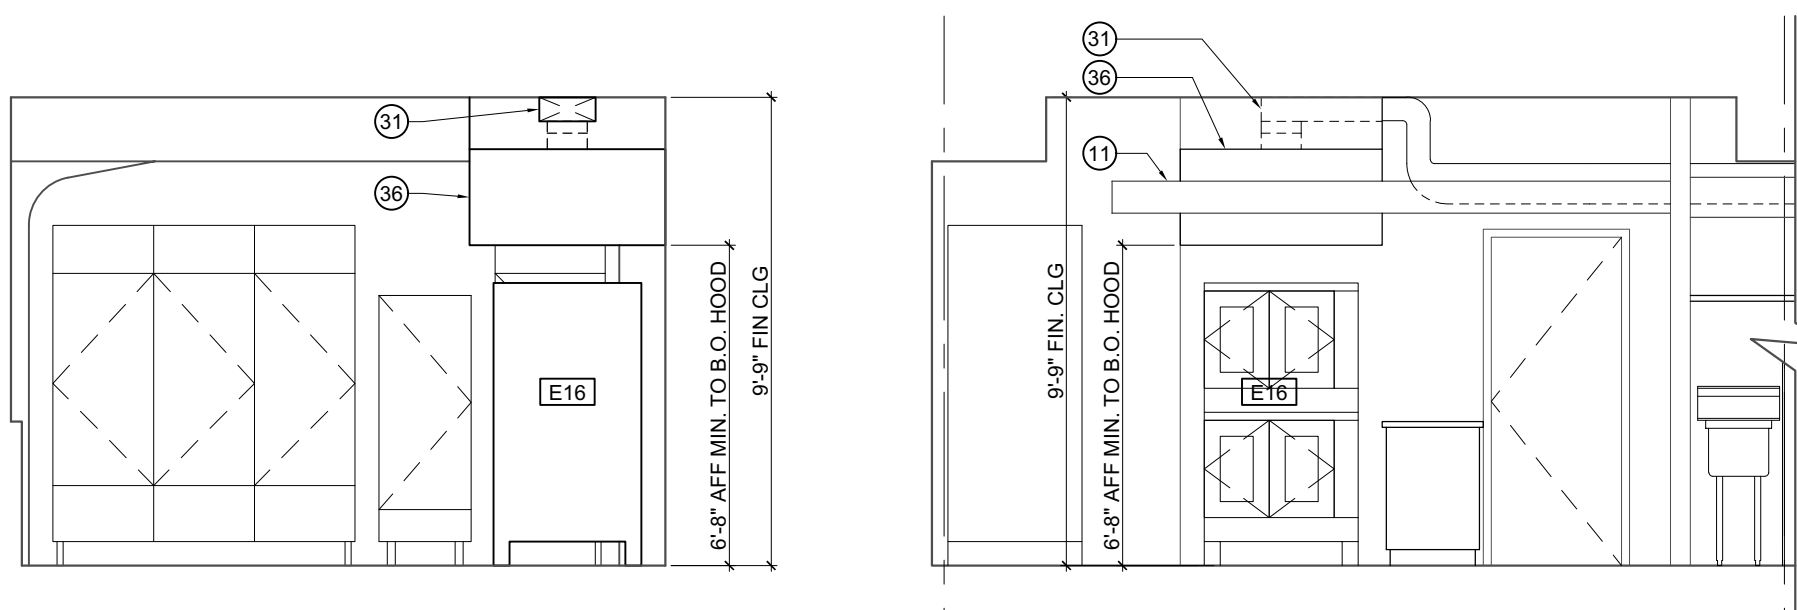

4
A-201 1/4"=1'-0"

3
A-201 1/4"=1'-0"

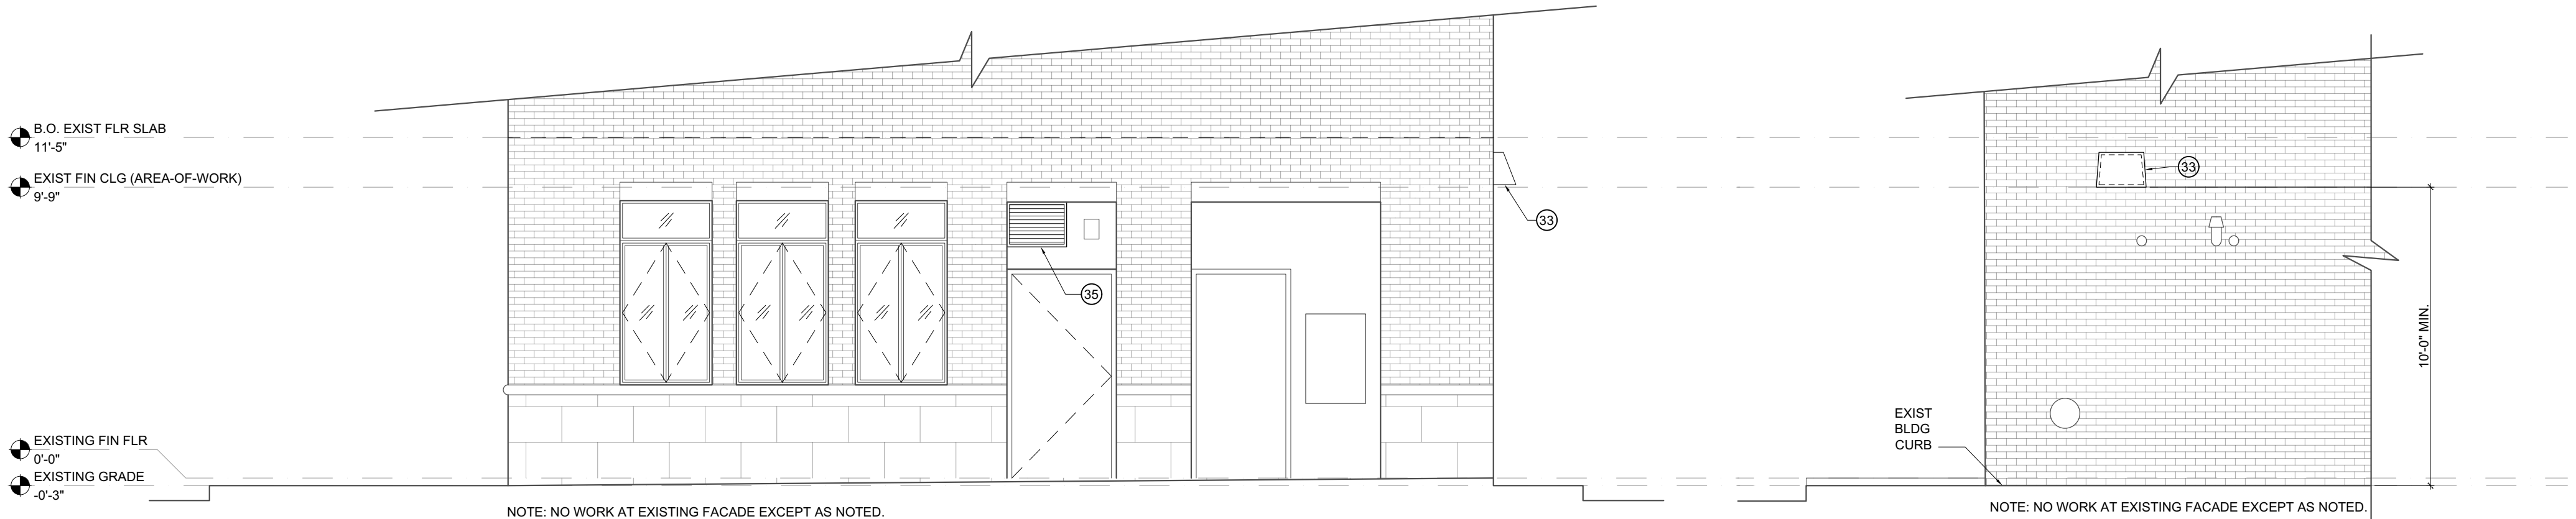

2
A-201 1/4"=1'-0"

1
A-201 1/4"=1'-0"

WALL THICKNESS	STEEL LINTEL CLEAR SPAN			
	UP TO 4'-0"	4'-1" TO 6'-0"	6'-1" TO 8'-0"	8'-1" TO 10'-0"
4" VENEER	L3 1/2x3 1/2x1/4	L4x3 1/2x5/16	L5x3 1/2x5/16	L5x3 1/2x3/8
6"	2-L3 1/2x2 1/2x1/4	2-L3 1/2x2 1/2x1/4	2-L3 1/2x2 1/2x5/16	2-L3 1/2x2 1/2x3/8
8"	2-L3 1/2x3 1/2x1/4	2-L3 1/2x3 1/2x5/16	2-L4x3 1/2x5/16	2-L5x3 1/2x5/16
10"	L4x3x1/4 + L5x3x1/4	L4x4x1/4 + L5x3 1/2x1/4	L4x4x5/16 + L5x3 1/2x5/16	L4x4x5/16 + L5x4x5/16
12"	3-L3 1/2x3 1/2x1/4	3-L3 1/2x3 1/2x5/16	3-L4x3 1/2x5/16	3-L5x3 1/2x5/16

STEEL LINTEL TABLE NOTES:

- DOUBLE ANGLES SHALL BE BOLTED BACK TO BACK WITH 3/4" DIA. BOLTS AT 16" ON CENTER.
- ALL ANGLES ARE L.V. FOR 10" WALL THICKNESS, THE L4 + L5 LEGS ARE HORIZONTAL.
- END BEARING SHALL BE A MINIMUM OF 4" FOR 6'-0" OR LESS CLEAR SPANS AND 6" FOR 10'-0" OR LESS CLEAR SPANS.
- CUT WEBS OF LINTEL BLOCK TO RECEIVE ANGLES. GROUT FIRST BLOCK ABOVE ANGLES SOLID.

KEYED NOTES

- FRONT COFFEE BAR W/ STORAGE CABINETS BELOW.
- REAR COFFEE BAR W/ STORAGE CABINETS BELOW.
- GLASS-ENCLOSED BAKERY DISPLAY CASE.
- ESPRESSO BAR.
- TRASH & RECYCLING CONTAINER STORAGE.
- REPAIR BROKEN LATCH AT EXISTING DOOR.
- RELOCATE EXISTING FIRE ALARM PULL. MOUNT W/ T.O. PULL BOX AT 48" AFF MAX.
- PROVIDE 2A-10B/C FIRE EXTINGUISHER AND WALL-MOUNTING BRACKET. INSTALL PER MFR RECS.
- EXISTING FIXTURES & ACCESSORIES TO REMAIN. UNO.
- REPLACE EXISTING TOILET IN KIND.
- EXISTING SUPPLY DUCTWORK TO REMAIN. MODIFY AS REQ'D TO COORD. W/ NEW HOOD.
- EXISTING MOP SINK.
- 36" HIGH POINT OF SALE (POS) COUNTER.
- UNDER-COUNTER PACKAGED FOODS DISPLAY CASE.
- OPEN STORAGE WALL SHELVING ABOVE. PROVIDE BLOCKING/STRAPPING IN FURRED PARTITION AS REQUIRED TO SECURE SHELVING.
- UNDER-SINK ENCLOSED W/ WASHABLE SCREEN.
- PREP COUNTER W/ STORAGE CABINETS BELOW.
- PROVIDE ADA-COMPLIANT UNDER-SINK PIPE PROTECTOR.
- TALL CABINET FOR STORAGE OF EMPLOYEE ITEMS. SECURE CABINET TO EXISTING WALL FRAMING.

- STORAGE WALL SHELVING ABOVE FOR STORAGE OF CLEANING SUPPLIES. SECURE SHELVING TO EXISTING WALL FRAMING.
- WALL-MOUNTED FIRST AID KIT.
- PROVIDE SST OR ACRYLIC SHEET SPLASH GUARD. EXTEND FULL DEPTH OF SINK W/ TOP OF GUARD AT 54" AFF.
- REMOVE EXISTING EMERGENCY LIGHT FIXTURE.
- TENANT-FURNISHED PORTABLE ACCESSIBLE THRESHOLD RAMP & WIRELESS DOORBELL.
- EXISTING EXHAUST FAN WITH W/ EXISTING WALL TRANSFER GRILLE TO TOILET ROOM.
- PROVIDE NEW WALL-MOUNTED COMBINATION INTERNALLY-ILLUMINATED EXIT SIGN/EMERGENCY LIGHT FIXTURE AT LOCATION OF EXISTING EXIT SIGN. COORDINATE WITH ELEC.
- PROVIDE NEW WALL-MOUNTED EMERGENCY LIGHT. COORDINATE W/ ELEC.
- EXISTING FLOOR FINISH TO REMAIN.
- PROVIDE NEW TILE FLOORING; INSTALL PER MFR RECS.
- PROVIDE NEW TILE BACKSPLASH; INSTALL PER MFR RECS.
- EXHAUST DUCT; SEE MECH. DUCT TO BE EXPOSED WITHIN AREA-OF-WORK. RUN TIGHT TO UNDERSIDE OF EXISTING STRUCTURE.
- PROVIDE GWB SOFFIT TO ENCLOSE DUCT AT EXISTING CORRIDOR, AS REQ'D. B.O. SOFFIT TO BE 6'-8" AFF MIN. COORD. W/ MECH. SEE 5/A-201 FOR SOFFIT DETAIL.
- EXHAUST OUTLET; SEE MECH. OUTLET FINISH TO MATCH ADJACENT BRICK; COLOR TO BE APPROVED BY ARCHITECT. FLASH & SEAL AROUND OPENINGS. PROVIDE STEEL LINTEL; REFER TO LINTEL TABLE ON A-201. COORD. LOCATION OF OPENING W/ OTHER EXISTING EXHAUST OPENINGS, PER CODE REQUIREMENTS.

- MAKE-UP AIR DUCT; SEE MECH. DUCT TO BE CONCEALED WITHIN EXISTING CORRIDOR CEILING/SOFFIT. INSTALL DUCT AS HIGH AS POSSIBLE TO COORDINATE WITH OTHER ABOVE-CEILING EQUIPMENT AND EXISTING STRUCTURE.
- MAKE-UP AIR INTAKE AT EXISTING STUCCO TRANSOM; SEE MECH. FLASH & SEAL AROUND OPENING. GRILLE FINISH TO MATCH ADJACENT STUCCO; COLOR TO BE APPROVED BY ARCHITECT. ALIGN T.O. INTAKE GRILLE W/ T.O. EXIST. TRANSOM. ADJUST LOCATION OF EXISTING LIGHT FIXTURE AS REQ'D.
- TYPE 2 EXHAUST HOOD; SEE MECH. INSTALL PER MFR RECS. SECURE HOOD TO EXISTING ADJACENT PARTITION AND TO UNDERSIDE OF EXISTING FLOOR SLAB ABOVE. PROVIDE SST HOOD FILLER PANEL BETWEEN HOOD & FIN CLG.

ARCHITECTURAL GENERAL NOTES

- PATCH AND REPAIR EXISTING CONSTRUCTION IN KIND, AS REQUIRED.
- WHERE REQUIRED AT FIRE-RATED VERTICAL OR HORIZONTAL ASSEMBLIES, WALL/PARTITION AND/OR FLOOR/CEILING THROUGH-PENETRATION FIRESTOP SYSTEM INSTALLED AND TESTED IN ACCORDANCE WITH ASTM E814 OR UL 1479, AND SHALL HAVE AN F-RATING OF NOT LESS THAN THE REQUIRED FIRE-RESISTANCE RATING OF THE WALL/PARTITION AND/OR FLOOR/CEILING PENETRATED. SEE FIRE-RESISTANCE RATING OF BUILDING ELEMENTS ON LIFE SAFETY DWG. COORDINATE WITH MEP.
- PROVIDE ACCESS PANELS FOR PLUMBING, ELECTRICAL AND MECHANICAL LOCATIONS THAT REQUIRE ACCESS. LOCATION, TYPE AND SHOP DRAWINGS SHALL BE SUBMITTED TO ARCHITECT FOR APPROVAL. PROVIDE FIRE-RATED PANELS AS REQUIRED.
- SEE EQUIPMENT PLAN & SCHEDULE FOR ALL EQUIPMENT DESCRIPTIONS & LOCATIONS. SEE MEP DRAWINGS FOR EQUIPMENT UTILITY CONNECTIONS.

- EQUIPMENT UTILITY CONNECTIONS SHALL BE CONCEALED WITHIN UNDER OR BEHIND CABINETS AND/OR EQUIPMENT. PROVIDE ESCUTCHEONS AT UTILITY PENETRATIONS THROUGH ARCHITECTURAL MILLWORK. COORDINATE W/ MEP.
- DOORS & WINDOWS ARE EXISTING TO REMAIN, UNLESS NOTED OTHERWISE. EXISTING DOORS ARE PROVIDED WITH CLOSERS. EXISTING WINDOWS TO BE FITTED WITH INTERIOR TENANT-FURNISHED WINDOW SCREENS.
- EXISTING FIRE-SPRINKLER SYSTEM TO REMAIN. MODIFY HEAD LOCATIONS AS REQ'D BY NEW LAYOUT.
- EXISTING FIRE ALARM SYSTEM TO REMAIN. FOR SYSTEM MODIFICATIONS, SEE ELEC DWGS.
- PROVIDE PAINTED FINISH AT ALL GWB/PLASTER WALLS AND CEILING.
- WHERE SINKS MEET THE WALL, SEAL WITH SILICON SEALANT.

LIGHT FIXTURE LEGEND:

- EXISTING TRACK LIGHTS TO REMAIN. REPLACE EXISTING LAMPS WITH SHATTER-PROOF LEDS.
- EXISTING WALL SCONCE TO REMAIN.
- NEW TFCI PENDANT LIGHT FIXTURES AT EXISTING FIXTURE LOCATIONS. PROVIDE WITH SHATTER-PROOF LED LAMPS.




Applied Electronically by L&I User:



ALLYSON MEHLEY
ALLYSON MEHLEY

EQUIP INFO						SIZE (IN, LBS)				ELECTRICAL						PLUMBING				HVAC	ANSI CERT	NOTES
EQUIP #	EQUIP DESCRIPTION	MFR	MAKE / MODEL	QTY	LOCATION	W	D	H	WT	V	Hz	Ph	Amp	Watt	PLUG / HARD WIRE (HW)	SUPPLY	SUPPLY PRESSURE	DRAIN	OTHER	HEAT OUTPUT (BTU/HR)		
E01	ESPRESSO MACHINE	SYNESSO	MVP HYDRA 2-GROUP	1	CTR-TOP	30	24	21	154						PLUG (NOT INCLUDED)	CW, 3/8" MPT W/ SHUT-OFF	50 PSI MIN	YES, WITHIN 4'	E29 WATER FILTRATION	-		NSF / ANSI 4
E02	GRINDER	MAHLKONIG	E665	1	LOOSE	8	11	23	25	110-127	60	1	16	580	PLUG	-	-	-	-	-		NSF / ANSI 8
E03	GRINDER	MAHLKONIG	GUA710	1	LOOSE	9	13	25	40	110-115	60	1	-	1100	PLUG	-	-	-	-	-		NSF / UL
E04	TAMPER, AUTO GRINDER, CERAMIC BURR	PUORESS	Q2	1	LOOSE	5	6	9	11	100-230	60	1	-	60	PLUG	-	-	-	-	-		NSF-8
E05		BARATZA	VARIO	1	LOOSE	5	7	14	9	100-120	60	1	-	130	PLUG	-	-	-	-	-		UL
E06	MILK PITCHER RINSE	ESPRESSO PARTS	EPPR715	1	CTR-TOP, SEALED	7	15	1	5	-	-	-	-	-	-	CW, 3/8"	15-30 PSI	YES	-	-		NSF / ANSI 169
E07	KNOCK BOX	VOLLRATH	E06064-KB	1	CTR-TOP, SEALED	7	7	4	0	-	-	-	-	-	-	-	-	-	-	-		NSF
E08	COFFEE BREWER, DOUBLE 1-GAL DISPENSERS, DRIP COFFEE	FETCO	CBS-2132XTS-E213252	1	CTR-TOP	20	21	26	92	200-240	-	1	26	-	HW, 2+G, TERMINAL BLOCK	CW, 3/8", MALE	20-75 PSI, 1.5 GAL/MIN	YES	E29 WATER FILTRATION	-		NSF / UL
E09		ZOJIRUSHI	AY-AE25N	4	LOOSE	8	9	20	-	-	-	-	-	-	-	-	-	-	-	-		NSF
E10	SCALE	OHAUS	COMPASS CX1201	1	LOOSE	6	8	2	-	-	-	-	-	-	-	-	-	-	-	-		UL
E11	RECYCLE BINS, 95 GAL	RUBBERMAID	H-2837	3	LOOSE	27	36	46	39	-	-	-	-	-	-	-	-	-	-	-		N/A
E12	ICE MACHINE, AIR COOLED	PRODIGY PLUS, SCOTSMAN	C0322MA-1E-B322S	1	FLOOR, SPACED	22	24	67	356	115	60	1	15	-	HW, 2+G	CW, 3/8"	20-80 PSI	3/4"	E29 WATER FILTRATION	5200		NSF
E13	KEGERATOR	GALAXY EQUIP	177-KEGRTR-BLK	1	U-CTR	22	27	45	77	115	60	1	2	-	NEMA 5-15P, 5' CORD	-	-	-	-	-		UL
E14	REFRIGERATOR, 3-DOOR, REACH-IN, W/ CASTERS	BEVERAGE-AIR	RB72HC	1	FLOOR, MOVABLE	76	34	78	690	115	60	1	7	-	NEMA 5-15P, 8' CORD	-	-	-	-	2808		UL
E15	DISHWASHER	HOBART	LXE-C	1	U-CTR	24	26	33	150	120	60	1	20	-	PLUG (NOT INCLUDED)	CW, 3/4" MALE, W/ SHUT-OFF, LINE STRAINER	15-65 PSI	3/4"	120 DEG MIN SUPPLY TEMP	-		NSF / UL
E16	OVEN, ELECTRIC CONVECTION, W/ CASTERS	BLODGETT	BDO-100-E, DOUBLE	1	FLOOR, MOVABLE	39	37	71	980	220-240	60	1	44	1100	-	-	-	-	-	TYPE 2 HOOD		NSF
E17	TRASH BINS, 95 GAL	RUBBERMAID	H-7938	3	LOOSE	29	34	45	33	-	-	-	-	-	-	-	-	-	-	-		N/A
E18	PROOFING CABINET, W/ CASTERS	AVANTCO	177HPI1836	1	FLOOR, MOVABLE	23	34	68	-	120	60	1	12	1440	NEMA 5-15P	-	-	-	-	-		NSF
E19	TOASTER	WARING	WCT708	1	LOOSE	13	11	8	6	120	60	1	-	1800	NEMA 5-15P	-	-	-	-	-		NSF / UL
E20	NOT USED																					
E21	TABLE	REGENCY	600TS3696S	1	LOOSE	96	36	34	139	-	-	-	-	-	-	-	-	-	-	-		NSF
E22	COMMERCIAL MIXER	DOYON	AEF-0155P	1	LOOSE	18	30	40	540	208-240	60	1	10	2400	NEMA 6-15	-	-	-	-	-		ETL
E23	SINK, 3-COMPARTMENT	REGENCY	600S3162018G	1	P-FIXT	88	26	45	104	-	-	-	-	-	-	CW, HW	-	1.5" IPS	-	-		NSF
E24	SINK, FOOD PREP	STEELTON	522CS11515	1	P-FIXT	21	21	44	-	-	-	-	-	-	-	CW, HW	-	1.5" IPS	-	-		NSF
E25	SINK, HANDWASH	REGENCY	600HS17SP	1	P-FIXT	17	15	14	-	-	-	-	-	-	-	CW, HW	-	1.5" IPS	E29 WATER FILTRATION	-		NSF
E26	SCALE, LARGE DOUGH	ADAM EQUIPMENT	CPW PLUS 35M	1	LOOSE	20	20	2	-	120	-	-	-	-	PLUG	-	-	-	-	-		UL
E27	REFRIGERATOR, 1-DOOR, REACH-IN, W/ CASTERS	BEVERAGE-AIR	RB23HC-15	1	FLOOR, MOVABLE	28	34	85	322	115	60	1	3	-	NEMA 5-15P	-	-	-	-	1480		UL
E28	REFRIGERATOR, DISPLAY	BEVERAGE-AIR	MT08-1HBW EVERPURE, EV9328-06	1	FLOOR, SPACED	19	21	72	189	115	60	1	2	-	NEMA 5-15P	-	-	-	-	938		UL
E29	WATER PURIFIER	PENTAIR		1	IN-LINE	30	7	26	49	-	-	-	-	-	-	3/4"	10-125 PSI, NON-SHOCK	-	-	-		NSF
E30	ICE BIN, DROP-IN	ADVANCE TABCO	D-36-IBL	1	CTR-TOP, SEALED	33	18	14	67	-	-	-	-	-	-	-	-	1" IPS	-	-		NSF
E31	NOT USED																					
E32	NOT USED																					
E33	NOT USED																					
E34	NOT USED																					
E35	THERMOMETER	MILJOCO	S3513091Z	MULTI	LOOSE																	
E36	BREAD TABLE, SST W/ WOOD TOP	ADVANCE TABCO	H2S-366	1	LOOSE	72	36	36	-	-	-	-	-	-	-	-	-	-	-	-		NSF
E37	FOOD PROCESSOR	WARING	WFP16S	1	LOOSE	9	14	19	-	120	-	-	-	-	5-15P	-	-	-	-	-		ETL
E38	STAND MIXER, COMMERCIAL 8-QUART	KITCHENAID	KSM8990	1	LOOSE	14	15	17	25	120	60	-	-	500	5-15P	-	-	-	-	-		NSF

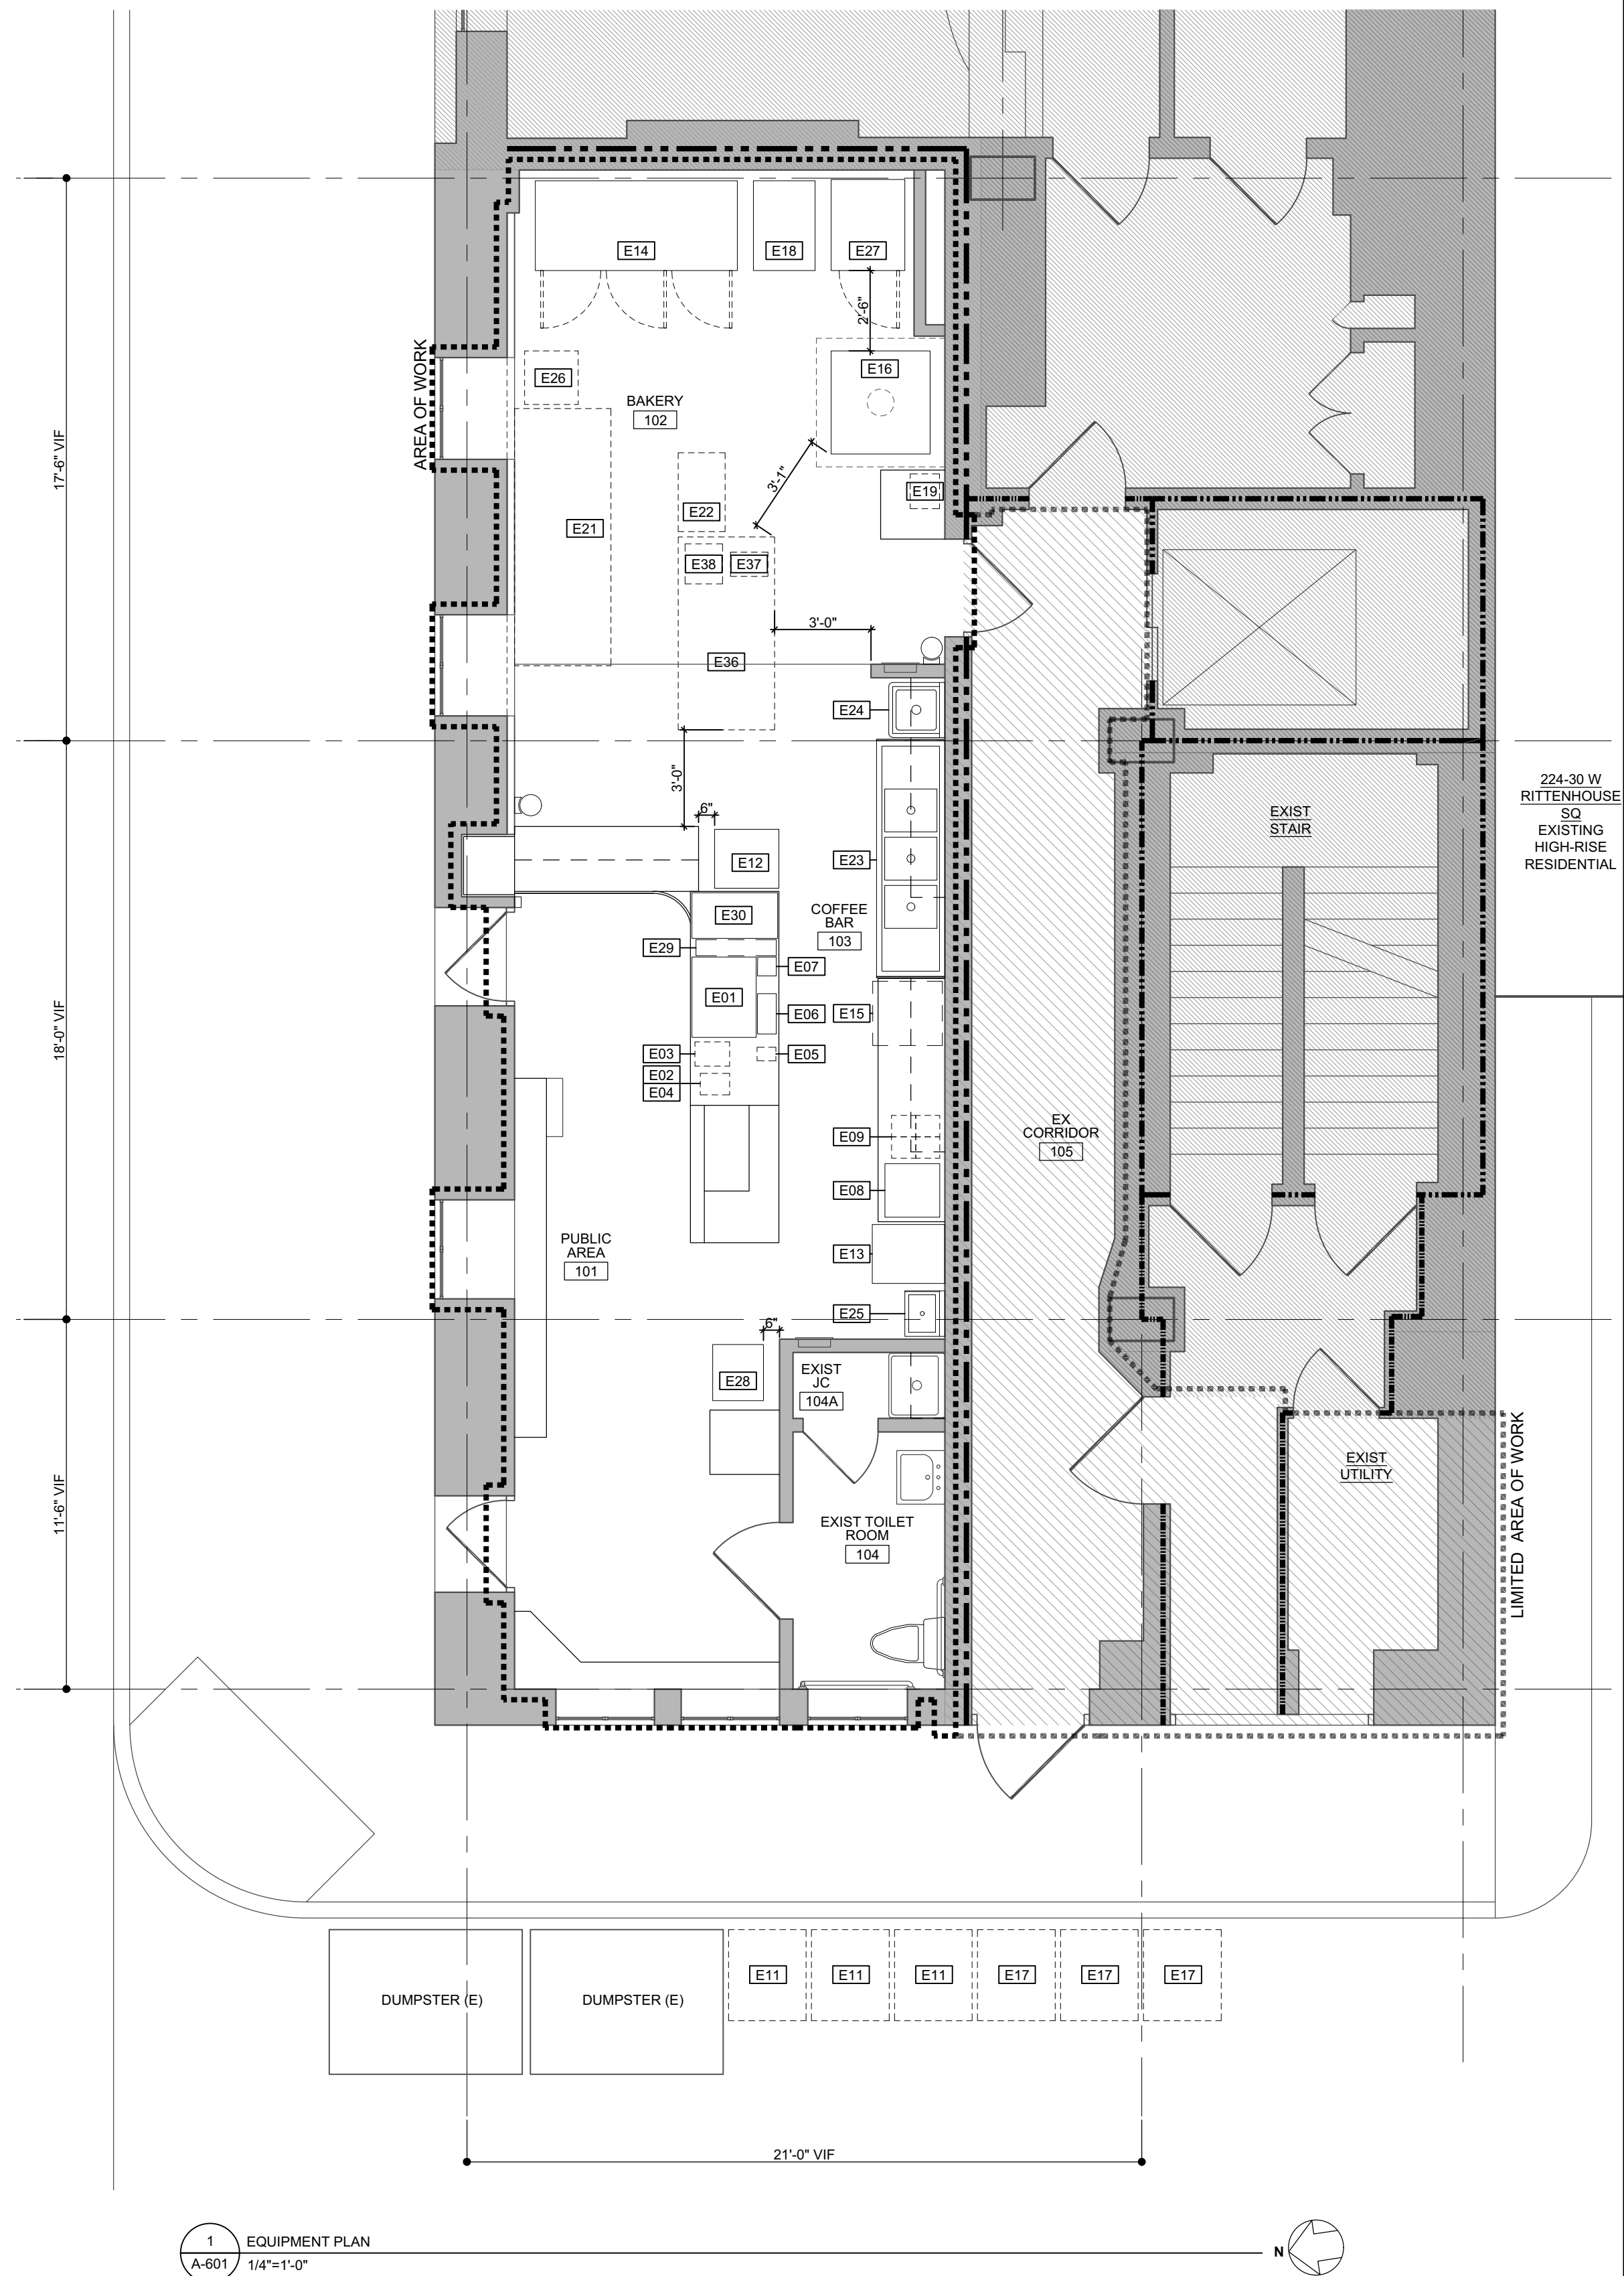

A-601

