# ADDRESS: 6625 LINCOLN DR

Proposal: Construct single-family residence on subdivided parcel at 6627 Lincoln Drive

Review Requested: Final Approval

Owner: 6625 Lincoln Dr LLC

Applicant: Raymond Rola, Raymond F. Rola Architect

History: 1902; Nichols-Goehring House; H.C. Wise & W.W. Potter, architects; addition, Rankin,

Kellogg & Crane, 1921

Individual Designation: 1/11/2019

District Designation: None

Staff Contact: Meredith Keller, meredith.keller@phila.gov

**OVERVIEW:** This application proposes to construct a new house on a subdivided section of the property at 6625 Lincoln Drive. The new property with the new house would be known as 6627 Lincoln Drive. The Historical Commission designated the Nichols-Goehring House property at 6625 Lincoln Drive on 11 January 2019. The designated parcel is shown on a site plan from the nomination in Figure 1. The property owner subdivided the property that was known as 6625 Lincoln Drive into five parcels known as 6619, 6621, 6623, 6625, and 6627 Lincoln Drive with a deed that is dated 9 January 2019 and recorded on 11 January 2019, the day that the property was designated. A zoning permit for the subdivision had been issued in 17 September 2018. The Historical Commission notified the property owner that it would consider designating the property at 6625 Lincoln Drive on 12 November 2018, thereby initiating its jurisdiction over the entirety of the property originally known as 6625 Lincoln Drive, which was later subdivided into five properties.

In May 2020, the Historical Commission was notified that three houses were under construction at 6625 Lincoln Drive, presumably without permits. The staff visited the site and photographed the three houses under construction as well as one foundation being excavated. The staff contacted the Department of Licenses & Inspections about the construction that was underway without the Historical Commission's review or approval. The Department responded that the houses had been permitted under the addresses 6619, 6621, and 6623 Lincoln Drive. The permits had been applied for on 26 April 2019 and issued on 10 September 2019. A Google Streetview photograph shows that site work and the construction of the foundations was underway in November 2019. The Department of Licenses & Inspections did not refer the new construction permit applications to the Historical Commission because they had been issued under 6619, 6621, and 6623 Lincoln Drive, addresses that did not exist at the time of designation; only 6625 Lincoln Drive was identified as historic. The permit referral system was designed to catch subdivisions and carry the historic designation marker from the parent to the child property, but it did not in this case. The Department of Licenses & Inspections declined to revoke the permits because the mistake had been made within the City system and revoking the permits would open the City to liability.

The fourth house contemplated for the site was not permitted with the other three in 2019. Despite not having any permits for construction at 6627 Lincoln Drive, the developer began excavating for a foundation in the spring of 2020. The staff photographed the unpermitted work underway on 11 May 2020 and requested a violation for work without a permit on 12 May 2020 through the City's 311 system. That violation was apparently never issued. This application proposes the new house for the new parcel at 6627 Lincoln Drive. While the first three houses were located off to the side of the historic house, the fourth house would be situated directly in front of the historic house. The excavation for the foundation has been completed. The proposed house would be three stories tall and clad in Wissahickon schist at the front and stucco at the sides and rear. A one-story garage wing would be entered from a drive at the rear.

# **SCOPE OF WORK:**

Construct house

### STANDARDS FOR REVIEW:

The Secretary of the Interior's Standards for the Treatment of Historic Properties and Guidelines include:

- Standard 9: New additions, exterior alterations, or related new construction shall not
  destroy historic materials, features, and spatial relationships that characterize the
  property. The new work shall be differentiated from the old and shall be compatible with
  the massing, size, scale, and architectural features to protect the historic integrity of the
  property and its environment.
  - While the design of the proposed house is compatible with the historic house and site, its location in the front yard of the historic house is not. The construction of a house in the front yard of the historic house would destroy historic spatial relationships. The new work would not protect the historic integrity of the property.
- Guidelines for New Exterior Additions to Historic Buildings and Related New Construction:
  - Recommended: Locating new construction far enough away from the historic building, when possible, where it will be minimally visible and will not negatively affect the building's character, the site, or setting.
  - Not Recommended: Placing new construction too close to the historic building so that it negatively impacts the building's character, the site, or setting.
  - Recommended: Considering the design for related new construction in terms of its relationship to the historic building as well as the historic district and setting.
  - Not Recommended: Adding new construction that results in the diminution or loss of the historic character of the building, including its design, materials, location, or setting.
  - The proposed house will be highly visible and will negatively impact the historic building's character, site, and setting. The new construction will result in the diminution or loss of the historic character of the older building and its setting. The yard directly in front of the historic house should be left open to maintain the historic space and views.

**STAFF RECOMMENDATION:** Denial, pursuant to Standard 9 and Guidelines for New Exterior Additions to Historic Buildings and Related New Construction.



Figure 1: The designation boundary as described in the nomination is shown in red. Source: Philadelphia Historical Commission.



Figure 2: An aerial view of the site with the three new houses at the bottom, the historic house at the center right, and 6627 Lincoln Drive outlined in purple with the foundation excavation visible.



Figure 3: View from Lincoln Drive of the historic house with the excavated foundations in the foreground, 2020. Source: Cyclomedia.



Figure 4: View from Lincoln Drive of the historic house in the distance, the excavated foundations at left, and the new construction at the right of the image, 2020. Source: Cyclomedia.



January 8, 2021
Philadelphia Historic Commission
1515 Arch Street, 13<sup>th</sup> Floor
Philadelphia, PA 19102

Proposed Residence at 6627 Lincoln Drive

To whom it may concern,

Attached please find the Construction Drawings and other presentation materials for the above mentioned project. The project involves the construction of a single family home of approximately 5620 square feet on a parcel of land containing 10,072 square feet. We are requesting a final review and approval of this project.

On 9-17-2018, a subdivision plan was approved by the City of Philadelphia Department of Licenses and Inspections. The original parcel of land known as 6625 Lincoln Drive contained 52.498 square feet of land and included the structure known as the "Nichols-Goehring House". This house is listed in the Philadelphia register of Historic Places. The nomination form for property prior to subdivision is included in this package. The original parcel of land was subdivided into 5 lots. One of the lots now known as 6627 Lincoln drive, retains the Nichols-Goehring House and the driveway leading up to the house. Three single family homes have already been built on three of the subdivided parcels and the proposal included in this package is for the construction of the last empty parcel.

The original plans for the house were submitted for Zoning Approval on 5-22-2020 and the plans were refused for not meeting the requirements for construction on steep slopes. A variance was applied for however this variance was denied. A new plan for the house was submitted which eliminated the separate driveway onto Lincoln Drive and instead created an easement for joint use of the existing Nichols-Goering House driveway. The upside of this revised plan from a historical perspective is that the original stone and iron fencing are not disturbed in front of this parcel.

The design for the proposed house is inspired by styles and materials of many of the homes in the area. It is also inspired by "Tigbourne Court" a home in England designed by Sir Edwin Lutyens. It is intended to evoke the English Country House style. The entrance front has a three story composition of two gables with an asymmetrical entry. The entrance is recessed with a stone archway. The front façade is intended to be clad in Wissahickon Schist stone and a beige stucco on the sides and rear. The windows are primarily narrow casements with simulated divided lights. The first floor front windows feature transoms over the operable casement windows. The historical front stone wall and iron railing are to be retained. Access to the single car garage is to be by way of a shared easement with the Nichols-Goehring house.

Raymond F. Rola, AIA









SEAL



OWNER

6625 LINCOLN DRIVE LLC. 1218 Green Street Philadelphia, pa 19123

П	Ι.			
		Δ	DATE	DESCRIPTION
			1/7/18	ZONING
	'		4/24/19	PERMIT SET
			2/13/20	3RD FLR. DIMS
	ľ		11/16/20	PERMIT SET
	ľ			
	1			
	Ι.			

# NEW RESIDENCES @ 6625 LINCOLN DR.

PROJECT LOCATION

6625 LINCOLN DRIVE PHILADELPHIA, PA


BLOCK: -	
LOT: -	
SHEET TITLE :	

PROJECT NO. 18503		
SCALE : AS NOTED		
DATE: 2018		
DRAWN BY: RR		
REVIEWED BY: RR		
SHEET NO.		

**PHOTOS** 

# PROPOSED NEW RESIDENCE 6627 LINCOLN DRIVE (PARCEL E)

PHILADELPHIA, PA

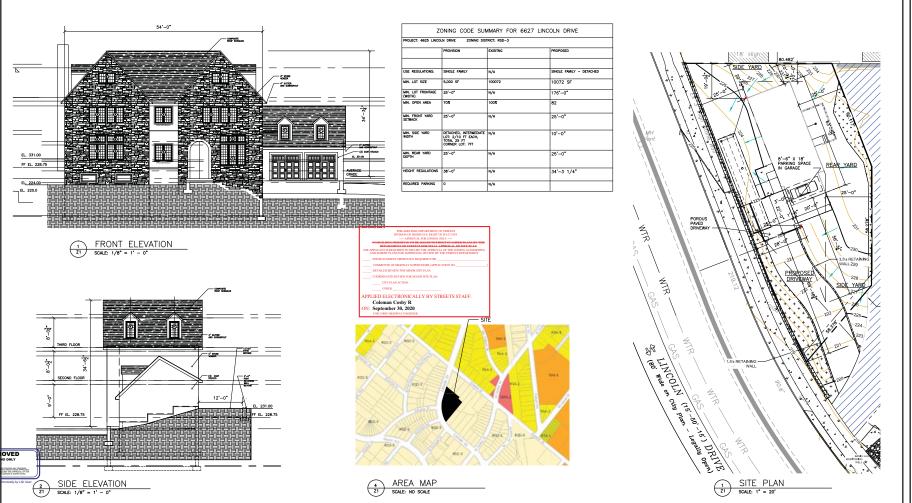



1518 walnut street suite 1300, philadelphia pa, 19102 t: 215.546.3155 f. 215.545.3999



OWNER

6625 LINCOLN DRIVE LLC. 1218 GREEN STREET PHILADELPHIA, PA 19123

Δ	DATE	DESCRIPTION
_	05/22/20	ZONING
_	09/29/20	ZONING
_		
_		
_		
_		
=		

NEW RESIDENCES @ 6627 LINCOLN DR.

PROJECT LOCATION

6625 LINCOLN DRIVE PHILADELPHIA, PA

BLOCK: -LOT: -SHEET TITLE:

PROJECT NO. 18503 SCALE : AS NOTED DATE : 2018 DRAWN BY : RR

DRAWN BY: RR
REVIEWED BY: RR
SHEET NO.

 $\mathsf{Z}^1$ 

# PROPOSED NEW RESIDENCE 6627 LINCOLN DRIVE (PARCEL E)

PHILADELPHIA, PA




# **ABBREVATIONS**

ACQUIRTOAL CEILING TILE
ADDAYS FINISHED FLOOR
ALUMINUM
ALTERNATE
BOARD
BOULDING
BOUND
BOUND
BOUTOM
COLL FORMED METAL FRAMING
CEILING
COLLING
C INSULATION LAVATORY LONG LEG HORIZONTAL LONG LEG VERTICAL LIGHT \_\_ING) MASONRY A.C.T.
ADJ.
AFF.M.
AFF.M.
AFF.M.
AND.
BD.
BD.
BD.
BOT.
CFMF
CCL.
CONT.
C MOUNTED
METAL
META ELECTRICAL
EQUAL TO THE WATER COOLER
EDITING WATER
EDITING STANDARD STEEL STRUCTURE (AL) TEMPERED THICK TUBULAR STEEL TYPICAL
UNLESS NOTED OTHERWISE
VINYL COMPOSITION TILE
VERTICAL
WATER CLOSET
WOOD
WATER HEATER WITH BY METAL BLDG. SUPPLER

# LEGEND



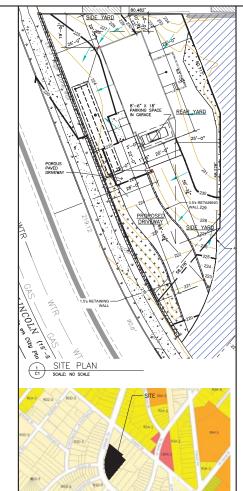

AREA MAP SCALE: NO SCALE

# LIST OF DRAWINGS

- A1 BASEMENT AND FIRST FLOOR PLANS
- A2 SECOND AND THIRD FLOOR PLANS A3 ROOF PLAN A4 ELEVATIONS
- FI EVATIONS
- A6 ELEVATIONS
  A7 BUILDING SECTIONS
  A8 BUILDING SECTIONS
  A9 BUILDING SECTIONS
- A10 WALL SECTIONS
- A11 WALL SECTIONS A12 SCHEDULES
- S1 FOUNDATION PLAN
- S2 FRAMING PLANS
- S3 FRAMING PLANS WALL BRACING SECTIONS & DETAILS

## **BUILDING DATA**

BASEMENT FLOOR 1,385 SF SECOND FLOOR 1,385 SF

TOTAL SO FOOTAGE - 5 620 SE

CONSTRUCTION TYPE - V-B SPRINKI ERED RUII DING - NO

# APPLICABLE BUILDING CODES

INTERNATIONAL RESIDENTIAL CODE 2018 NATIONAL ELECTRICAL CODE 2017 INTERNATIONAL ENERGY CONSERVATION CODE 2018 INTERNATIONAL FIRE CODE 2018 INTERNATIONAL FUEL GAS CODE 2018 INTERNATIONAL MECHANICAL CODE 2018 INTERNATIONAL PLUMBING CODE 2018



SEAL



6625 LINCOLN DRIVE LLC. 1218 GREEN STREET PHILADELPHIA, PA 19123

Δ	DATE	DESCRIPTION
	1/7/18	ZONING
П	4/24/19	PERMIT SET
	2/13/20	3RD FLR. DIMS
	11/16/20	PERMIT SET
П		
$\neg$		

#### **NEW RESIDENCES @** 6625 LINCOLN DR.


6625 LINCOLN DRIVE

BLOCK: -

PROJECT NO. 18503

SCALE : AS NOTED DATE: 2018

DRAWN BY · RR REVIEWED BY: RR

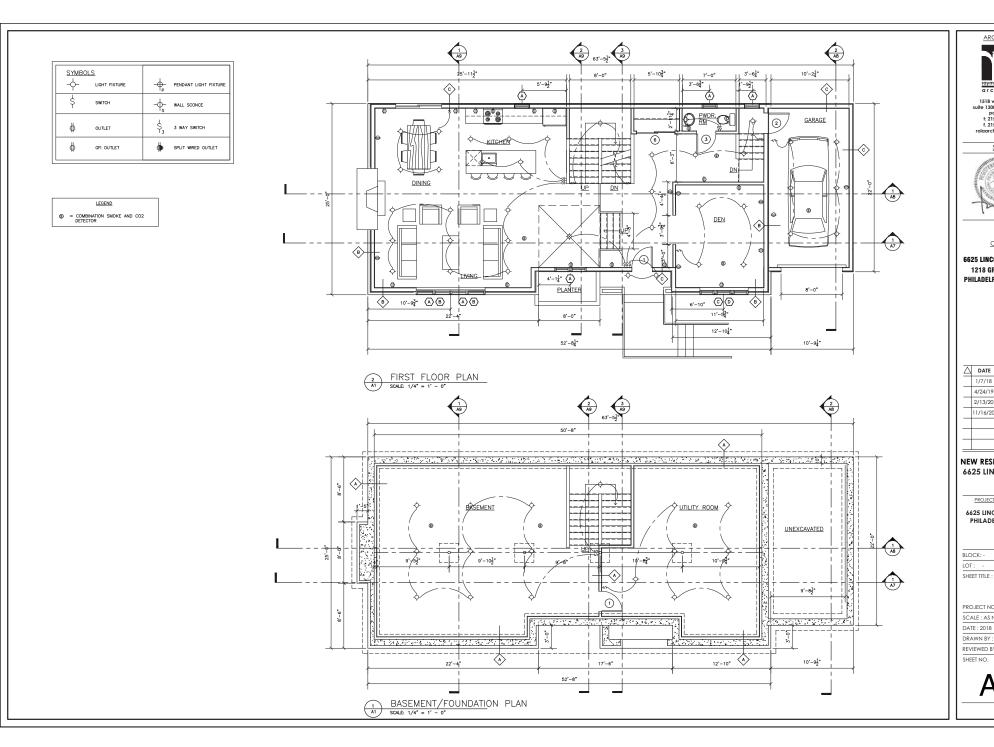



SEAL



<u>OWNER</u>

6625 LINCOLN DRIVE LLC 1218 GREEN STREET PHILADELPHIA, PA 19123

$\Delta$	DATE	DESCRIPTION
	1/7/18	ZONING
	4/24/19	PERMIT SET
	2/13/20	3RD FLR. DIMS
	11/16/20	PERMIT SET

**NEW RESIDENCES @** 6625 LINCOLN DR.

PROJECT LOCATION


6625 LINCOLN DRIVE PHILADELPHIA, PA

BLOCK: -LOT:


PROJECT NO. 18503

SCALE : AS NOTED DATE : 2018

DRAWN BY : RR REVIEWED BY: RR

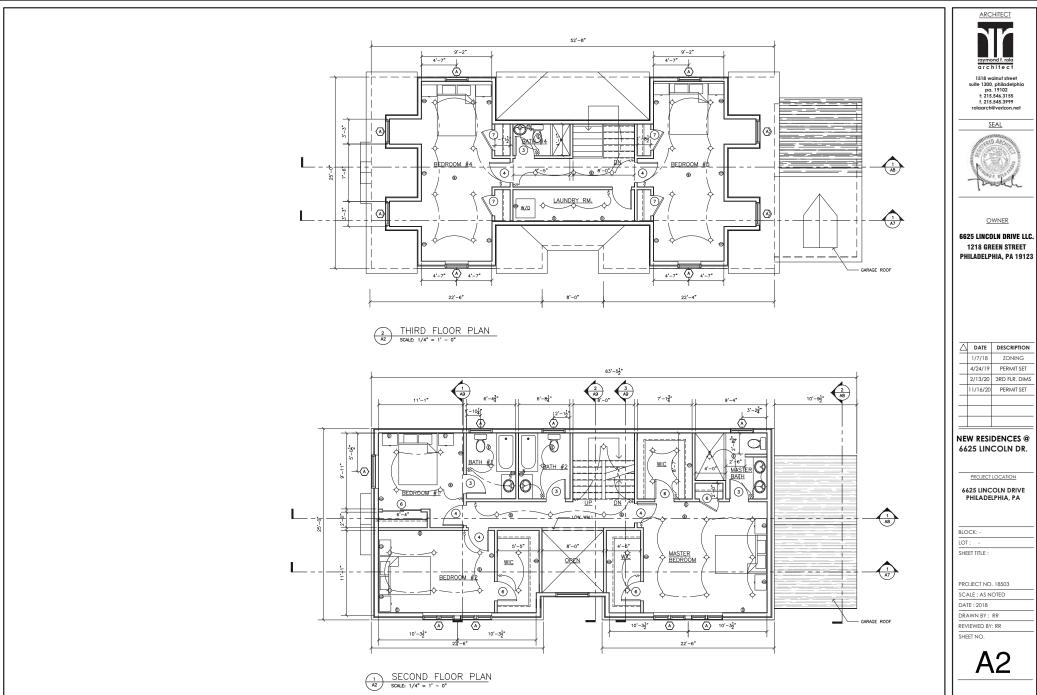

Δ	DATE	DESCRIPTION
	1/7/18	ZONING
	4/24/19	PERMIT SET
П	2/13/20	3RD FLR. DIMS
П	11/16/20	PERMIT SET
П		
П		

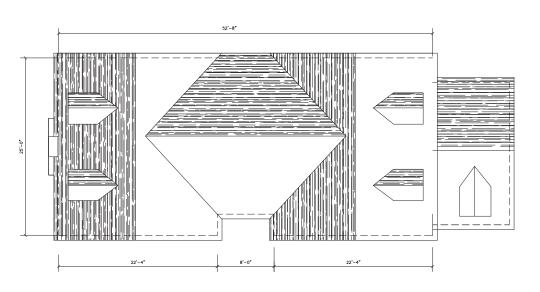

1 ROOF PLAN A3 SCALE: 1/4" = 1' - 0"



1518 walnut street suite 1300, philadelphia pa, 19102 t: 215.546.3155 f. 215.545.3999 rolaarch@verizon.net

SEAL



OWNER

#### 6625 LINCOLN DRIVE LLC. 1218 GREEN STREET PHILADELPHIA, PA 19123

1			
	Ζ	DATE	DESCRIPTION
		1/7/18	ZONING
		4/24/19	PERMIT SET
		2/13/20	3RD FLR. DIMS
		11/16/20	PERMIT SET

# NEW RESIDENCES @ 6625 LINCOLN DR.

PROJECT LOCATION

#### 6625 LINCOLN DRIVE PHILADELPHIA, PA

BLOCK: -LOT: -SHEET TITLE:

PROJECT NO. 18503


SCALE: AS NOTED

DATE: 2018

DRAWN BY: RR

REVIEWED BY: RR

SHEET NO.

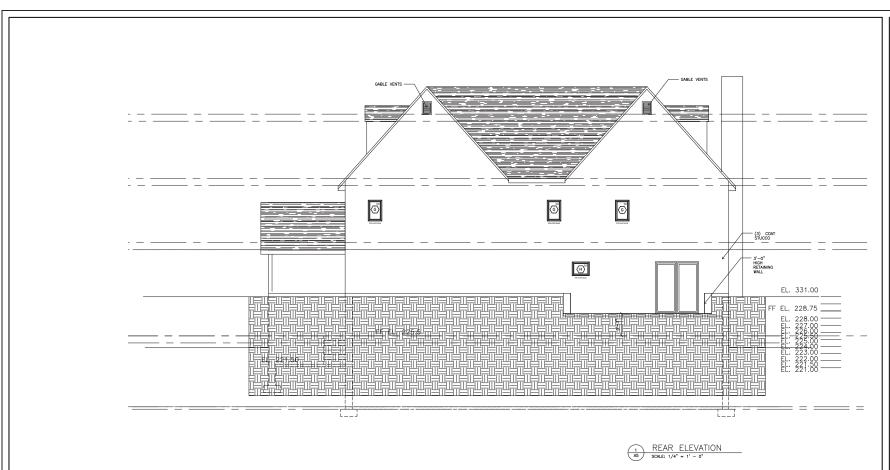



SEAL



OWNER

6625 LINCOLN DRIVE LLC. 1218 GREEN STREET PHILADELPHIA, PA 19123

Δ	DATE	DESCRIPTION
	1/7/18	ZONING
	4/24/19	PERMIT SET
	2/13/20	3RD FLR. DIMS
	11/16/20	PERMIT SET
_		

# NEW RESIDENCES @ 6625 LINCOLN DR.

PROJECT LOCATION

6625 LINCOLN DRIVE PHILADELPHIA, PA

BLOCK: LOT: SHEET TITLE:


PROJECT NO. 18503


SCALE: AS NOTED

DATE: 2018

DRAWN BY: RR

REVIEWED BY: RR

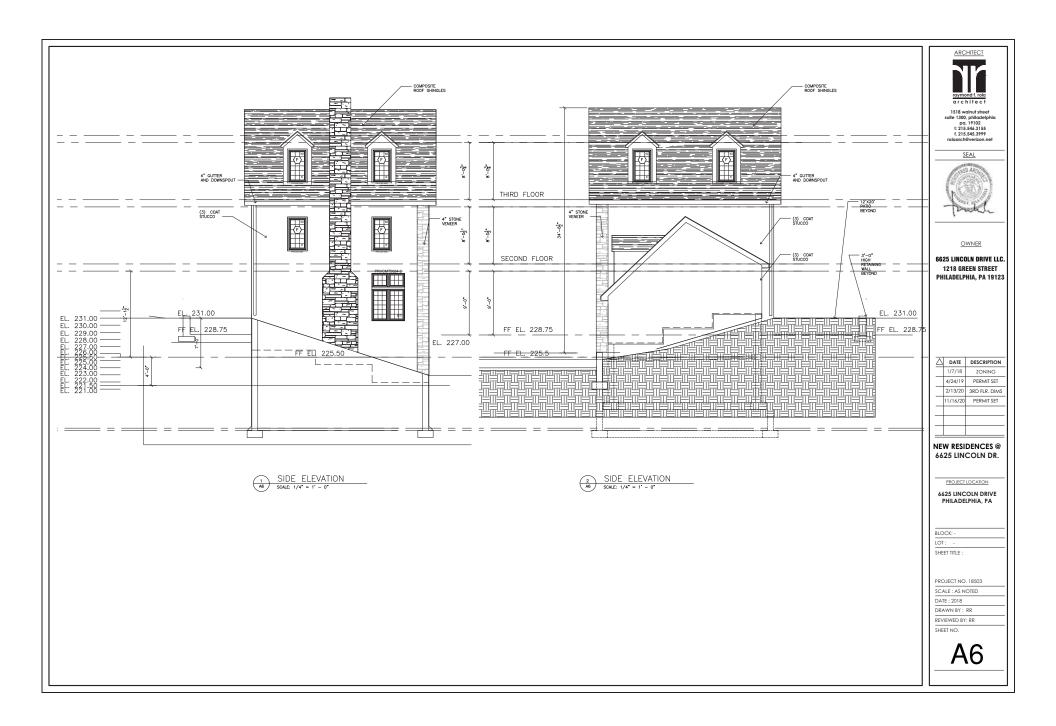

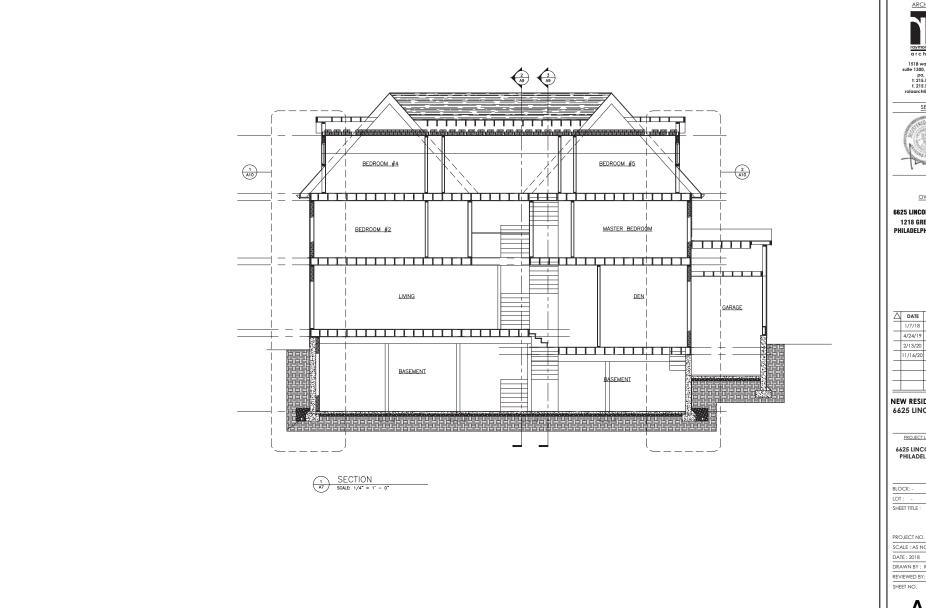



SEAL



6625 LINCOLN DRIVE LLC. 1218 GREEN STREET PHILADELPHIA, PA 19123

$\overline{\Delta}$	DATE	DESCRIPTION
	1/7/18	ZONING
_	4/24/19	PERMIT SET
	2/13/20	3RD FLR. DIMS
	11/16/20	PERMIT SET
_		
_		

**NEW RESIDENCES @** 6625 LINCOLN DR.


PROJECT LOCATION

6625 LINCOLN DRIVE PHILADELPHIA, PA

PROJECT NO. 18503

SCALE : AS NOTED

DRAWN BY: RR REVIEWED BY: RR

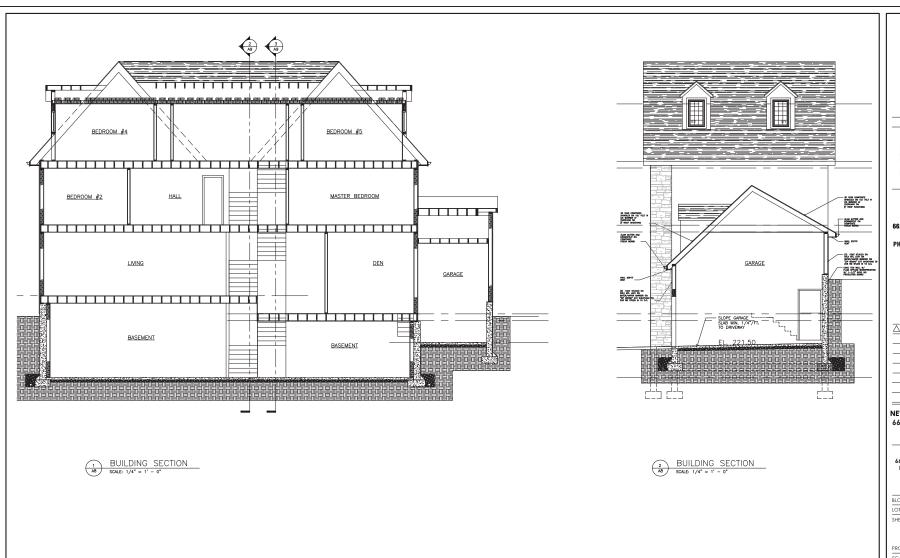



SEAL



OWNER

6625 LINCOLN DRIVE LLC. 1218 Green Street Philadelphia, pa 19123

Δ	DATE	DESCRIPTION
	1/7/18	ZONING
	4/24/19	PERMIT SET
	2/13/20	3RD FLR. DIMS
	11/16/20	PERMIT SET

NEW RESIDENCES @ 6625 LINCOLN DR.

PROJECT LOCATION

6625 LINCOLN DRIVE PHILADELPHIA, PA

BLOCK: -LOT: -SHEET TITLE:


PROJECT NO. 18503

SCALE: AS NOTED

DATE: 2018

DRAWN BY: RR

REVIEWED BY: RR

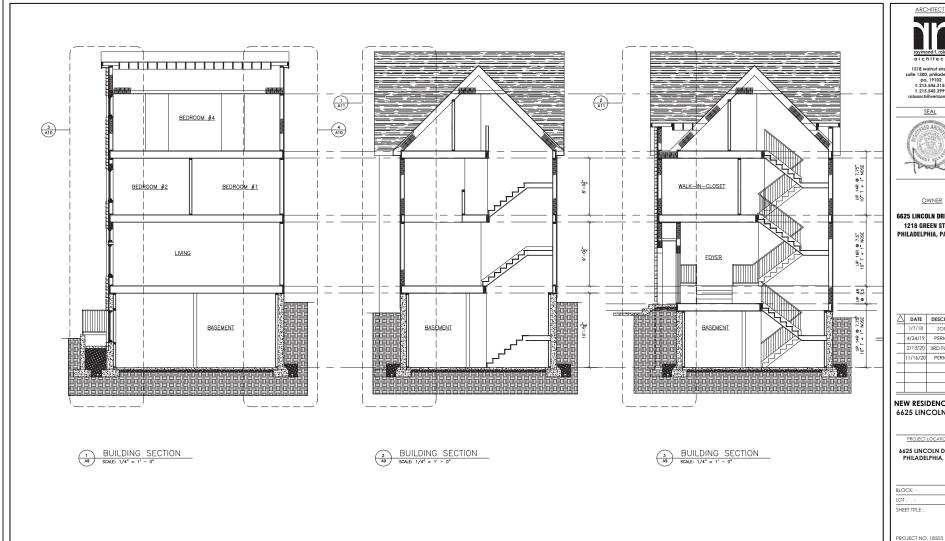



SEAL



OWNER

6625 LINCOLN DRIVE LLC. 1218 GREEN STREET PHILADELPHIA, PA 19123

Δ	DATE	DESCRIPTION
	1/7/18	ZONING
	4/24/19	PERMIT SET
	2/13/20	3RD FLR. DIMS
	11/16/20	PERMIT SET


NEW RESIDENCES @ 6625 LINCOLN DR.


PROJECT LOCATION

6625 LINCOLN DRIVE PHILADELPHIA, PA

SHEET TITLE :


SCALE : AS NOTED DATE : 2018 DRAWN BY: RR REVIEWED BY: RR

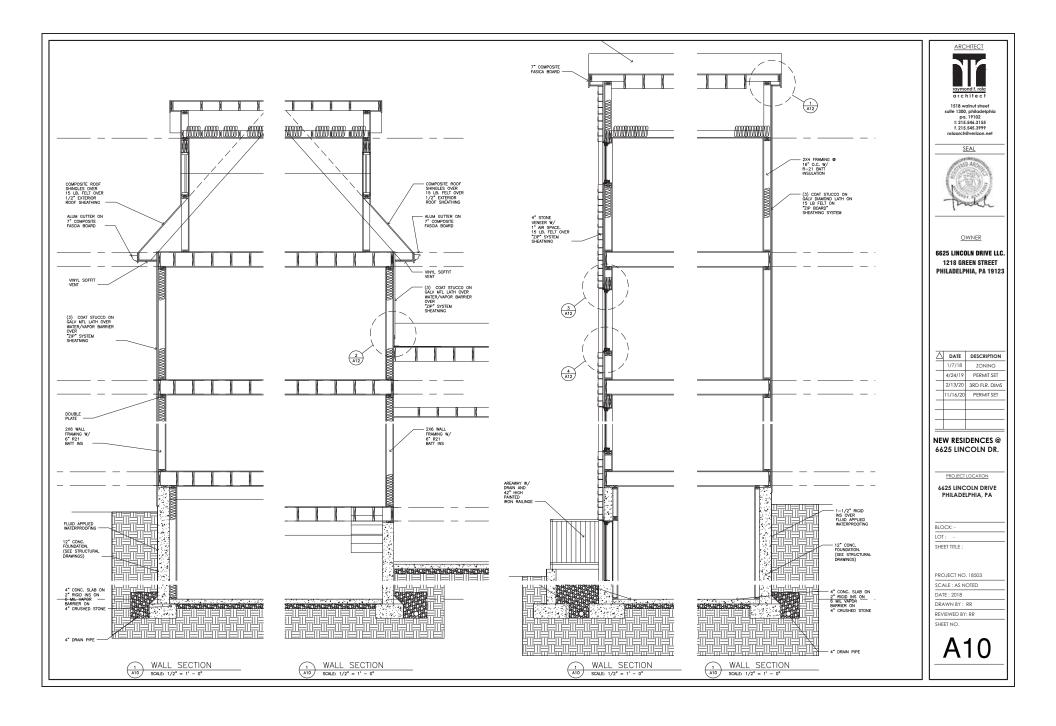

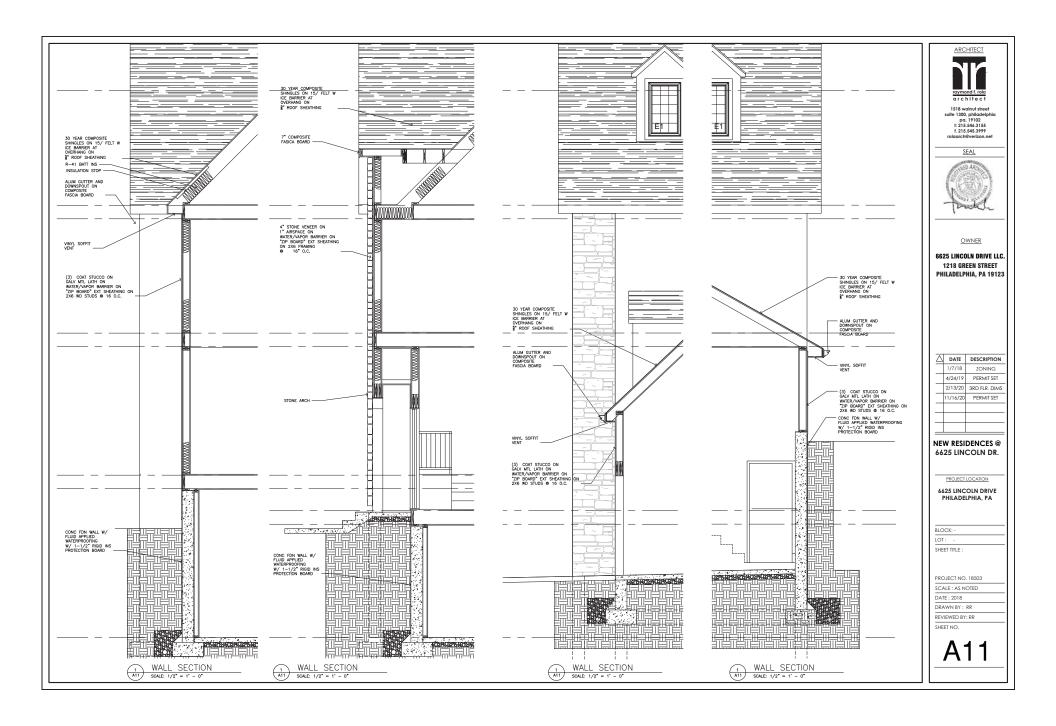



				DO	DOR S	SCHE	DULE	Ε			
	DOOR					FRAME					
NO.	SI	ZE		STYLE	MATL	FINISH	MATL	FINISH	HARDWARE SET	NOTES	
	W	HT	THICK								
1	3"-0"	7'-0"	1-3/4"	CUSTOM	WD / GL	CLEAR	WD	PNT	TO BE SELECTED	NEW FRONT DOOR	
2	3"-0"	7'-0"	1-3/4"	CUSTOM	WD / GL	CLEAR	WD	PNT	TO BE SELECTED	NEW REAR DOOR AND PILOT HOUSE DOOR	
3	2'-6"	6'-8"	1-3/8*	PANEL	WD	PNT	WD	PNT	PRIVACY LOCK	BATHROOM DOORS	
4	2'-8"	6'-8"	1-3/8"	PANEL	WD	PNT	WD	PNT	TO BE SELECTED	BEDROOM DOORS	
5	(2)2'-0"	6'-8"	1-3/8"	PANEL	WD	PNT	WD	PNT	TO BE SELECTED	SUDER	
6	(2)2'-6"	6'-8*	1-3/8"	PANEL	WD	PNT	WD	PNT	TO BE SELECTED	CLOSET DOORS	
7	2'-6"	6'-8"	1-3/8"	PANEL	WD	PNT	WD	PNT	TO BE SELECTED	CLOSET DOORS	
8	2"-8"	6'-8*	1-3/8"	LOUVER	WD	PNT	WD	PNT	TO BE SELECTED	HVAC CLOSET DOOR	
9	5'-0"	6'-8"	1-3/8*	SLIDER	VINYL	VINYL	VINYL	VINYL.	TO BE SELECTED	"JELD WEN" VSD6080	

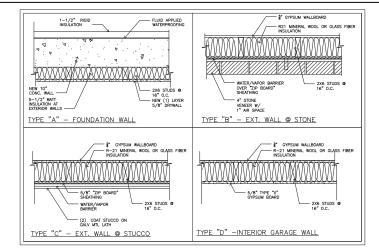



SEAL



OWNER

6625 LINCOLN DRIVE LLC. 1218 GREEN STREET PHILADELPHIA, PA 19123



#### **NEW RESIDENCES @** 6625 LINCOLN DR.

PROJECT LOCATION

6625 LINCOLN DRIVE PHILADELPHIA, PA

BLOCK: -LOT: SHEET TITLE :

PROJECT NO. 18503 SCALE : AS NOTED

DATE: 2018 DRAWN BY : RR REVIEWED BY: RR



WALL SECTION SCALE: 1/2" = 1' - 0"













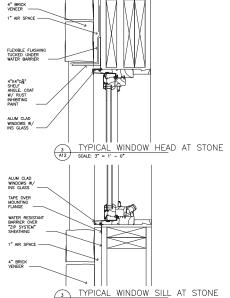

SCALE: 3" = 1' - 0"

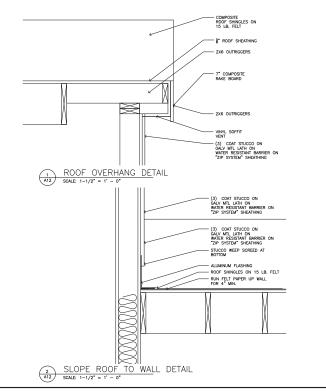

## GENERAL NOTES THIS PLAN IS TO BE USED FOR TITLE OR CONVEYANCE PURPOSE ONLY. PLAN MADE AS PER INSTRUCTIONS OF CLIENT ATTENTION IS CALLED TO THE ZONING REQUIREMENTS IN THE PHILADELPHIA CODE AS AMENDED. PROPERTY ZONED AS "RSD-3" RESIDENTIAL SINGLE-FAMILY, DETACHED-3, PARCEL #6625 LINCOLN DR. BUILDING SETBACK LINES PER ZONING CODE SHOWN HEREON. ALL DIMENSIONS SHOWN ON THE PLAN ARE PHILADELPHIA DISTRICT STANDARD, THE LEGAL STANDARD OF MEASURE WITHIN THE CITY OF PHILADELPHIA. PHILADELPHIA DISTRICT STANDARD DISTANCES TO BE USED FOR TITLE PURPOSES ONLY. THIS SURVEY WAS PREPARED WITHOUT THE BENEFIT OF A TITLE INSURANCE REPORT AND IS SUBJECT TO THE FINDINGS THAT A VALID TITLE REPORT WOULD DISCLOSE. SUBJECT PREMISES ARE NOT IN A FLOOD HAZARD AREA AS PER FEDERAL EMERGENCY MANAGEMENT AGENCY FLOOD INSURANCE. REGISTERED OWNER(S): 6625 LINCOLN DR. LLC. THE ADDRESSES SHOWN ON THIS PLAN ARE AS PER EXISTING DEEDS OR AS POSTED ON THE PREMISES. ADDRESSES FOR ANY NEWLY CREATED PARCELS ARE TO BE ASSIGNED BY THE OFFICE OF PROPERTY UPON THE FILING AND RECORDING OF A DEED WITH THE DEPARTMENT OF RECORDS OF THE CITY OF PHILADELPHIA. PREPARED IN ACCORDANCE WITH THIS PLAN. THE LINE SHOWN AS PROPOSED SHALL BECOME ACTUAL AND DECLARED. 12. A ZONING PERMIT IS REQUIRED FOR ANY PROPOSED CHANGES TO THE LOT LINES INCLUDING CONSOLIDATION OF EXISTING PARCELS. 13. PREMISE SHOWN HEREON HAS STREET FRONTAGE. 14. UTILITY NOTES: THE LOCATION OF UNDERGROUND UTILITIES IS TAKEN FROM PUBLIC RECORDS AND FIELD LOCATIONS OF VENTS, VALVES, MANHOLES, INLETS, ETC. THE EXTENT, EXACT LOCATION AND DEPTH OF UNDERGROUND HAS NOT BEEN INDEPENDENTLY VERIFIED BY THE OWNER OR ITS REPRESENTATIVE. CONTRACTOR SHALL DETERMINE THE EXTENT, EXACT LOCATION AND DEPTH OF ALL EXISTING UTILITIES

CONTRACTOR SHALL NOTIFY UTILITY COMPANIES THREE (3) DAYS PRIOR TO COMMENCING WORK TO COMPLY WITH PENNSYLVANIA ACT NO. 287.

THE CONTRACTOR AGREES TO BE FULLY RESPONSIBLE FOR ANY AND ALL DAMAGES WHICH MIGHT RESULT BY THE CONTRACTORS FAILURE TO EXACTLY LOCATE AND PRESERVE ANY AND ALL

- 15. ELEVATIONS SHOWN ON PLAN ARE FROM PHILADELPHIA CITY PLAN NO. 311. PROJECT BENCHMARK: MANHOLE RIM, IN LINCOLN DRIVE APPROXIMATELY 15.8FT FROM THE NE CURB LINE, AND APPROXIMATELY 16.7FT FROM THE NORTHWESTERLY MOST PROPERTY CORNER ELEVATION = 220.977, AS SHOWN HEREON.
- 16. CURB ELEVATIONS AND GRADES ARE FROM PHILADELPHIA CITY PLAN NO. 311.

PRIOR TO COMMENCING WORK.

UNDERGROUND UTILITIES.

- THE INFORMATION SHOWN ON THIS PLAN IS FOR THE ULTIMATE USER NAMED HEREON AND IS NOT VALID TO ANY OTHER PARTIES.
- ANY ELECTRONIC REPRODUCTION OF THIS SURVEY AND PLAN IS TO BE FOR THE USE OF THE CLIENT ONLY. AGUA ECONOMICS & ENGINEERING LLC IS NOT RESPONSIBLE FOR ANY DISCREPANCIES, WHICH MAY ARISE BY THE ELECTRONIC REPRODUCTION OF THE ORIGINAL FILE AND ANY FUTURE PARTIES UTILIZING SAID COPY DO HEREBY RELEASE AQUA ECONOMICS & ENGINEERING LLC FROM ANY AND ALL
- COPYRIGHT 2018 ALL RIGHTS RESERVED AQUA ECONOMICS & ENGINEERING LLC. NO PART OF THIS PLAN MAY BE REPRODUCED. STORED IN AN INFORMATION STORAGE AND. RETRIEVAL SYSTEM, OR TRANSMITTED IN ANY FORM, OR BY ANY MEANS, ELECTRICAL, MECHANICAL, PHOTOCOPYING RECORDING OR OTHERWISE WITHOUT PRIOR PERMISSION OF AQUA ECONOMICS & ENGINEERING LLC.

#### PROJECT SITE: 6625 LINCOLN DRIVE

DEVELOPMENT TYPE: "RE-DEVELOPMENT"

- WATERSHED: "WISSAHICKON"
- . COLLECTION SYSTEM: "SEPARATE"
- FLOOD MANAGEMENT DISTRICT: "A"
- IMPERVIOUS COVERAGE CATEGORY: "5"


#### PROJECT OWNER:

6625 LINCOLN DR, LLC. 1218 GREEN STREET PHILADELPHIA, PA 19123

CONTACT: AARON SITBON PHONE: (215) 740-2229 EMAIL: ORON567@GMAIL.COM

#### **EXISTING ADDRESS & PARCEL INFORMATION**

PARCEL	OPA#	TOTAL AREA (SQ. FT.)	TOTAL AREA
6625 LINCOLN DR.	223266900	52,498.6	1.20520

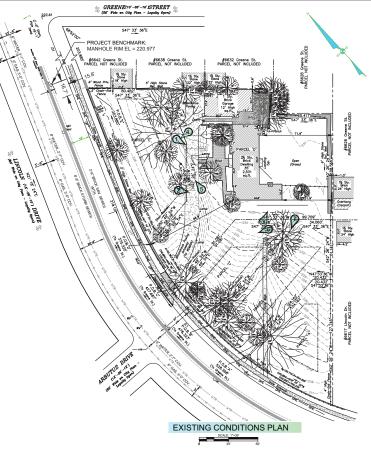

#### EXISTING SITE COVER

COVER TYPE	TOTAL AREA (SQ. FT.)
IMPERVIOUS (BUILDING)	3,830
IMPERVIOUS (SURFACE)	7,225
PERVIOUS (LANDSCAPE)	41,444

_			
3			
2			
1	11/01/2018	ADDRESSING CR01-FY19-LINC-5251-01	JAS
Ma	Date	Davisias	DV

#### SITE LOCATION MAP LEGEND P.O.B. POINT OF BEGINNING OR BOLLARD ٥s SIGN $\circ_{\mathsf{TS}}$ TRAFFIC SIGN -<del>Ф</del>-Hyd FIRE HYDRANT $\circ_{\mathsf{GV}}$ GAS VALVE Owv WATER VALVE osv SEWER VALVE OUP UTILITY POLE $\circ_{\mathsf{MH}}$ MAN HOLE Овтмн BELL TELEPHONE MAN HOLE O PECOMH PECO MAN HOLE GRASS





EXISTING MINOR CONTOUR

EXISTING MAJOR CONTOUR

EXISTING GAS LINE

- - - - FXISTING STORM SEWER

- EXISTING WATER LINE

EXISTING BUILDING

EXISTING FENCE

TRAFFIC DIRECTION ARROW

PHOTOGRAPH LOCATION

- DHE - EXISTING OVERHEAD ELECTRIC EXISTING SANITARY SEWER

---- ZONING SET BACK LINE



PWD TRACKING #: FY19-LINC-5251-01

SHANE MCALEER

## **EXISTING CONDITIONS PLAN**


6625 LINCOLN DRIVE





BLUE BELL, PA 19422 (267) 885-9875 SHANE@AOUAECONOMICS.COM


1" = 30' 03/07/19 PL 6625 LINCOLN DR. (SUBDIV.)


Sheet 1 of 8

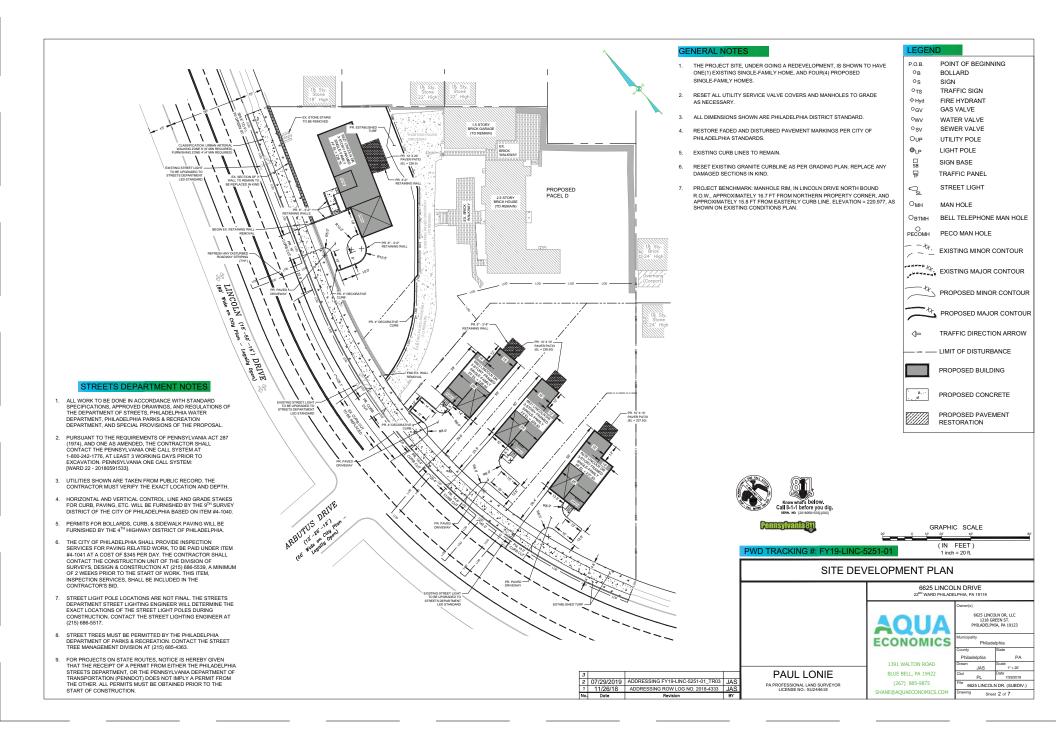


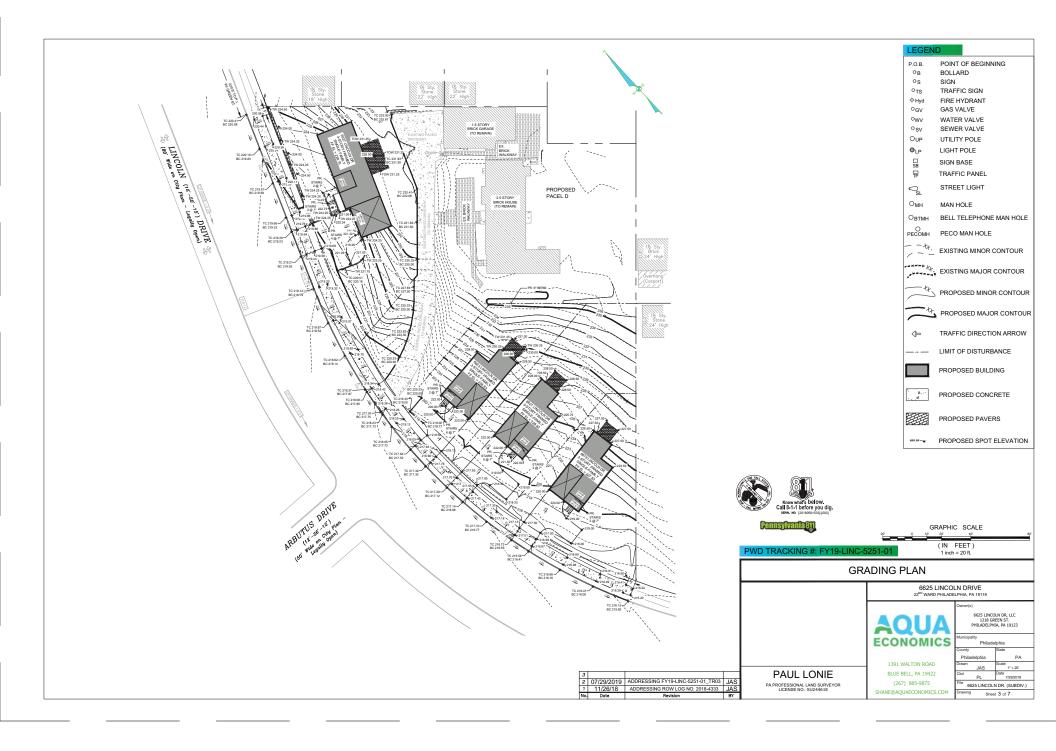


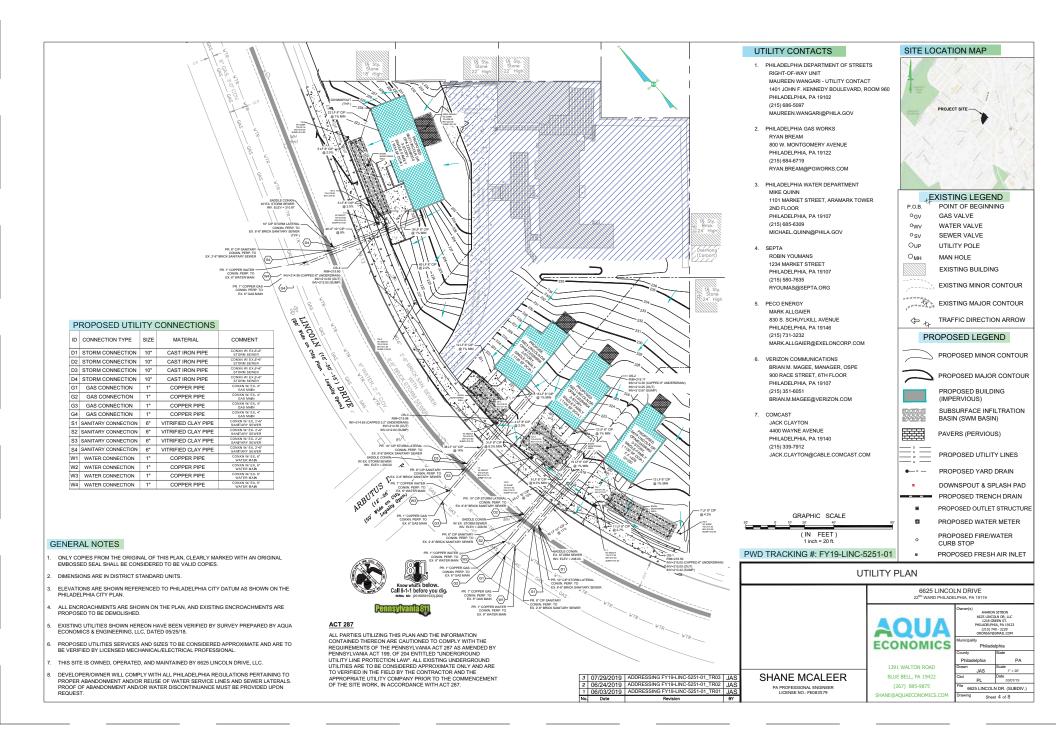

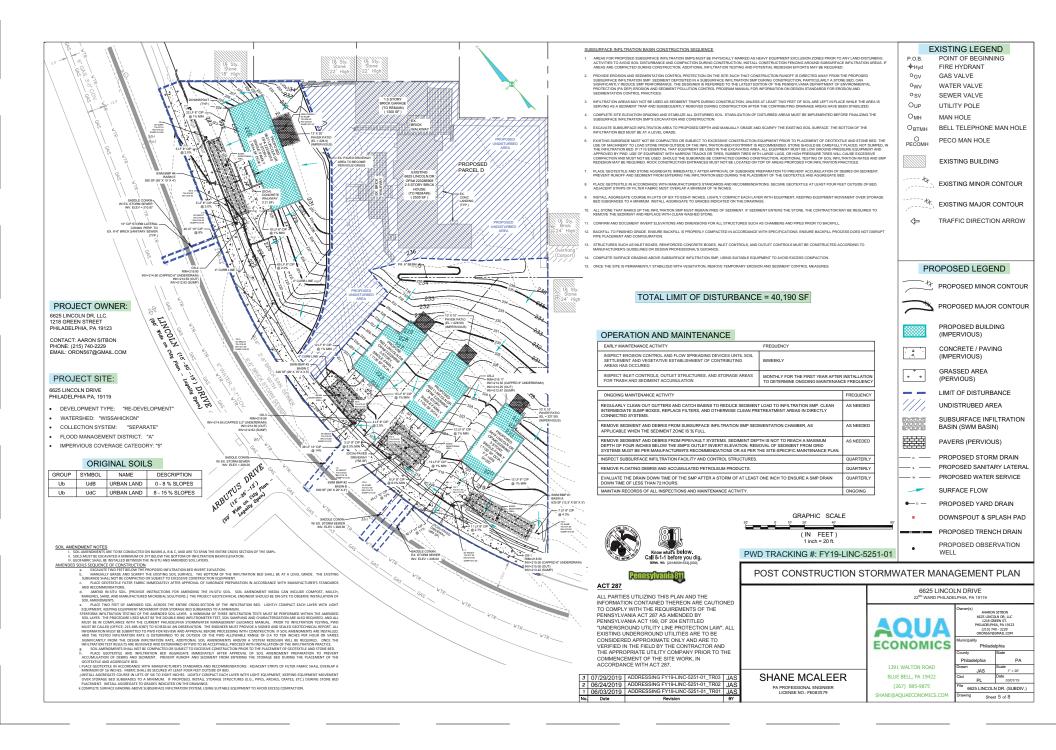

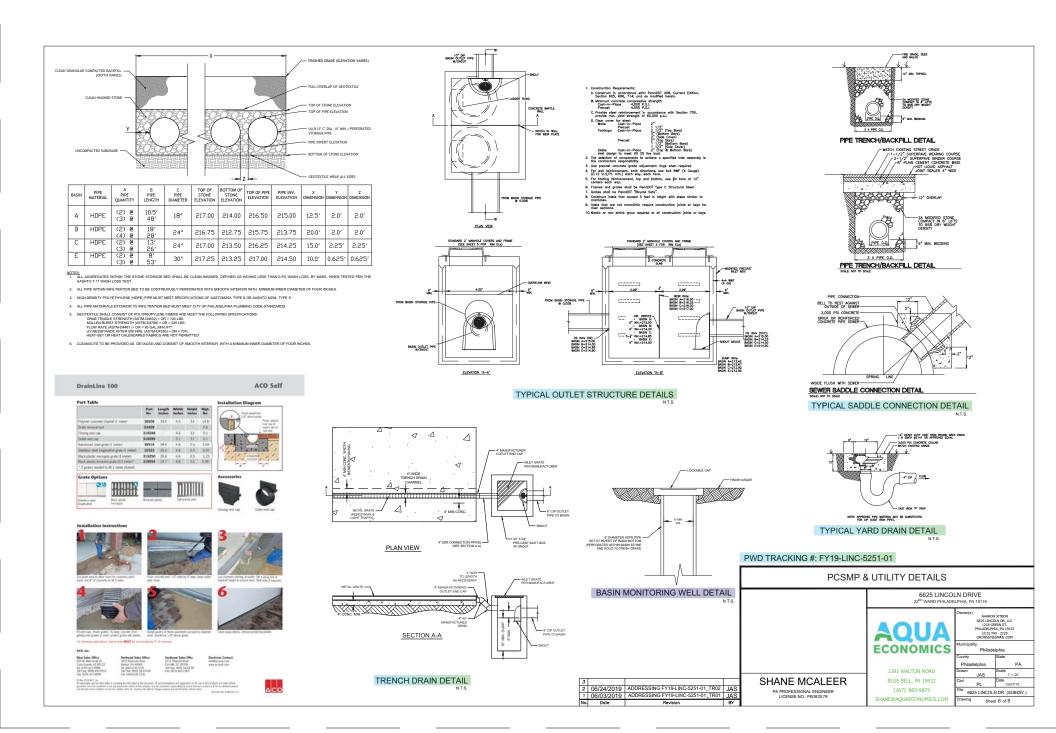

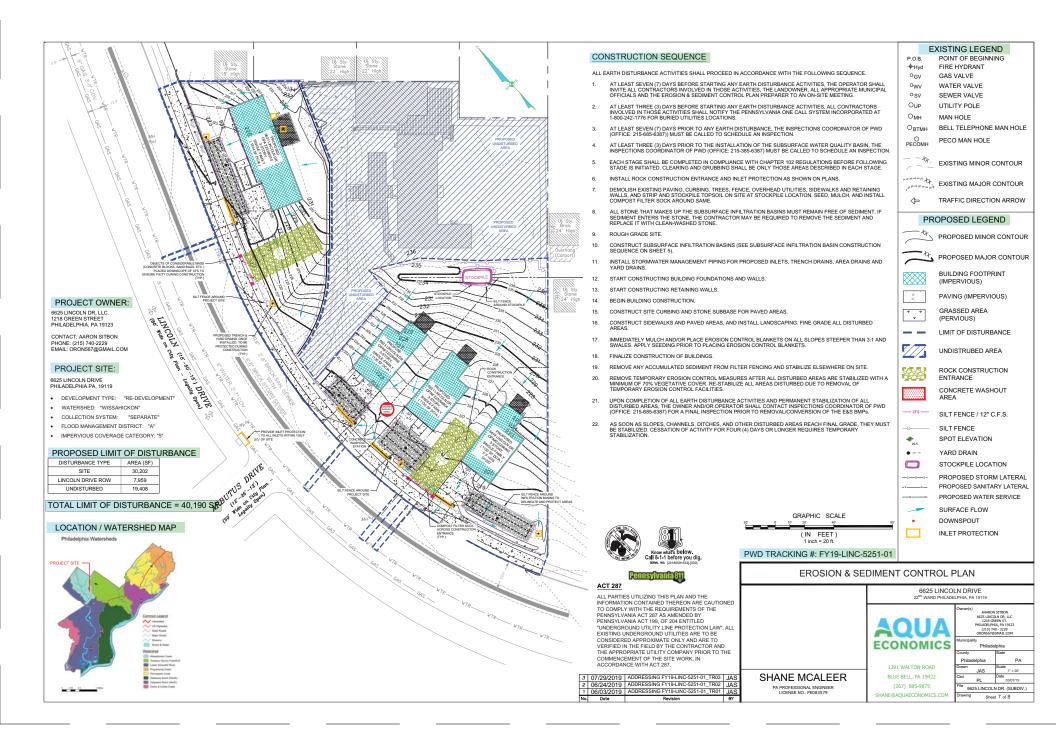

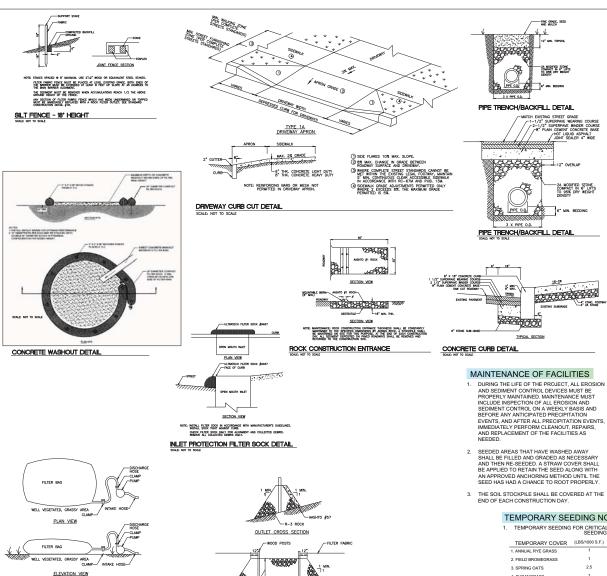

3' MIN.

UP-SLOPE FACE

NOTE: SEDIMENT MUST BE REMOVED WHEN ACCUMULATIONS REACH 1/3 THE HEIGHT OF HTE OUTLET.

ROCK FILTER OUTLET

NOTE: NON-WOVEN GEOTEXTILE FILTER BAG WHICH RETAINS ALL SEDIMENT PARTICLES LARGER THAN 150 MICRONS.

PUMPED WATER FILTER BAG

FILTER BAGS SHALL BE REPLACED WHEN THEY BECOME 1/2 FULL. SPARE BAGS SHALL BE KEPT AS REPLACEMENTS.

BAGS SHALL BE LOCATED IN WELL VEGETATED GRASSY AREAS AND DISCHARGE ONTO STABLE EROSION RESISTANT AREAS, BAGS SHALL NOT BE PLACED ON AREAS GREATER THAN 5% SLOPE.

#### **EROSION & SEDIMENT CONTROL NOTES**

- AN INDUSTRIAL WASTE PERMIT WILL BE REQUIRED SHOULD PUMPING TO CITY-OWNED INFRASTRUCTURE BECOME NECESSARY DURING CONSTRUCTION. ALL PUMPING OF WATER FROM ANY WORK AREA SHALL BE DONE ACCORDING TO THE PROCEDURE DESCRIBED IN THIS PLAN, OVER UNDISTURBED VEGETATED
- INLET PROTECTION SHOULD BE PROVIDED FOR ALL INLETS OWNED BY PWD THAT ARE LOCATED WITHIN ONE BLOCK OF THE PROJECT SITE.
- 3. PWD IS NOT RESPONSIBLE FOR ANY CLEANING OR REPAIRS NEEDED ON CITY-OWNED INFRASTRUCTURE DUE TO FAILURE OF ANY EROSION AND SEDIMENT CONTROL PRACTICES. 8625 LINCOLN DR. LLC TO BE RESPONSIBLE FOR CLEANING AND REPAIRING OF CITY-OWNED INFRASTRUCTURE DUE TO FAILURE OF EROSION AND SEDIMENT CONTROL PRACTICES.
- INSPECTION AND MAINTENANCE OF ALL EROSION AND SEDIMENT CONTROL BEST MANAGEMENT PRACTICES SHALL COCCUR ON A WEEKLY BASIS, BEFORE AN ANTICIPATED PRECIPITATION EVENTS, AND AFTER ALL PRECIPITATION EVENTS.
- THE MAXIMUM HEIGHT FOR STOCKPILE AREAS SHALL BE 20 FEET. THE MAXIMUM SIDE SLOPE FOR STOCKPILE AREAS SHALL NOT EXCEED 2:
- THE ROCK CONSTRUCTION ENTRANCE THICKNESS SHALL BE CONSTANTLY MARTARED ON-SITE AS TOCKNESS SHALL BE LIMBITARED ON SITE FOR THE ON THE OWN FOR THE OWN THE OWN FROM THE OWN THE
- ANY FENCE SECTION WHICH HAS BEEN UNDERMINED OR TOPPED MUST BE IMMEDIATELY REPLACED WITH A ROCK FILTER OUTLET. SEDIMENT MUST BE REMOVED WHEN ACCUMULATIONS REACH \$ THE HEIGHT OF THE OUTLET.
- EROSION CONTROL BLANKETING SHALL BE INSTALLED ON ALL SLOPES 3H:1V OR STEEPER WITHIN 50 FEET OF A SURFACE WATER AND ON ALL OTHER DISTURBED AREAS SPECIFIED ON THE PLAN MAPS AND/OR DETAIL SHEETS
- IMMEDIATELY UPON DISCOVERING UNFORESEEN CIRCUMSTANCES POSING THE POTENTIAL FOR ACCELERATED EROSION AND/OR SEDIMENT POLLUTION, THE DPERATOR SHALL IMPLEMENT APPROPRIATE BEST MANAGEMENT PRACTICES TO MINIMIZE THE POTENTIAL FOR EROSION AND SEDIMENT POLLUTION AND NOTIFY
- 11 LINTH THE SITE IS STARILIZED ALL ESS RMDs SHALL BE MAINTAINED DEODEDLY UNTIL THE SITE IS STABLIZED, ALL EAS BMPS SHALL BE MAINTAINED PROPERLY.

  MANTENANCE SHALL INCLUDE INSPECTIONS OF ALL EAS BMPS PRIOR TO ANY
  ANTICIPATED STORM EVENT, AFTER EACH RUNOFF EVENT AND ON A WEEKLY
  BASIS. ALL PREVENTATIVE AND REMEDIAL MAINTENANCE WORK, INCLUDING
  CLEAN OUT, REPAIR, REPLACEMENT, REGARDING RESEEDING, REMULCHING,
  AND RENETTING, MUST BE PERFORMED IMMEDIATELY. IF THE EAS BMPS FALL TO PERFORM AS EXPECTED, REPLACEMENT BMPs, OR MODIFICATIONS OF THOSE INSTALLED, WILL BE REQUIRED.
- 12. ALL EARTH DETURBANCES, INCLUDING CLEARING, AND GRUBBING, AS WELL AS CUTS AND FILES SHALL BEE DONE IN ACCORDANCE WITH THE APPROVED ESS PLAN. A COPY OF THE APPROVED DRAWINGS MUST BE AVAILABLE AT THE PROJECT SHE" AT ALL TIMES PUR SHALL BEEN PIECE OF ANY CHANGES TO THE PROJECT SHE TALL TIMES PUR SHALL BEEN PIECE OF ANY CHANGES TO REQUIRE A WRITTEN SUBMITTAL OF THOSE CHANGES FOR REVIEW AND APPROVAL AT TIS DISCRETION.
- 13. AT LEAST THREE (3) DAYS PRIOR TO STARTING ANY EARTH DISTURBANCE ACTIVITIES, OR EXPANDING INTO AN AREA PREVIOUSLY UNMARKED, THE PENNSYLVANIA ONE CALL SYSTEM INC. SHALL BE NOTIFIED AT 1-800-242-1776 FOR THE LOCATION OF EMISTING UNDERGROUND UTILITIES.
- AREAS TO BE FILLED ARE TO BE CLEARED, GRUBBED, AND STRIPPED OF TOPSOIL TO REMOVE TREES, VEGETATION, ROOTS, AND OTHER OBJECTIONABLE MATERIAL.
- 16. CLEARING, CRIBBING, MID TOPOCIL STEPPING SIML, BE LIMITED TO THREE MARKS DESCRIBED IN BOLD STADE OF THE CONSTRUCTION SOCIETY. CERTAIN, GRUBBING AND TOPOCIL STEPPING MAY NOT COMMENCE IN MY STAGE OF THE PROJECT UNIT THE EAS BMYS SECPLED BY THE BMY SEQUENCE FOR THAT STAGE HAVE BEEN INSTALLED AND ARE PUNCTIONAGE AS DESCRIBED IN THIS EAS PLAN.
- 17. AT NO TIME SHALL CONSTRUCTION VEHICLES BE ALLOWED TO ENTER AREAS OUTSIDE THE LIMIT OF DISTURBANCE BOUNDARIES SHOWN ON THE PLAN MAPS. THESE AREAS MUST BE CLEARLY MARKED AND FENCED OFF BEFORE CLEARING AND GRUBBING OPERATIONS BEGIN.
- A LOG SHOWING DATES THAT EAS BMPS WERE INSPECTED AS WELL AS ANY DEFICIENCIES FOUND AND THE DATE THEY WERE CORRECTED SHALL BE MAINTAINED ON THE SITE AND BE MADE AVAILABLE TO PWD AT THE TIME OF INSPECTION.
- ALL SEDIMENT REMOVED FROM BMPS SHALL BE DISPOSED OF IN THE FOLLOWING MANNER: SEDIMENT BUILDUP TO BE REDISTRIBUTED WITHIN THE SITE LIMITS.

- AREAS WHICH ARE TO BE TOPSOILED SHALL BE SACRIFIED TO A MINIMUM DEPTH OF THREE TO FIVE INCHES - SIX TO 12 INCHES ON COMPACED SOILS - PRIOR TO PLACEMENT OF TOPSOIL. AREAS TO BE VEGETATED SHALL HAVE A MINIMUM FOUR INCHES OF TOPSOIL IN PLACE PRIOR TO SEEDING AND MULCHING, FILL OUTSLOPES SHALL HAVE A MINIMUM OF TWO INCHES OF TOPSOIL
- ALL FILLS SHALL BE COMPACTED AS REQUIRED TO REDUCE EROSION, SLIPPAGE, SETTLEMENT, SUBSIDENCE, OR OTHER RELATED PROBLEMS, FILL INTENDED TO SUPPORT BUILDINGS, STRUCTURES, AND CONDUITS, ETC. SHALL BE COMPACTED IN ACCORDANCE WITH LOCAL REQUIREMENTS OR CODES.
- 23. FILL MATERIALS SHALL BE FREE OF FROZEN PARTICLES, BRUSH, ROOTS, SOD, OR OTHER FOREIGN OR OBJECTIONABLE MATERIALS THAT WOULD INTERFERE WITH OR PREVENT CONSTRUCTION OF SATISFACTORY FILLS.
- FROZEN MATERIALS OR SOFT, MUCKY, OR HIGHLY COMPRESSIBLE MATERIALS SHALL NOT BE INCORPORATED INTO FILLS.
- 26. SEEPS OR SPRINGS ENCOUNTERED DURING CONSTRUCTION SHALL BE HANDLED IN ACCORDANCE WITH THE STANDARD AND SPECIFICATION FOR SUBSURFACE DRAIN OR OTHER APPROVED METHOD.
- ALL GRADED AREAS SHALL BE PERMANENTLY STABILIZED IMMEDIATELY UPON REACHING FINISHED GRADE.
- IMMEDIATELY STREET EARTH DISTURBANCE ACTIVITIES CEASE IN ANY AREA OR SUBMERA OF THE PROJECT. THE OPENATOR SHALL STRABLEZ ALL DISTURBED OF THE PROJECT. THE OPENATOR SHALL STRABLEZ ALL DISTURBED DISTURBED AND ALL STRABLEZ ALL DISTURBED OF THE PLAN AREAS NOT AT FINISHED GRADE, WHICH WILL BE REACTIVATED WITHIN ONE YEAR, MAY BE STRABLEZD IN ACCORDANCE WITH THE TEMPORARY STABLIZATION AND STRABLEZ ALL STRABLEZ ON ACCORDANCE WITH THE PREMAMENT STABLIZATION AND STRABLEZ ON ACCORDANCE WITH THE PERMAMENT STABLIZATION AND STRABLEZ ON ACCORDANCE WITH THE PERMAMENT STABLIZATION SECTION ACCORDANCE WITH THE PERMAMENT STABLIZATION ACCORDANCE WITH THE PERMAMENT ACCORDANCE WITH THE PERMAMENT ACCORDANCE WITH THE PERMAMENT ACCORDANCE WITH THE PERMAM
- PERMANENT STABILIZATION IS DEFINED AS A MINIMUM UNIFORM, PERENNIAL 70% VEGETATIVE COVER OR OTHER PERMANENT NON-VEGETATIVE COVER WITH A DENSITY SUFFICIENT TO RESIST ACCELERATED EROSION. CUT AND FILL SLOPES SHALL BE CAPABLE OF RESISTING FAILURE DUE TO SLUMPING, SLIDING, OR
- E&S BMPS SHALL REMAIN FUNCTIONAL AS SUCH UNTIL ALL AREAS TRIBUTARY TO THEM ARE PERMANENTLY STABILIZED OR UNTIL THEY ARE REPLACED BY ANOTHER BMP APPROVED BY PWD AND PA DEP
- AFTER FINAL SITE STABILIZATION HAS BEEN ACHIEVED, TEMPORARY EAS BMPS MUST BE REBIONED OR CONVESTED TO PERMANENT POST-CONSTRUCTION OF CONVESTED OF THE EAS BMS SHALL BE STRABLED MIMEDIATED HONORING OR CONVESTED OF THE EAS BMS SHALL BE STRABLED MIMEDIATED HONORING FOR CONVESTED AFTER THE POST SHALL BE STRABLED MIMEDIATED HONORING PROPERTY OF DESIGNATION AFTER THE DONE ONLY DURING THE GERMANICHOM SHALL BE SHALL BE STABILD THE STRABLED HONORING THE SERMINATION ARE TO BE DONE ONLY DURING THE SERMINATION ASSET THE STABILD THE STRABLED HONORING THE SERVICE OF THE STABILD THE STABILD THE STABILD THE STRABLED HONORING THE STABILD TH
- 32. DURING CONSTRUCTION. THE SELECTED CONTRACTOR IS EXPECTED TO FOLLOW THE PCSMP APPROVED BY PWD. NO CHANGE OR DEVIATION FROM THE APPROVED PCSMP IS PERMITTED WITHOUT PRIOR APPROVAL FROM PWD.
- WORK ASSOCIATED WITH PWD WATER CONVEYANCE AND SEWER INFRASTRUCTURE SHALL BE DONE IN ACCORDANCE WITH THE CITY OF PHILADELPHIA WATER DEPARTMENT "WATER MAIN STANDARD DETAILS AND CORROSION CONTROL SPECIFICATIONS", 1985 EDITION, AND "STANDARD SPECIFICATIONS FOR SEWERS", 1985 EDITION
- CONTACT PWD WATER TRANSPORT RECORDS (1101 MARKET STREET, 2ND FLOOR, PHONE: 215-885-8271) FOR ADDITIONAL APPROVALS AND PERMITS REQUIRED FOR ALL WATER SERVICES, METERS AND CONNECTIONS TO EXISTING AND/OR PROPOSED PWD FACILITIES.
- ALL BUILDING MATERIALS AND WASTES SHALL BE REMOVED FROM THE SITE AND RECYCLED AND OR DISPOSED OF IN ACCORDANCE WITH THE PADEPS SOLID WASTE MANAGEMENT REGULATIONS AT 29 PA CODE 280.1 ET SED., 27.1.1, AND 287.1 ET SED. NO BUILDING MATERIALS OR WASTES OR UNUSED BUILDING MATERIALS HALL BE BURNED, BURNED, DUMPED, OR DISCHARGED AT THE SITE.





6625 LINCOLN DRIVE

#### TEMPORARY SEEDING NOTES

TEMPORARY SEEDING FOR CRITICAL AREAS: SEEDING RATE

2A MODIFIED STONE COMPACT IN 6" LIFTS TO 95% DRY WEIGHT

RECOMMENDED TEMPORARY COVER (LBS/1000 S.F.) (LBS/ACRE) SEEDING DATES 20 TO 40 MAR 1 TO IUNE 15 20 TO 40 AUG. 15 TO SEP. 15 2.5 MAR. 1 TO JUNE 1 30 TO 40 MAY 15 TO AUG. 15 4. SUDANGRASS 3.5 AUG. 15 TO OCT. 15 5. WINTER RYE 6. ANNUAL RYE GRASS (25%) MAR. 1 TO JUNE 15 SPRING OATS (75%)

NOTE: PENNDOT FORMULAE 'E' MAY BE SUBSTITUTED FOR TEMPORARY SEEDING, ALL WORK, INCLUDING MAINTENANCE, WILL BE IN ACCORDANCE WITH SECTING 884 OF THE STANDARD SPECIFICATION. FIELD BROMEGRASS AND SUDANGRASS NOT RECOMMENDED FOR POORLY DRAINED STAN.

2 06/24/2019 ADDRESSING FY19-LINC-5251-01\_TR02 JAS 1 06/03/2019 ADDRESSING FY19-LINC-5251-01 TR01 .IAS

#### PWD TRACKING #: FY19-LINC-5251-01

#### **EROSION & SEDIMENT CONTROL - DETIALS & NOTES**

**ECONOMICS** 

1391 WALTON ROAD BLUE BELL, PA 19422 (267) 885-9875

PA JAS 1" = 20" PL 03/07/19 6625 LINCOLN DR. (SUBDIV.) Sheet 8 of 8

SHANE MCALEER

SHANE@AOUAECONOMICS.COM