ADDRESS: 260 S 20TH ST

Proposal: Demolish rear ell; construct three-story rear addition

Review Requested: Final Approval Owner: Su Bin Jian and Bo Meng Lin

Applicant: Chwen-Ping Wang and Yao-Chang Huang, Sky Design Studio

History: 1860

Individual Designation: None

District Designation: Rittenhouse Fitler Historic District, Contributing, 2/8/1995 Staff Contact: Allyson Mehley, allyson.mehley@phila.gov, 215-686-7660

BACKGROUND:

The application proposes to demolish the rear wall of the main block and three-story rear ell and replace it with a three-story addition. The addition is proposed to cover the width of the property. Historic maps show that the 1860 building originally had a one-story rear wing (see Figure 1). The existing rear ell was added between 1860 and 1895 (see Figure 2).

This application was originally reviewed by the Architectural Committee (8/27/2019) and Historical Commission (9/13/2019) earlier in 2019. The Historical Commission voted to deny the application due to its incompleteness. The Commission's findings and conclusions were as follows:

The Historical Commission found that:

- The rear ell is not visible from any public right-of-way.
- Historic rear ells can be character-defining features of buildings, even if not visible from the street.
- The proposed scope includes removing the entire rear wall of the main block. It was noted by the Commission that the removal of the full rear wall of the building constitutes a demolition. Because of the lack of the detailed information in the application, the Commission could not determine if the proposed scope of work constituted an alteration or demolition.
- The new addition will be wider than original ell and will cover entire rear of building and extend rear property line.
- The application is not complete. The drawings and photographs do not communicate fully what currently exists, current conditions, what is being removed, and what the new construction would look like.
- The application requires additional information to fully evaluate the proposed scope
 of work. Existing condition drawings (elevations and plans) and existing condition
 photographs should be submitted for review. The Commission must be able to
 understand what currently exists on the rear ell including information such as window
 and door openings and overall condition. More fully developed drawings of the new
 addition should be submitted as well.

The Historical Commission concluded that:

- The application does not provide enough information to fully assess whether the proposed scope of work does or does not comply with the Standards.
- The staff should visit the site and document the rear of the building.
- The application should be revised to provide explicitly the current state of the rear of the building and the proposal for it.

The staff visited the property on 2 October 2019 and verified that rear of property is not visible from the street. The staff observed that the rear ell has been altered several times including the construction of a one-story addition and changes to window openings. During a walk through of the interior space, the rear ell exhibited sloping floorboards and other signs that the ell has shifted owing to an insufficient foundation.

To address the concerns of the Architectural Committee and Historical Commission raised during the earlier review, the applicant has submitted additional drawings, photographs, and an assessment letter from a structural engineer.

SCOPE OF WORK

- Demolish existing three-story rear ell.
- Demolish rear wall of main block.
- Construct new three-story addition with rear roof deck on second floor and rear balcony on third floor. Addition will cover the full width of rear property. Addition will have crawlspace rather than a full basement.
- Clad new rear wall with brick.
- Interior renovations within main block; no work to front facade.

STANDARDS FOR REVIEW:

The Secretary of the Interior's Standards for the Treatment of Historic Properties and Guidelines include:

- Standard 2: The historic character of a property will be retained and preserved. The removal of distinctive materials or alteration of features, spaces and spatial relationships that characterize a property will be avoided.
 - o Although the demolition of the rear ell will result in the removal of materials and the alteration of features, spaces, and spatial relationships, none of this area is visible from the public-right of way. Only the front facade facing S. 20th Street is visible from the public right-of-way and no changes are proposed for the front façade. Although the general form of the late nineteenth-century ell still exists, it has been altered many times. Moreover, the rear ell appears to have been poorly constructed and is in poor condition. Also, the adjacent building no longer has an ell and was built out to the property line at an earlier date. Although historic fabric will be removed, the building's visible historic character will not change to pedestrians walking through the Rittenhouse Fitler Historic District.
- Standard 9: New additions, exterior alterations, or related new construction shall not
 destroy historic materials that characterize the property. The new work shall be
 differentiated from the old and shall be compatible with the massing, size, scale, and
 architectural features to protect the historic integrity of the property and its environment.
 - The historic rear ell is shifting and is structurally compromising the overall building due to the lack of a foundation and a crack in the rear wall. The addition will be the same height as the historic ell and the rear wall will be clad in brick. The adjacent property is already built out to the property line and the proposed new addition will cover the full width of the rear property and be built against this party wall (Figure 5).

STAFF RECOMMENDATION: Approval, with the staff to review details, pursuant to Standards 2 and 9.

Historic Maps

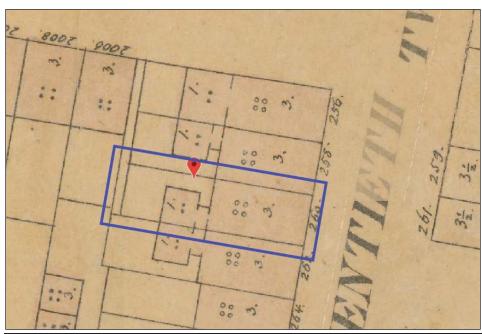


Figure 1: 1858-60 Philadelphia Atlas, Hexamer & Locher

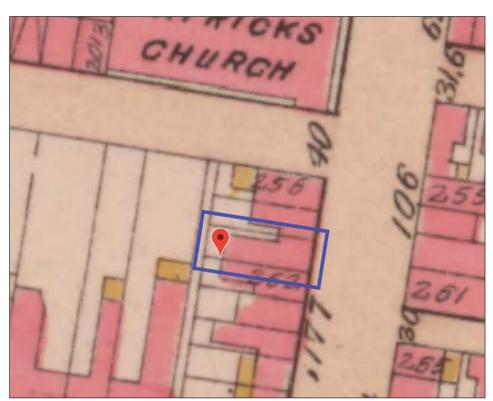


Figure 2: 1895 Philadelphia Atlas, G. W. Bromley

Images



Figure 3 (above): Gate in front of alley that leads to rear of 260 S 20th Street.

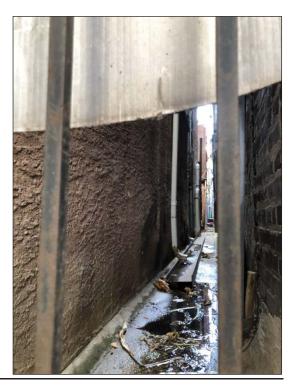


Figure 4 (above): View through gate. Rear of property and ell is not visible.



Figure 5 (at right): View from rear alley behind 260 S 20th back out to street. The wall visible on the right side of photograph is the south wall of the adjacent building. This would become a party wall to the proposed addition.

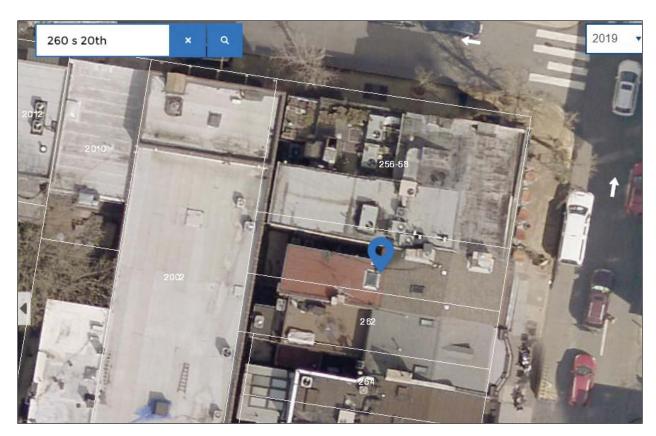


Figure 6: 2019 aerial view of 260 S 20th Street.



Project Address: 260 S 20th Street, Philadelphia, PA

Property Owner: Su Bin Jian; Bo Meng Lin 2425 S Hancock St. Philadelphia, PA

The owner would like to apply for Final Approval for the following changes. We are proposing the following:

- A (3) story rear addition for the use of (1) nail salon on 1st floor/cellar, One Apartment on 2nd floor w/ rear roof deck and (1) one apartment on 3rd floor w/ rear balcony.
- 2. The new (3) story addition will have a length of 30'-11 1/4" X 16'-7" width, 29'-3" Height and 2'-6" rear setback.
- 3. Scope of Work:
- -Existing front façade to remain.
- -Remove existing (1) One Story rear portion and full demolition of (3) Three-story rear ell and back wall of main block. To replace with (3) Three Story addition with rear roof deck on 2nd floor and rear 3rd floor balcony.
- -New interior renovations on the existing (3) story front portion of building.

Additional comments on drawings:

- 1. Site visit has been carried out with personnel from Historical Department.
- 2. Photos of the current condition of the "L" is included on sheet A0.1
- 3. We added 2 section drawings to depict the "L" in its current condition and proposed design. The section drawings also show the rear wall of the main bulk are to be demolished.

Shall you have any questions, please do not hesitate to contact me.

Sincerely,

KANN

Yao-Chang Huang, AIA

APPLICATION FOR BUILDING PERMIT

APPLICATION # ______

CITY OF PHILADELPHIA DEPARTMENT OF LICENSES AND INSPECTIONS MUNICIPAL SERVICES BUILDING – CONCOURSE 1401 JOHN F. KENNEDY BOULEVARD PHILADELPHIA, PA 19102

For more information visit us at www.phila.gov/li

(Please complete all information below and print clearly)

ADDRESS OF PROPOSED CONSTRUCTION:		
260 S 20th Street Philadelphia, PA 19103		
APPLICANT:	APPLICANT'S ADDRESS:	
CHWEN-PING WANG AC#2361933	1823 SPRING GARDEN ST	
COMPANY NAME SKY DESIGN	PHILADELPHIA PA 19130	
PHONE# (610) 896-3649 FAX #		SKY@SKY-DS.COM
PROPERTY OWNER'S NAME: Jiang Su Bin, Lin Bo Meng	PROPERTY OWNER'S ADDRESS: _2524 S Handcock Street, Philadelphia PA	19148
PHONE # (610) 896-3649		
ARCHITECT/ENGINEER IN RESPONSIBLE CHARGE YAO CHANG HUANG AC#2361933	ARCHITECT/ENGINEERING FIRM AI 1823 SPRING GARDEN ST	DDRESS:
ARCHITECT/ENGINEERING FIRM:	PHILADELPHIA, PA 19130	
SKY DESIGN STUDIO PC		
PHONE # (610) 896-3649	LICENSE # 802513 E-MAIL:	SKY@SKY-DS.COM
CONTRACTOR:	CONTRACTING COMPANY ADDRES	SS:
	. —————	
CONTRACTING COMPANY:		
PHONE # FAX #	LICENSE # E-MAIL:	
USE OF BUILDING/SPACE		ESTIMATED COST OF WORK
1 Vacant Commerical & 2-Family Reside	ential	\$
BRIEF DESCRIPTION OF WORK:		
TO REMOVE AND REPLACE:		
REAR 1-STORY ADDITION WITH ROOD DECK AT 2ND FLOOR LEVEL		
FULL DEMOLITION OF 3-STORY REAR ELL AND BACK WALL OF MAIN BLOCK		
TO CONSTRUCT :		
3-STORY ADDITION IN FORMER SIDE YARD/ LIGHT WELL & INTERIOR RENOVATION THROUGHOUT		
FOR THE USE OF:		
CELLAR & 1ST FLOOR FOR VACANT COMMERCIAL		
2ND-3RD FLOOR FOR 2 DWELLING UNITS.		
TOTAL AREA UNDERGOING CON	ISTRUCTION: 3,173.00	s quare feet
COMPLETE THESE ITEMS IF APPLICABLETO THIS APPLICATION:		
# OF NEW SPRINKLER HEADS (suppression system permits only):	LOCATION OF SPRINKL	ERS:
# OF NEW REGISTERS/DIFFUSERS (hvac/ductwork permits only):	LOCATION OF STANDPI	IPES:
IS THIS APPLICATION IN RESPONSE TO A VIOLATION? NO	S VIOLATION #:	
All provisions of the building code and other City ordinances will be complied with, whether specified herein or not. Plans approved by the Department form a part of this application. I hereby certify that the statements contained herein are true and correct to the best of my knowledge and belief. I further certify that I am authorized by the owner to make the foregoing application, and that, before I accept my permit for which this application is made, the owner shall be made aware of all conditions of the permit. I understand that if I knowingly make any false statement herein I am subject to such penalties as may be prescribed by law or ordinance.		
APPLICANT'S SIGNATURE:		DATE:/

JDM Engineering LLC

Structural Engineering Consultants 815 RT 54 Williamstown, NJ 08094 (856) 264-3851

September 3, 2019

RE: 260 S 20th Street Philadelphia PA

To Whom It May Concern,

This report is written to document observations conducted during an inspection of the work associated to evaluate the rear wall at the above referenced location.

The inspection determined that the rear wall was partially cracked and did not have a foundation. As a result, the wall was deemed unsafe requiring replacement with the proposed rear wall.

Please do not hesitate to contact me should you have any questions.

Sincerely,

Miguel Mota, PhD, PE JDM Engineering LLC Williamstown, NJ 08094 PA PE License # PE052118E (Exp 9/30/19) Special Inspector License 050800 Special Inspection Agency 051274 ICC Certified Special Inspector



260 S. 20TH STREET

ZONING CLASSIFICATION: CMX-2 MIXED USE

PROPOSED USE: NAIL SALON ON FIRST

FLOOR WITH EXISTING TWO APARTMENTS ON

FLOORS ABOVE

SCOPE OF WORK: REMOVE AND REPLACE

REAR (1) ONE STORY
ADDITION W/ROOF DECK
@2ND FLOOR LEVEL,
(3) STORY ADDITION (IN
FORMER SIDE YARD/ LIGHT

WELL) & INTERIOR

RENOVATIONS THROUGHOUT

BUILDING CODE: CODE JURISDICTION:

2018 INTERNATIONAL BUILDING CODE

PHILADELPHIA PLUMBING CODE (2004 EDITION)
2017 INTERNATIONAL ELECTRICAL CODE
2018 INTERNATIONAL MECHANICAL CODE

2009 INTERNATIONAL FIRE CODE

2018 INTERNATIONAL ENERGY CONSERV. CODE

ZONING DATA		
CMX-2 ZONING DISTRICT	REQUIRED	PROPOSED
MIN. LOT WIDTH	N/A	16'-7" (EXISTING)
MIN. LOT AREA	N/A	1,119 SF (EXISTING)
OCCUPIED AREA	75% MAX	1077.6 SF (96.3% SF)
OPEN AREA	25% MIN.	41.4 SF (3.7%)
FRONT YARD	NOT REQ'D	0'
SIDE YARD	5' MIN (IF USED)	NONE
REAR YARD DEPTH	9' MIN OR 10% OF DEPTH	2'-6"
HEIGHT	38' MAX	38'-0"
MIN. CORNICE HEIGHT	N/A	29'-3"
MAX. F.A.R.	N/A	366.04% (1,119 / 3,057 S.F.)


STREETS DATA

STREET BREAKDOWN	SIDEWALK	CARTWAY	SIDEWALK	TOTAL
S. 20TH STREET	12'	26'	12'	50'-0"

ENCROACHMENT TYPE	PROPOSED	EXIST.
STAIRS/STEPS	N/A	2'-0" x 4'-7"
WINDOW WELLS	N/A	N/A
CORNICE	N/A	1'-3" x 16'-7"
BAYWINDOWS/BALCONIES	N/A	N/A

BUILDING CALCULATIONS

CELLAR GROSS AREA	978 SF
1ST FLOOR GROSS AREA	1,119 SF
2ND FLOOR GROSS AREA	978 SF
3RD FLOOR GROSS AREA	978 SF
TOTAL BLDG. GROSS AREA	3,075 SF (W/OUT CELLAR)

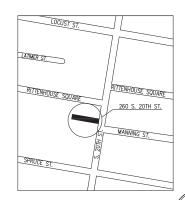

1 LOCATION PLAN
A0 SCALE: N.T.S.

SKY DESIGN STUDIO T 610 898 3549 F 215 827 5370 1823 SPRING GARDEN ST PHILADELPHIA, PA 19130 SKY@SKY-DS.COM

PROJECT ADDRESS

260 S. 20th St. Philadelphia, P.A.

DRAWING TITLE

COVER SHEET

DRAWING NUMBER

#6/283 s 20th still c17 sefoce_280 s 28th st 2016-E-9.3 story 11c17 set dag

T 610 896 3649 F 215 827 5370 1823 SPRING GARDEN PHILADELPHIA PA 19130 SKY@SKY-DS.COM

PROJECT ADDRESS

260 S 20TH ST PHILADELPHIA PA 19103

BUILDING PHOTOS CURRENT CONDITION DRAWING NUMBER

A0.1







LOOKING WEST AT FRONTAGE ON S 20TH ST



LOOKING NORTH IN REAR ALLEY LEADING TO RITTENHOUSE SQUARE ST



IREMAINING 1-STORY ADDITION & IREAR/ SIDE WALLS TO BE DEMOLISHED



LOOKING AT BUILDING REAR FROM REAR ALLEY

REMAINING 1-STORY ADDITION & IREAR WALL ITO BE DEMOLISHED



5 LOOKING AT BUILDING REAR FROM REAR ALLEY

REMAINING 1-STORY ADDITION & REAR WALL ITO BE DEMOLISHED



LOOKING AT BUILDING REAR FROM REAR ALLEY

REMAINING REAR WALL TO BE DEMOLISHED





260 S. 20TH ST. – NO CHANGES ON EXISTING FACADE SKY DESIGN STUDIO
T 610 896 3649
F 215 827 5370
1823 SPRING GARDEN T
PHILADELPHIA, PA 19130
SKY@SKY-DS.COM

PROJECT ADDRESS

260 S. 20th St. Philadelphia, P.A.


DRAWING TITLE

FACADE PHOTO

DRAWING NUMBER

A8 |

1 PHOTO LOOKING WEST A8 N.T.S.

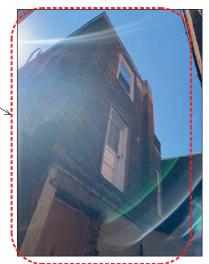

EXISTING ___ REAR WALL TO BE DEMOLISHED



1 LOOKING AT 2ND & 3RD FL. REAR WALL
A9 N.T.S.

2 LOOKING AT GROUD LEVEL REAR WALL
A9 N.T.S.

A9 N.1.S

EXISTING __ REAR WALL TO BE DEMOLISHED

EXISTING
REAR WALL
TO BE DEMOLISHED

3 LOOKING AT GROUND LEVEL A9 N.T.S.

4 LOOKING AT REAR ALLEY
A9 N.T.S.

DRAWING TITLE

F 215 827 5370 F 215 827 5370 1823 SPRING GARDEN ST PHILADELPHIA, PA 19130 SKY@SKY-DS.COM

PROJECT ADDRESS

260 S. 20th St. Philadelphia, P.A.

REAR WALL PHOTOS DRAWING NUMBER



260 S. 20TH ST. -REAR PROPOSED RENOVATION AREA

PHOTO LOOKING TOP SOUTH N.T.S.



260 S. 20TH ST. REAR PROPOSED RENOVATION AREA


1 PHOTO LOOKING TOP EAST A10 N.T.S.


DRAWING TITLE

T 610 896 3649 F 215 827 5370 1823 SPRING GARDEN ST PHILADELPHIA, PA 19130 SKY@SKY-DS.COM —

260 S. 20th St. Philadelphia, P.A.

PHOTOS

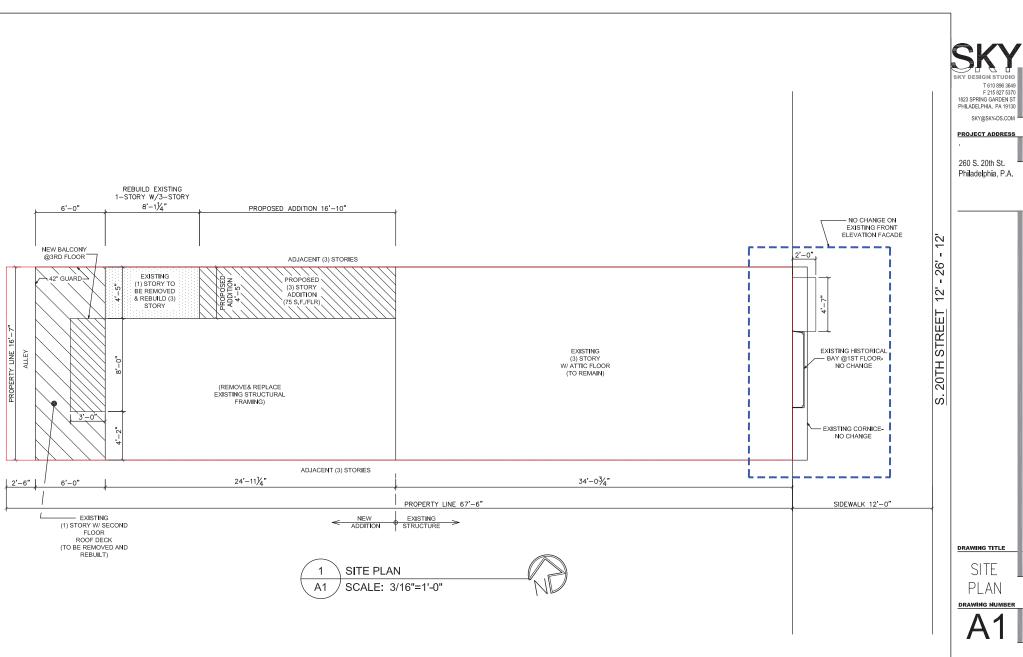

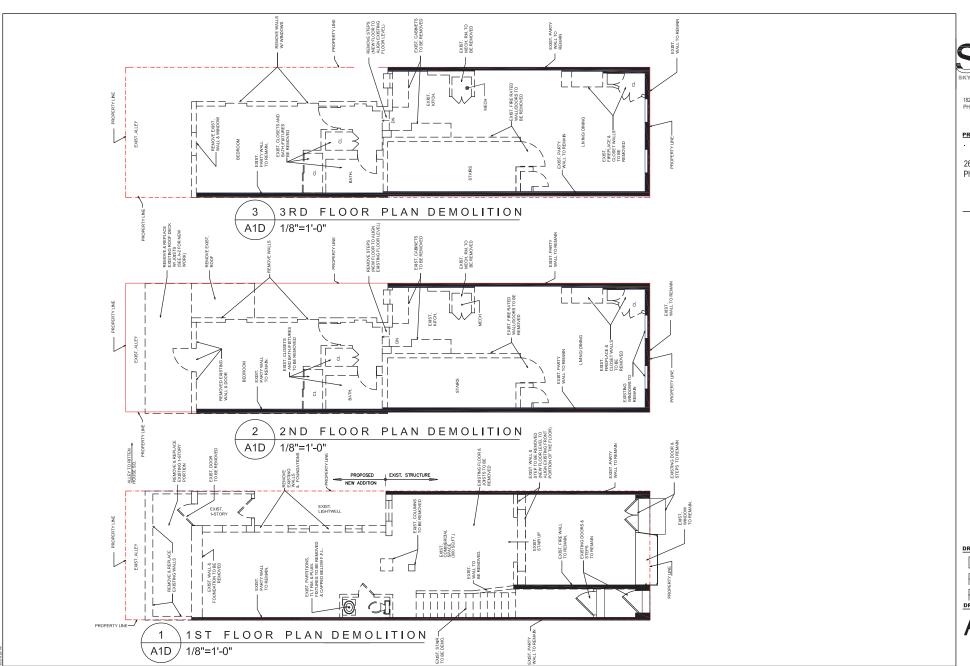

SKY DESIGN STUDIO
T 610 986 3649
F 215 827 5370
1823 SPRING GADEN ST
PHILADELPHIA, PA 19130
SKY@SKY-OS.COM


PROJECT ADDRESS

260 S. 20th St. Philadelphia, P.A.

DEMO

FLOOR PLANS DRAWING NUMBER

A1D

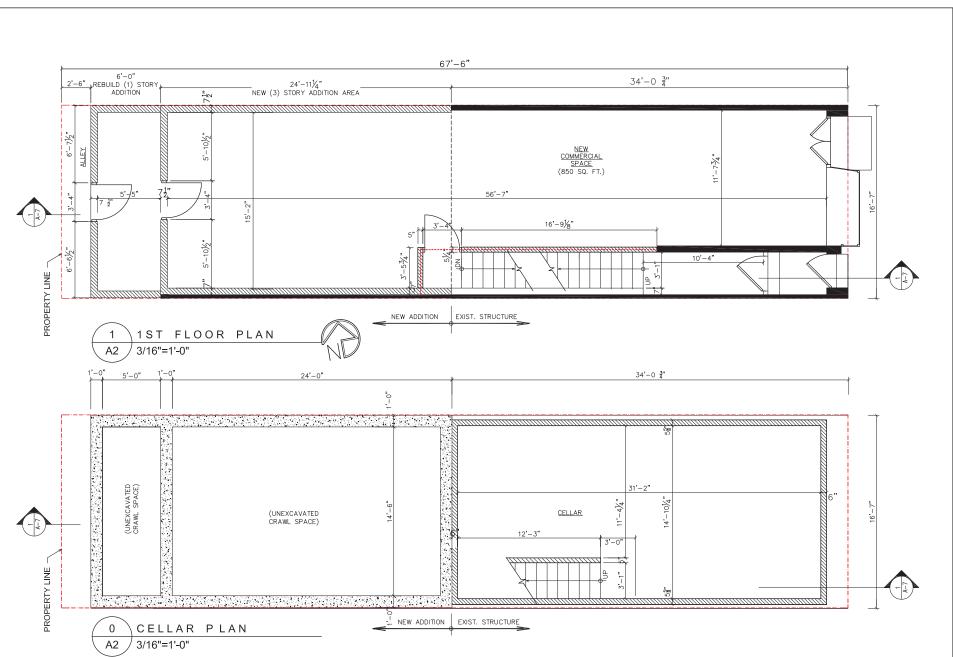


SKY DESIGN STUDIO
T 610 898 3649
F 215 827 5370
1823 SPRING GARDEN ST
PHILADELPHIA, PA 19130
SKY@SKY-DS.COM

PROJECT ADDRESS

260 S. 20th St. Philadelphia, P.A.

DRAWING TITLE

FLOOR PLANS

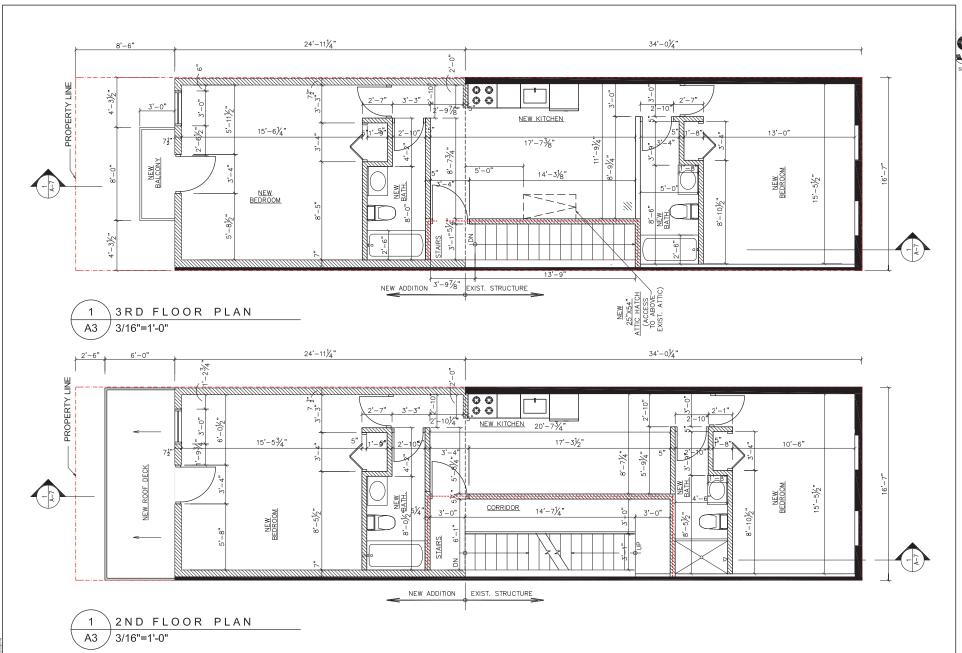


SKY DESIGN STUDIO SKY DESIGN STUDIO 1610 893 3649 F 215 827 5370 1823 SPRING GARDEN ST PHLADELPHIA, PA 19130 SKY@SKY-DS.COM

PROJECT ADDRESS

260 S. 20th St. Philadelphia, P.A.

DRAWING TITLE

FLOOR PLANS

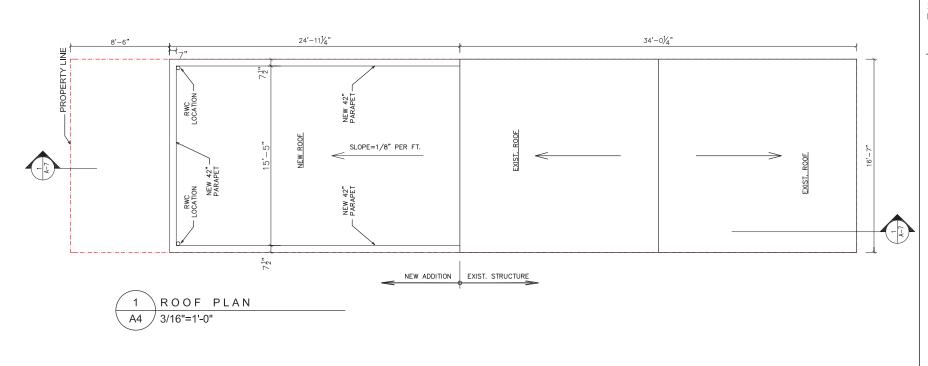


T 610 896 3649 F 215 827 5370 1823 SPRING GARDEN ST PHILADELPHIA, PA 19130 SKY@SKY-DS.COM

PROJECT ADDRESS

260 S. 20th St. Philadelphia, P.A.

DRAWING TITLE

ROOF PLAN

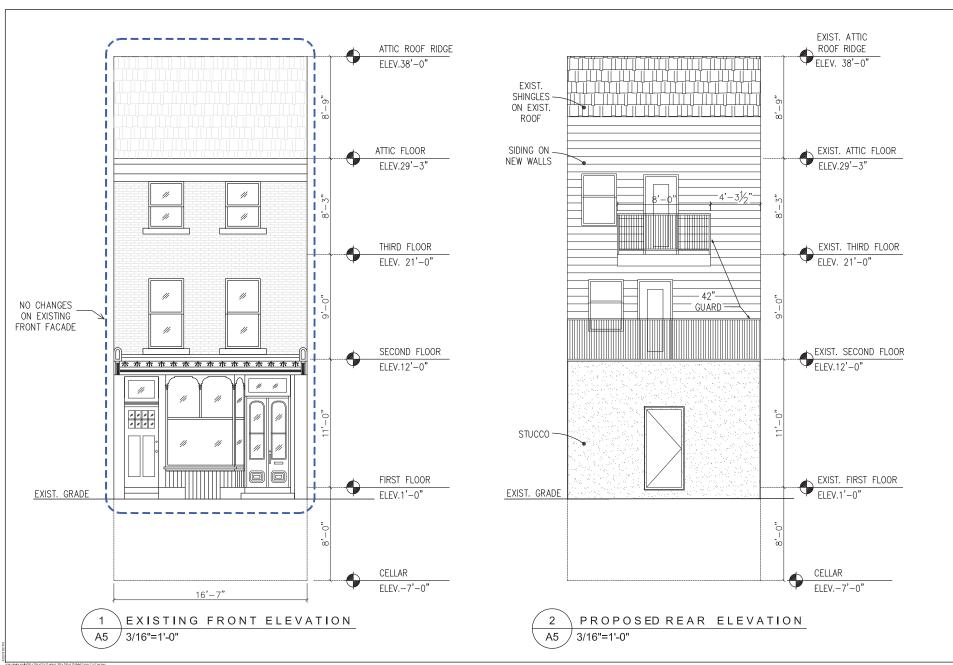

SKY DESIGN STUDIO


1610 886 3649
F 215 827 5370
1823 SPRING GARGEN ST
PHILADELPHIA, PA 19130
SKY@SKY-OS.COM


PROJECT ADDRESS

260 S. 20th St. Philadelphia, P.A.

DRAWING TITLE

& REAR ELEVATIONS

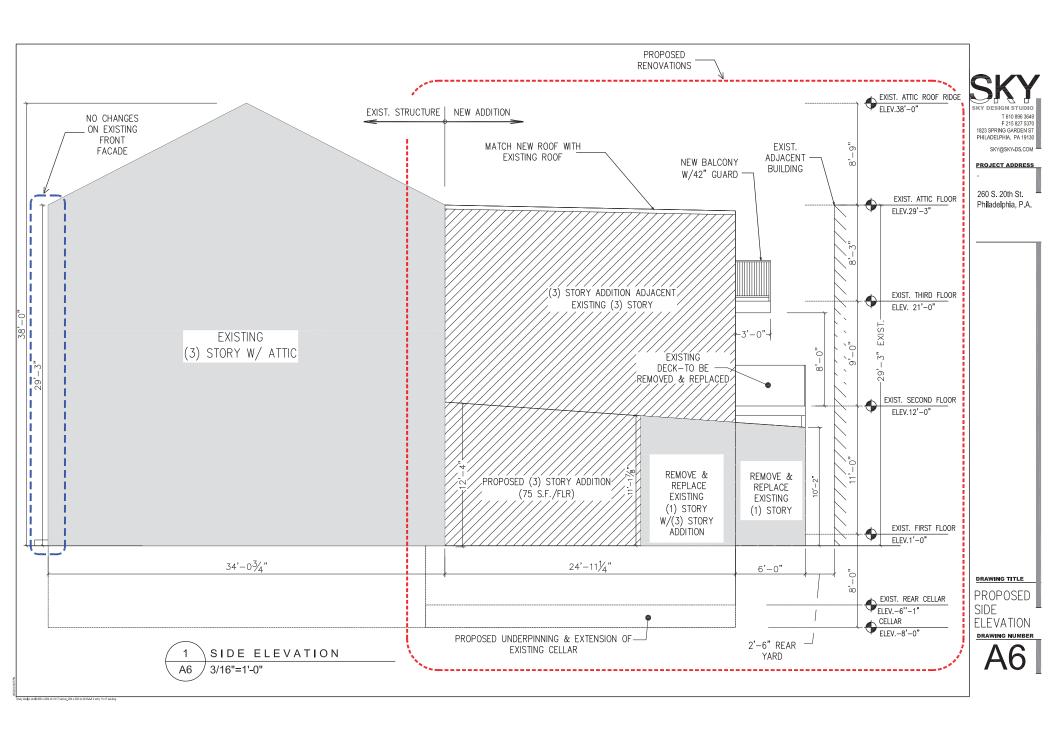

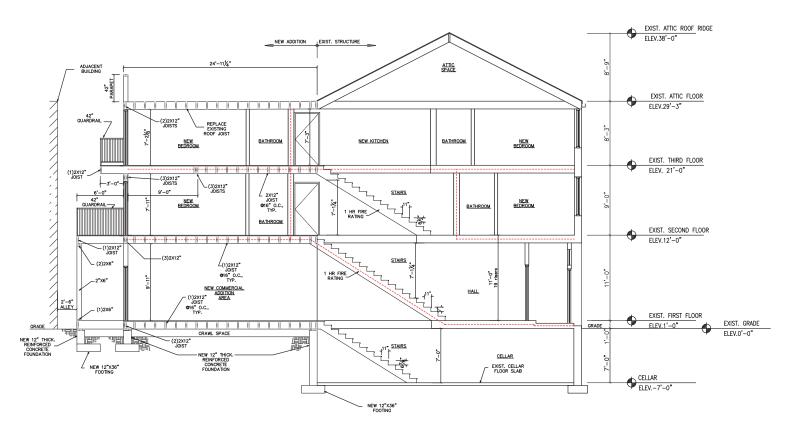

LONGITUDINAL SECTION SCALE: 3/16"=1'-0"


F 215 827 5370 1823 SPRING GARDEN ST PHILADELPHIA, PA 19130 SKY@SKY-DS.COM


PROJECT ADDRESS


260 S. 20th St. Philadelphia, P.A.

DRAWING TITLE

BUILDING SECTION

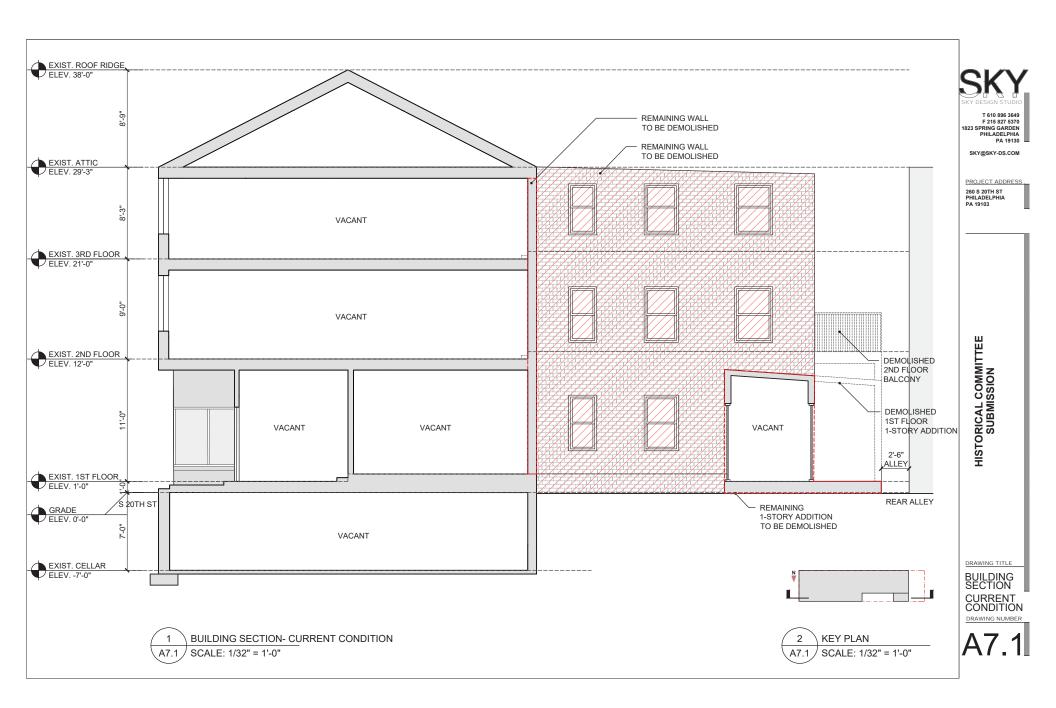

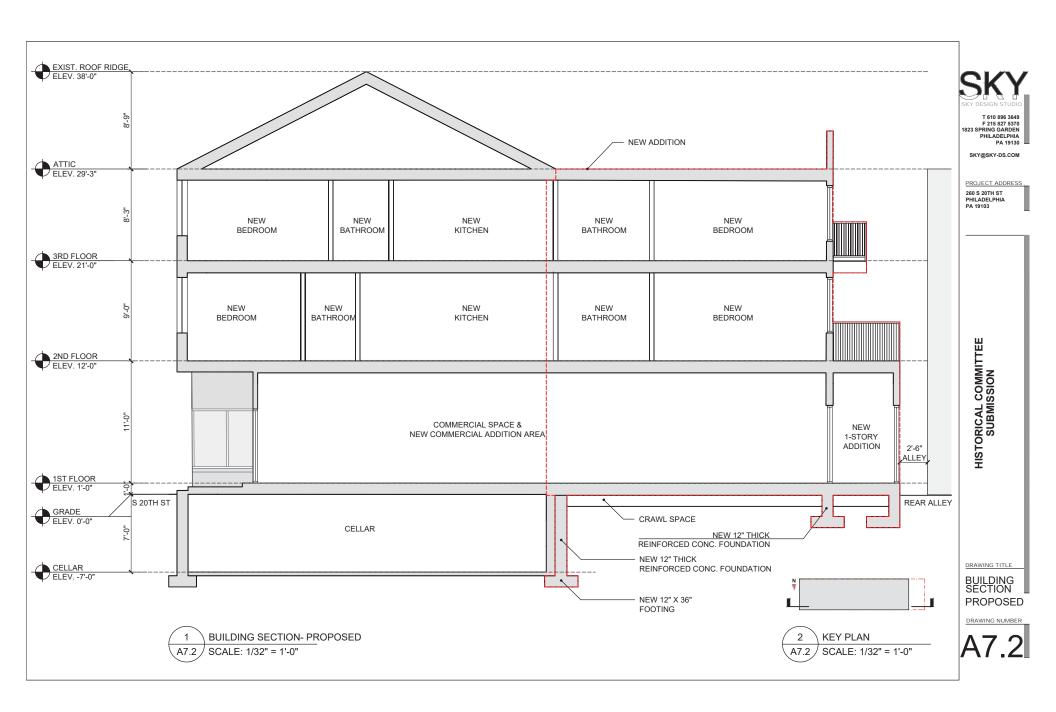

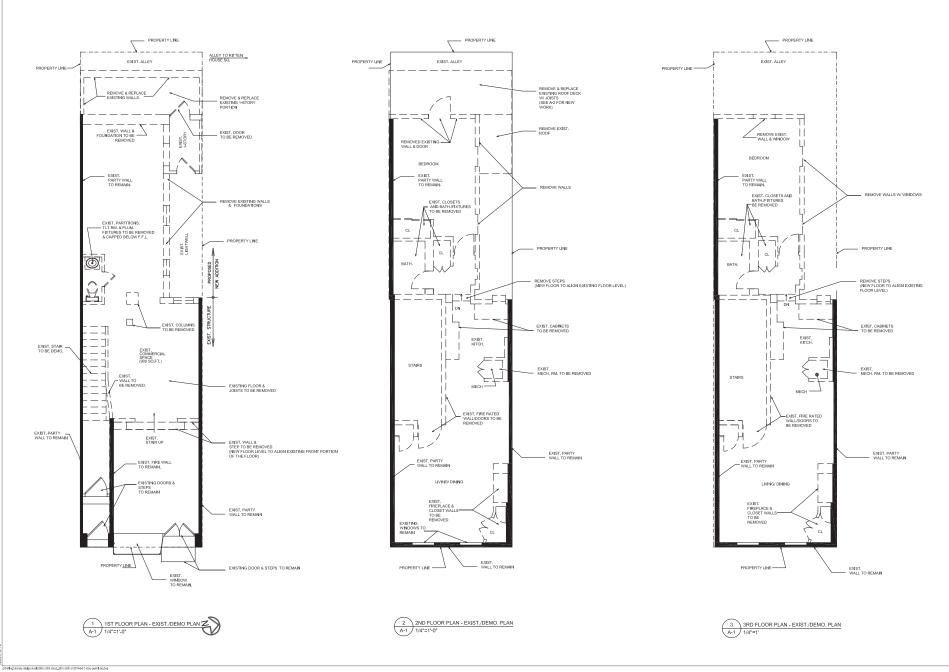

F 215 827 5370 1823 SPRING GARDEN ST PHILADELPHIA, PA 19130 SKY@SKY-DS.COM

> PROJECT ADDRESS (3) STORY ADDITION

260 S. 20TH STREET PHILADEPHIA, PA

OWNER

SU BIN JIAN BO MENG LIN 2524 S. HANCOK ST Philadelphia, PA 19148

CONSULTANT

STRUCTURAL ENGINEER
JDM ENGINEERING LLC
815 RT 54
WILLIAMSTOWN, NJ 08094
856-264-3851
MIKECMOTA@GMAIL.COM

SUBMISSION BUILDING PERMIT 04/05/19

GENERAL NOTE


CHERAL CONTINUOUS IS SEPONBLE FOR CHERAL CONTINUOUS IS SEPONBLE FOR CHERAL CHERAL PRICE TO A CONTINUOUS PRICE OF CHERAL C

SEAL



DRAWING TITLE

EXISTING/ DEMOLITION FLOOR PLANS

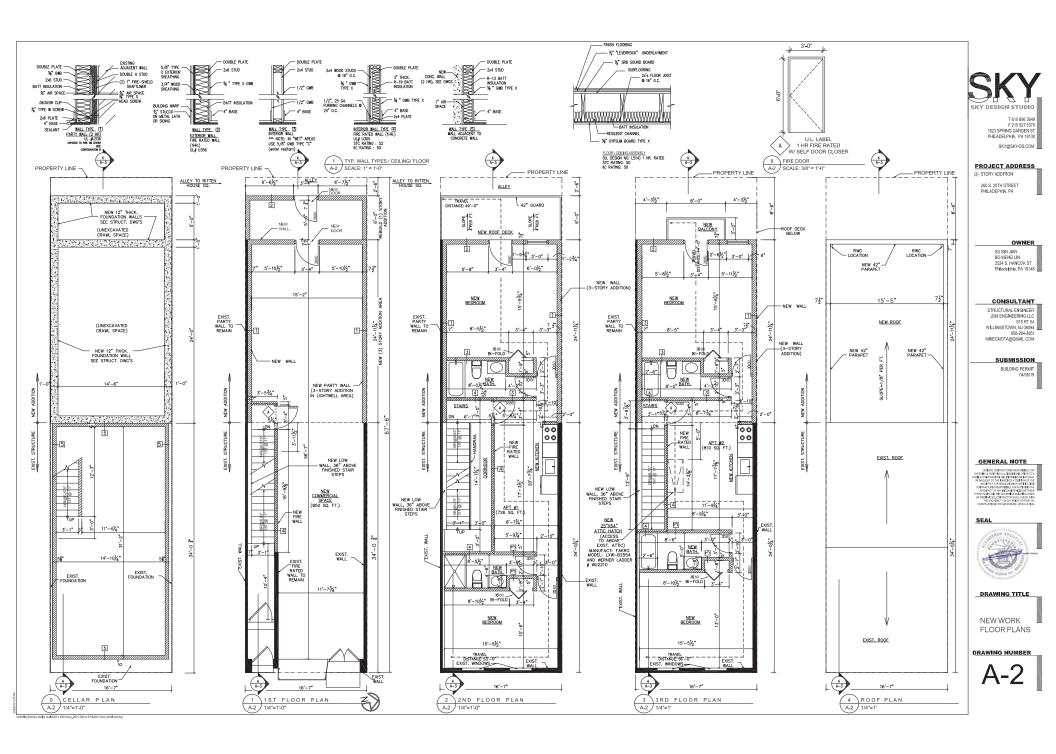

GENERAL CONSTRUCTION NOTES:

- 1. ALL BEDROOM WINDOWS SHALL HAVE THE FOLLOWING:
- A. SILL HEIGHT NOT TO EXCEED 44" A.F.F. B. MINIMUM NET CLEAR OPENING OF 5.7 SF SECOND FLOOR; 5.0 SF GRAD

2. ROOF TO HAVE BATT INSULATION MINIMUM R-38, ALL EXTERIOR WALLS TO HAVE BATT INSULATION MINIMUM R15. FLOORS OVER UNHEATED SPACES SHALL BE R-19.

- 3. ALL EXTERIOR JOINTS AND OPENINGS IN THE EXTERIOR ENVELOPE SHALL BE CAULKED, ASKETED, WEATHER-STRIPPED OR OTHERWISE SEALED.
- 4. MEDICINE CABINETS SHALL BE INSTALLED WITH TOP AT 72" A.F.F.
- 5. PROVIDE CORROSION RESISTANT FLASH AT ALL EXTERIOR WINDOW AND DOOR HEADS. PROVIDE APPROPRIATE FLASHING AT ALL ROOF VALLEYS INTERSECTION OF WALL AND ROOF.


MASONRY:

- CONCRETE MASONRY UNITS SHALL BE HOLLOW LOAD BEARING
 UNITS CONFORMING TO ASTM SPECIFICATION C-90 ABOVE GRADE AND C-145 BELOW
 GRADE. UNITS SHALL HAVE AN AVERAGE COMPRESSIVE
 STRENGTH OF NOT LESS THAN 1,000 PSI.
- ALL EXTERIOR BLOCK BELOW FINISHED GRADE SHALL BE FILLED SOLID WITH MORTAR AND REINFORCED AS REQUIRED.
- ANCHORS AND TIES AS SHOWN IN DETAILS SHALL BE ZINC COATED FERROUS METAL CONFORMING TO ASTM SPECIFICATIONS A-163, CLASS B.1, B.2, OR B.3.
- ALL MASONRY VENEER SHALL HAVE CORROSION RESISTANT TIES
 AND ASPHALT IMPREGNATED 15 LB.; BUILDING PAPER BACKING AND
 WEEPS AT THE BASE.
- 5. ALL DIMENSIONS, OPENINGS, CHASES, ETC. SHALL BE VERIFIED AND CONFIRMED IN THE FIELD.


MECHANICAL


- 1. ALL ATTIC AND CRAWL SPACE AREAS WHICH WHICH ARE NOT MECHANICALLY VENTILATED SHALL HAVE SOFFIT VENTS, WALL VENTS OR ROOF VENTS WHICH ARE TO BE KEPT FREE AND OPEN AND WHICH MEET OR EXCEED APPLICABLE COORS.

- AR INFILTRATION RATE OF:
 A. WINDOWS SHALL NOT EXCEED 0.5 CFM PER FOOT OF SASH CRACK.
 SLIDING SLASS DOORS SHALL NOT EXCEED 0.5 CFM PER SQUARE FOOT OF DOOR AREA.
 C. SWINGING DOORS SHALL NOT EXCEED 1.25 CFM PER SQUARE FOOT OF DOOR. AREA.
- 3. DOMESTIC HOT AND COLD WATER PIPING IN EXTERIOR WALLS, CEILINGS AND WITHIN 12° OF EXTERIOR WALLS SHALL BE INSULATED WITH \hat{Z}' THICK JACKETED GLASS FIBER OR \hat{Z}' CLOSED CELL RUBBET.
- 4. BATHROOM AND KITCHEN EXHAUST FANS SHALL PROVIDE 6 AIR CHANGES PER HOUR MINIMUM
- 5. ALL BATHROOM DOORS SHALL BE UNDERCUT 1".
- 6 ALL PLUMBING AND HVAC TO MEET AND/OR TO EXCEED MINIMUM APPLICABLE CODES.
- 7. TUB SHALL HAVE A 24" x 24" ACCESS PANEL (X" PAINTED A/B PLYWOOD.
- 8. ALL HABITABLE AREAS SHALL BE PROVIDED WITH HEAT AND HOT WATER.

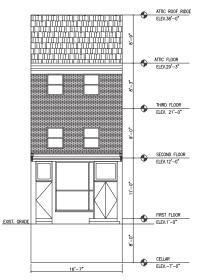



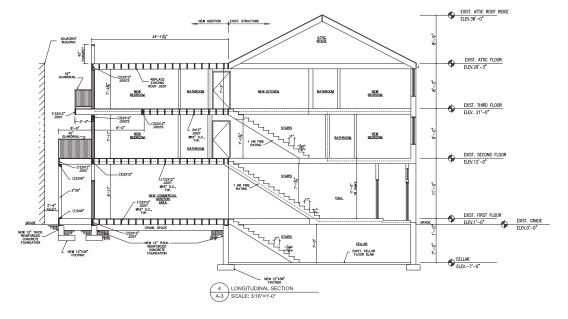

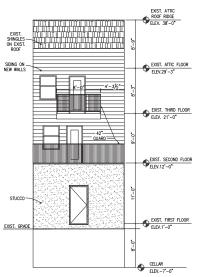

3 REAR ELEVATION A-3 SCALE: 3/32"=1'-0"

1823 SPRING GARDEN ST PHILADELPHIA, PA 19130 SKY@SKY-DS.COM

PROJECT ADDRESS (3) STORY ADDITION

> 260 S 20TH STREET PHILADEPHIA, PA

> > OWNER

SU BIN JIAN BO MENG LIN 2524 S. HANCOK ST Philadelphia, PA 19148

CONSULTANT

STRUCTURAL ENGINEER JDM ENGINEERING LLC 815 RT 54 WILLIAMSTOWN, NJ 08094 MIKECMOTA@GMAIL.COM

> SUBMISSION BUILDING PERMIT 04/05/19

GENERAL NOTE


CONSTRUCTION IS RESPONDED FOR CONSTRUCTION IS RESPONDED FOR CONSTRUCTION IS RESPONDED FOR ALL CONSTRUCTION OF THE PROPERTY OF

SEAL



DRAWING TITLE

ELEVATION & SECTIONS

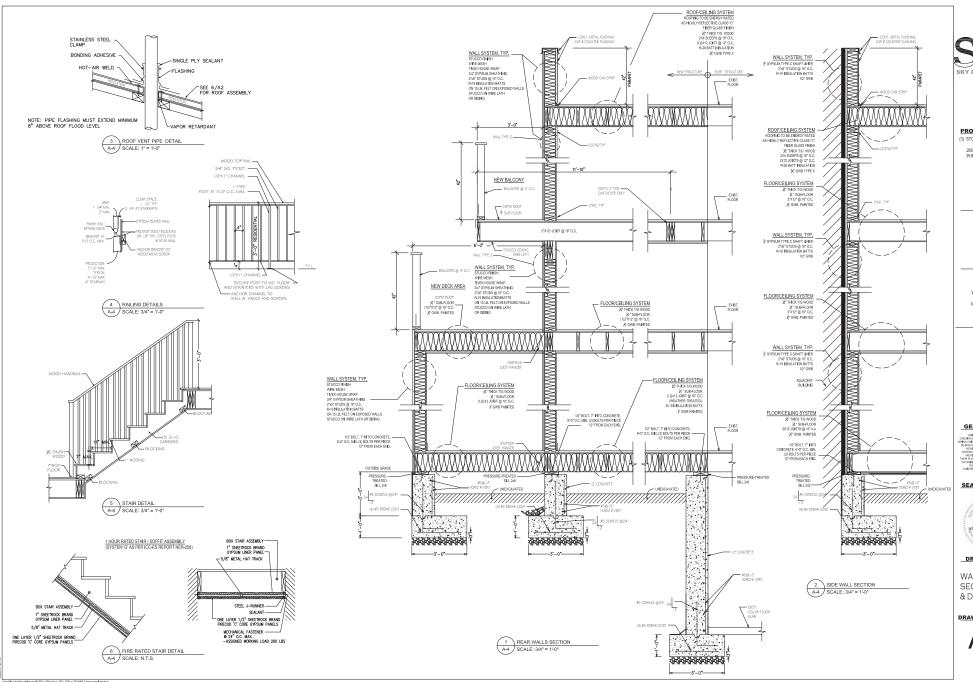

F 215 827 5370 1823 SPRING GARDEN ST PHILADELPHIA, PA 19130 SKY@SKY-DS.COM

PROJECT ADDRESS (3) STORY ADDITION

260 S 20TH STREET

OWNER

SU BIN JIAN BO MENG LIN 2524 S. HANCOK ST Philadelphia, PA 19148

CONSULTANT

STRUCTURAL ENGINEER
JDM ENGINEERING LLC
815 RT 54
WILLIAMSTOWN, NJ 08094
856-264-3851
MIKECMOTA@GMAIL.COM

SUBMISSION BUILDING PERMIT

GENERAL NOTE GENERAL CONTRACTOR IS RESPONSIBLE PA CHECKING & YERRYNDG ALL DIMERBLORS, RACH TO URING CONSTRUCTION, ANY INCOMESTENCIAN RAC


MANA INCE FOR RESCULTIFIED ON INTERFEATION.
CONTINUEND IS RESERVED IN FOR INTERFEATION.
AND THESE PLANS AND ANY GOVERNING BLE LINE OF ANY THEORY BALL THE CONTINUENCE CONTINUENCE OF ANY OF ANY OWNER TO START OF CONTINUENCE TO A CONTINUENCE OF A

SEAL



DRAWING TITLE

WALL SECTIONS & DETAILS

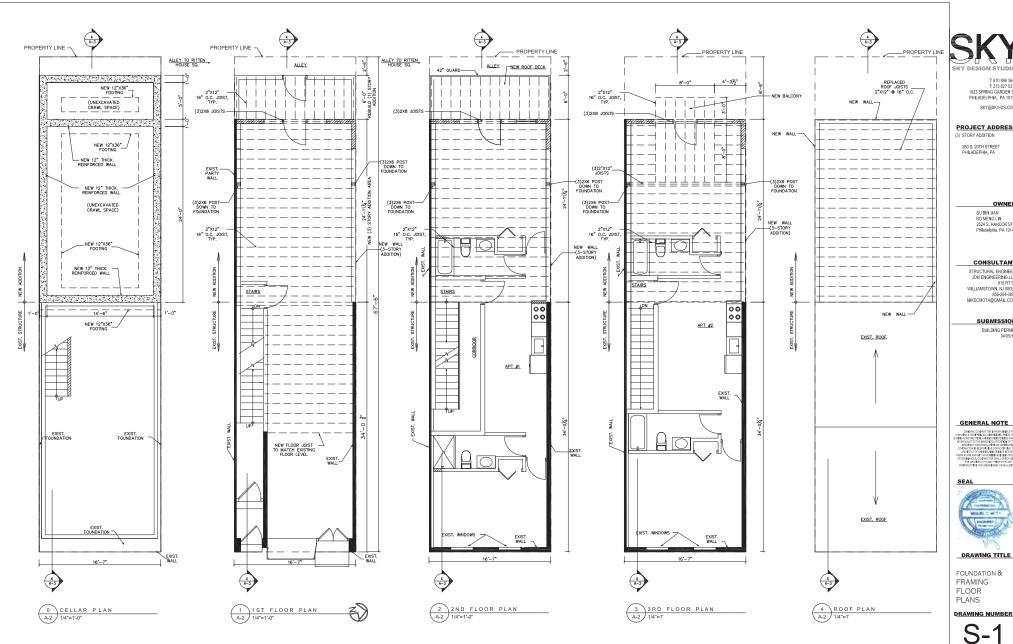

F 215 827 5370 1823 SPRING GARDEN ST PHILADELPHIA, PA 19130 SKY@SKY-DS.COM

PROJECT ADDRESS (3) STORY ADDITION

> OWNER SU BIN JIAN BO MENG LIN 2524 S. HANCOK ST Philadelphia, PA 19148

CONSULTANT STRUCTURAL ENGINEER JDM ENGINEERING LLC 815 RT 54 WILLIAMSTOWN, NJ 08094 856-264-3851 MIKECMOTA@GMAIL.COM


> SUBMISSION BUILDING PERMIT 04/05/19

CEMPRON. CONTROLTOR PRESCRIPPE FOR COMMISSION A MERTINA SER ESPECIAL PROPERTY OF COMMISSION AND COMMISSION AND



DRAWING TITLE FOUNDATION &

FRAMING

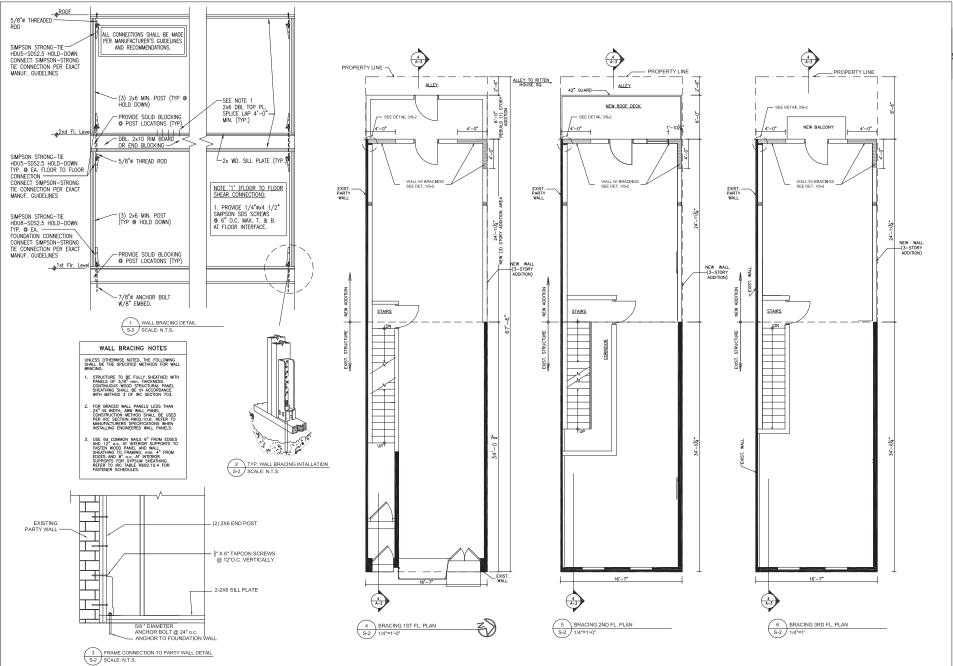

critisal larg jobassiny dealign situal lei 200 s 200 s afrour _200 s 200 s it 2018 4 0 3 atray permit set uting

SKY DESIGN STUDIO

T 610 896 3649 F 215 827 5370 1823 SPRING GARDEN ST PHILADELPHIA, PA 19130 SKY@SKY-DS.COM

PROJECT ADDRESS
(3) STORY ADDITION

260 S. 20TH STREET PHILADEPHIA, PA

OWNER
SU BIN JIAN
BO MENG LIN
2524 S. HANCOK ST.

Philadelphia, PA 19148

CONSULTANT

STRUCTURAL ENGINEER
JDM ENGINEERING LLC
815 RT 54
WILLIAMSTOWN, NJ 08094
858-264-3851
MIKECMOTA@GMAIL.COM

SUBMISSION

BUILDING PERMIT
04/05/19

GENERAL NOTE

OBJECTAL CONTRACTOR B RESPONDED F FOR OBJECTA CONTRACTOR B RESPONDED F FOR OBJECTA CONTRACTOR SHOWN TO A DESIGN OF THE PARK A CHROSTOPIC SHOWN TO A DESIGN OF THE PARK A THE PAR

SEAL



DRAWING IIILE

STRUCTURAL FLOOR PLANS & DETAILS

DRAWING NUMBER

S-2